ADDENDUM <u>No. 3</u>

RFP NO.: 616-008

PROJECT TITLE: Physical Education Building Exterior Renovations Germantown Campus

SUBMISSION DUE DATE AND TIME: By 3:00 PM on March 1, 2016

MONTGOMERY COMMUNITY COLLEGE Procurement Office 900 Hungerford Drive Room 110 Rockville, Maryland 20850

THIS ADDENDUM IS FOR THE FOLLOWING PURPOSES:

Item 3-1: Changes were made to the Construction Documents in response to architectural life safety and electrical review comments received from the Montgomery County Department of Permitting Services (MCDPS). Revised drawings are being reissued in their entirety in response to these comments and are attached to this addendum. Revisions are clouded, noted as "Permit Response Set" and dated 2/22/2016 in the title block on each sheet accordingly.

Index of Attachments to Addendum No. 3

Specification Sections or portions reissued in entirety: NONE

Drawings reissued in entirety:

- 1. G001 Cover Sheet
- 2. G002 SITE PLAN AND GENERAL NOTES
- 3. C100 SITE PLAN
- 4. AD100 FIRST FLOOR DEMOLITION PLAN
- 5. AD110 OVERALL ROOF DEMOLITION PLAN
- 6. AD201 DEMOLITION ELEVATIONS
- 7. AD202 DEMOLITION ELEVATIONS
- 8. AD203 DEMOLITION ELEVATIONS
- 9. AD204 DEMOLITION ELEVATIONS
- 10. AD205 DEMOLITION ELEVATIONS
- 11. AD206 DEMOLITION ELEVATIONS
- 12. A100 OVERALL FIRST FLOOR PLAN
- 13. A101 PARTIAL FIRST FLOOR PLAN
- 14. A102 PARTIAL FIRST FLOOR PLAN
- 15. A103 PARTIAL FIRST FLOOR PLAN
- 16. A110 OVERALL ROOF PLAN

- 17. A111 PARTIAL ROOF PLAN
- 18. A112 PARTIAL ROOF PLAN
- 19. A113 PARTIAL ROOF PLAN
- 20. A201 ELEVATIONS
- 21. A202 ELEVATIONS
- 22. A203 ELEVATIONS
- 23. A204 ELEVATIONS
- 24. A205 ELEVATIONS
- 25. A206 ELEVATIONS
- 26. A300 BUILDING SECTIONS
- 27. A301 BUILDING SECTIONS
- 28. A400 WALL SECTIONS
- 29. A401 WALL SECTIONS
- 30. A402 WALL SECTIONS
- 31. A403 WALL SECTIONS
- 32. A404 WALL SECTIONS
- 33. A405 WALL SECTIONS
- 34. A406 WALL SECTIONS
- 35. A407 WALL SECTIONS
- 36. A408 WALL SECTIONS
- 37. A500 TYPICAL MASONRY AND FLASHING DETAILS
- 38. A510 EIFS DETAILS
- 39. A520 SOFFIT DETAILS
- 40. A530 LOW-SLOPE ROOFING DETAILS
- 41. A531 STEEP-SLOPE ROOFING DETAIL
- 42. A600 FENESTRATION ELEVATIONS
- 43. A610 FENESTRATION DETAILS
- 44. A611 FENESTRATION DETAILS
- 45. S301 DETAILS
- 46. E101 PARTIAL FIRST FLOOR PLAN AREA 'A' ELECTRICAL DEMOLITION
- 47. E102 PARTIAL FIRST FLOOR PLAN AREA 'B' ELECTRICAL DEMOLITION
- 48. E201 PARTIAL FIRST FLOOR PLAN AREA 'A' ELECTRICAL NEW WORK
- 49. E202 PARTIAL FIRST FLOOR PLAN AREA 'B' ELECTRICAL NEW WORK

Sketches: None

Items issued for informational purposes:

Architectural Life Safety Cover Letter dated 22 February 2016 Electrical Cover Letter dated 22 February 2016

END OF ADDENDUM NO. 3

Please **SIGN** below to acknowledge receipt of the Addendum and include it in the **TECHNICAL PROPOSAL SUBMISSION envelope**. NOTE: ACKNOWLEDGEMENT OF RECEIPT OF ADDENDUM WILL NOT BE ACCEPTED BY FACSIMILE OR E-MAIL.

DATE: February 22, 2016

PURCHASING MANAGER: Yu (Judy) Zhu

Applicant's Signature

Company

Title

Date

Patrick L. Johnson, CPPB Director of Procurement

22 February 2016



Department of Permitting Services Montgomery County 255 Rockville Pike, 2nd Floor Rockville, MD 20850

Project 150049.01 – Physical Education (PG) Building Exterior Renovations, Architectural/Life Safety Permit Review, Montgomery College (MC), Germantown, MD (Permit #740477)

Dear Ms. Dyer:

This letter is in response to Montgomery County Department of Permitting Services' (MCDPS) temporary suspension of Application for Permit No. 740477, including Architectural/Life Safety review comments prepared by Ms. Stacy Dyer dated 7 January 2016 (we attach a copy of these review comments to this letter for reference).

Our response consists of this letter, which contains written responses to the review comments detailing how each comment has been addressed; and two revised sets of the drawings with changes from the previous drawings clouded.

Our responses to the Architectural/Life Safety comments prepared by Ms. Dyer include the following:

- Comment #1 (G002): We revised the Occupancy Group to A-3 (Assembly Group) in Existing Building Information Note 2 per IBC 303.4. See revised Existing Building Information Note 2 on Sheet G002.
- Comment #2 (G002): We revised the building height to reflect the number of stories (one story with double-heighted space) and no basement in Existing Building Information Note
 See revised Existing Building Information Note 4 on Sheet G002.
- Comment #3 (G002): We added NFPA 1 (2012), International Fire Code (IFC) 2012, 2010 ADA Standards for Accessible Design, and NFPA 241 to Applicable Building Code Note 1. See revised Applicable Building Code Note 1 on Sheet G002.
- Comment #4 (AD100): We added a "General Notes" and "Building/Sequence of Work" section to indicate the renovation will be done in phases based on when the building will be unoccupied, partially occupied, and fully occupied during construction. We added General Note 3 to indicate the automatic sprinkler system and fire alarm system will remain operational during the renovation. See General Notes 1, 2, and 3, and the Building/Sequence of Work on Sheet AD100.
- Comment #5 (G002): We added Notes 11, 12, 13, 14, 15, and 16 to Staging, Protection and Site Safety Requirements on Sheet G002 that say the following, respectively:

Montgomery County – Permit #740477 Department of Permitting Services

• Where the building is protected by fire protection systems, such systems shall be maintained operational at all times during alteration as required per NFPA 1, 16.4.4.1.

- 2 -

- Where alteration requires modification of a portion of the fire protection system, the remainder of the system shall be kept in service and the fire department shall be notified as required per NFPA 1, 16.4.4.2.
- When it is necessary to shut down the system, the AHJ shall have the authority to require alternate measures of protection until the system is returned to service as required per NFPA 1, 16.4.4.3.
- The fire department shall be notified when the system is shut down and when the system is returned to service as required per NFPA 1, 16.4.4.4.
- All required exit components shall be maintained in accordance with this Code as deemed necessary by the AHJ as required per NFPA 1, 16.4.4.5.
- Fire-resistive assemblies and construction shall be maintained as required per NFPA 1, 16.4.4.6.
- Comment #6 (A600): We eliminated the "Add-Alternates" for replacing the existing main entrance doors (Doors 1 and 2 on the Door Schedule on Sheet A600) along with the surrounding frames. The current scope includes reusing the existing main entrance doors in new frames.
- Comment #7 (AD100, A101, A102, A103, A600): We added the following notes to the referenced drawings to indicate exterior exit doors will have the panic hardware required per IBC Sections 1010.1.9.3, 1010.1.9.9, and 1010.1.10, as appropriate.
 - Sheet AD100: Added Note 7 to the General Scope of Work This Drawing, saying openings at removed exterior doors serving as exit doors must be maintained for appropriate egress, replacement doors must have appropriate panic hardware in accordance with IBC Section 1010.1.9.9 and Section 1010.1.10, as shown on A600.
 - Sheets A101, A102, A103: Added Note 22 to the General Scope of Work This Drawing, saying openings at removed exterior doors serving as exit doors must be maintained for appropriate egress, replacement doors must have appropriate panic hardware in accordance with IBC Section 1010.1.9.9 and Section 1010.1.10, as shown on A600.
 - Sheet A600: Added a column labeled "Emergency Exit" to the Door Schedule indicating which doors also serve as emergency exits. The Door Schedule column labeled "Hardware Set" indicates the proposed hardware set included in the Door Hardware Specification (Section 08 7100) for each door, including the exit doors.
- Comment #8 (AD100): We added General Note 1 on Sheet AD100 regarding exterior lighting at exit doors indicating the following:
 - "Floors and other walking surfaces within an exit and within the portions of the exit access and exit discharge, designated in IBC Section 7.8.1.1 shall be illuminated as follows:

Montgomery County – Permit #740477 Department of Permitting Services

- During conditions of stair use, the minimum illumination for new stairs shall be at least 10 ft-candle (108 lux), measured at the walking surfaces.
- The minimum illumination for floors and walking surfaces, other than new stairs during conditions of stair use, shall be to values of at least 1 ft-candle (10.8 lux), measured at the floor.
- In assembly occupancies, the illumination of the walking surfaces of exit access shall be at least 0.2 ft-candle (2.2 lux) during periods of performances or projections involving directed light.
- The minimum illumination requirements shall not apply where operations or processes require low lighting levels per NFPA 101, 7.8.1.3.
- Comment #9 (A102, A103, A201, A202, A204, A206): We added a table on Sheet G002 that indicates the proposed R-values or equivalent U-values for the new enclosure systems, including the exterior walls, curtain walls, doors, and roofs, showing these components comply with the prescriptive requirements included in Table C402.4 of the 2015 IECC code. We note the new systems will have the following R-values or equivalent U-values:

Building Envelope Assembly	Required R-Value/U-Value	Proposed R-value/U-Value
Steep-Slope Roofs	R – 38	R – 39
Low-Slope Roofs	R – 30ci	R – 30ci
Mass Walls (CMU with EIFS)	R – 9.5ci	R – 15ci
Mass Walls (CMU with Brick)	R – 9.5ci	R 16ci
Metal Framed Walls	U - 0.064	U – 0.062
Hollow Metal Doors	U – 0.061	U – 0.10
Fixed Fenestration (Curtain Wall	U – 0.38	U - 0.33
Operable Fenestration (Curtain Wall Vents)	U – 0.45	U – 0.44
Entrance Doors	U – 0.77	U - 0.66

We expect that the responses above, in combination with the updated drawings, satisfactorily address the comments provided by you. However, please let us know if we can provide further clarification to any of these comments.

Sincerely yours,

David S. Slick, P.E. Associate Principal MD License No. 15484 I:\DC\Projects\2015\150049.01-PGRC\WP\010DSSlick-L-150049.01.mlp.do

Encls.

cc: Mr. Kermit Leibensperger (MCDPS) Mr. Eric Koh (MC) Mr. Kevin Redinger (MC) Mr. Ali Fadl (MC)



I hereby certify that these documents were prepared or approved by me, and that I am a duly licensed professional engineer under the laws of the State of Maryland.

License No.



22 February 2016

Department of Permitting Services Montgomery County 255 Rockville Pike, 2nd Floor Rockville, MD 20850

Project 150049 – Physical Education (PG) Building Exterior Renovations, Electrical Permit Review, Montgomery College (MC), Germantown, MD (Permit #740477)

Dear Mr. Leibensperger:

This letter is in response to Montgomery County Department of Permitting Services' (MCDPS) temporary suspension of Application for Permit No. 740477, including Electrical review comments prepared by you dated 21 January 2016 (we attached copies of these review comments to this letter for reference).

Simpson Gumpertz & Heger Inc. (SGH) retained an MEP consultant (Burdette, Koehler, Murphy & Associates – BMKA) to assist us with developing the necessary electrical drawings based on the scope of work shown on our Permit Set drawings dated 20 November 2015 and respond to MCDPS's Electrical permit review comments.

The design team's response consists of this letter and two revised sets of the drawings with changes from the previous drawings clouded.

During a telephone conversation between you and Mr. Phillip Frederick of SGH on 28 January 2016, the scope of this project and your electrical review comments were discussed at length. At the conclusion of the conversation it was agreed that your comments could be satisfied by developing electrical floor plans that clarify the electrical work involved with this project. See attached signed and sealed electrical drawings as requested.

The electrical drawings show the work needed to remove all electrical devices from the exterior walls of the building, extend conduit and wiring (of same type and quantity), and reinstall the conduit and wiring on the inside surface of the exterior wall with the existing devices being reinstalled on the exterior wall in the same location. This work is merely an in-kind removal and re-installation of devices. The only new work included in this project is the addition of a 120V, 20A branch circuit for a power operated door which is shown on Drawing E202.

We expect that the responses above, in combination with the updated drawings, satisfactorily address the comments provided by you. However, please let us know if we can provide further clarification to any of these comments.

Montgomery County – Permit #740477 Department of Permitting Services

Sincerely yours,

Richard A. Miller

Richard A. Miller, P.E. Principal Burdette, Koehler, Murphy & Associates, Inc. MD License No. 20513 I:\DC\Projects\2014\140170.00-COLO\WP\006JDKerr-L-140170.mlp.docx David S. Slick, P.E. Associate Principal Simpson Gumpertz & Heger Inc.

Encls.

cc: Ms. Stacy Dyer (MCDPS) Mr. Eric Koh (MC) Mr. Kevin Redinger (MC) Mr. Ali Fadl (MC)

PHYSICAL EDUCATION BUILDING EXTERIOR RENOVATIONS MONTGOMERY COLLEGE, GERMANTOWN CAMPUS GERMANTOWN, MD




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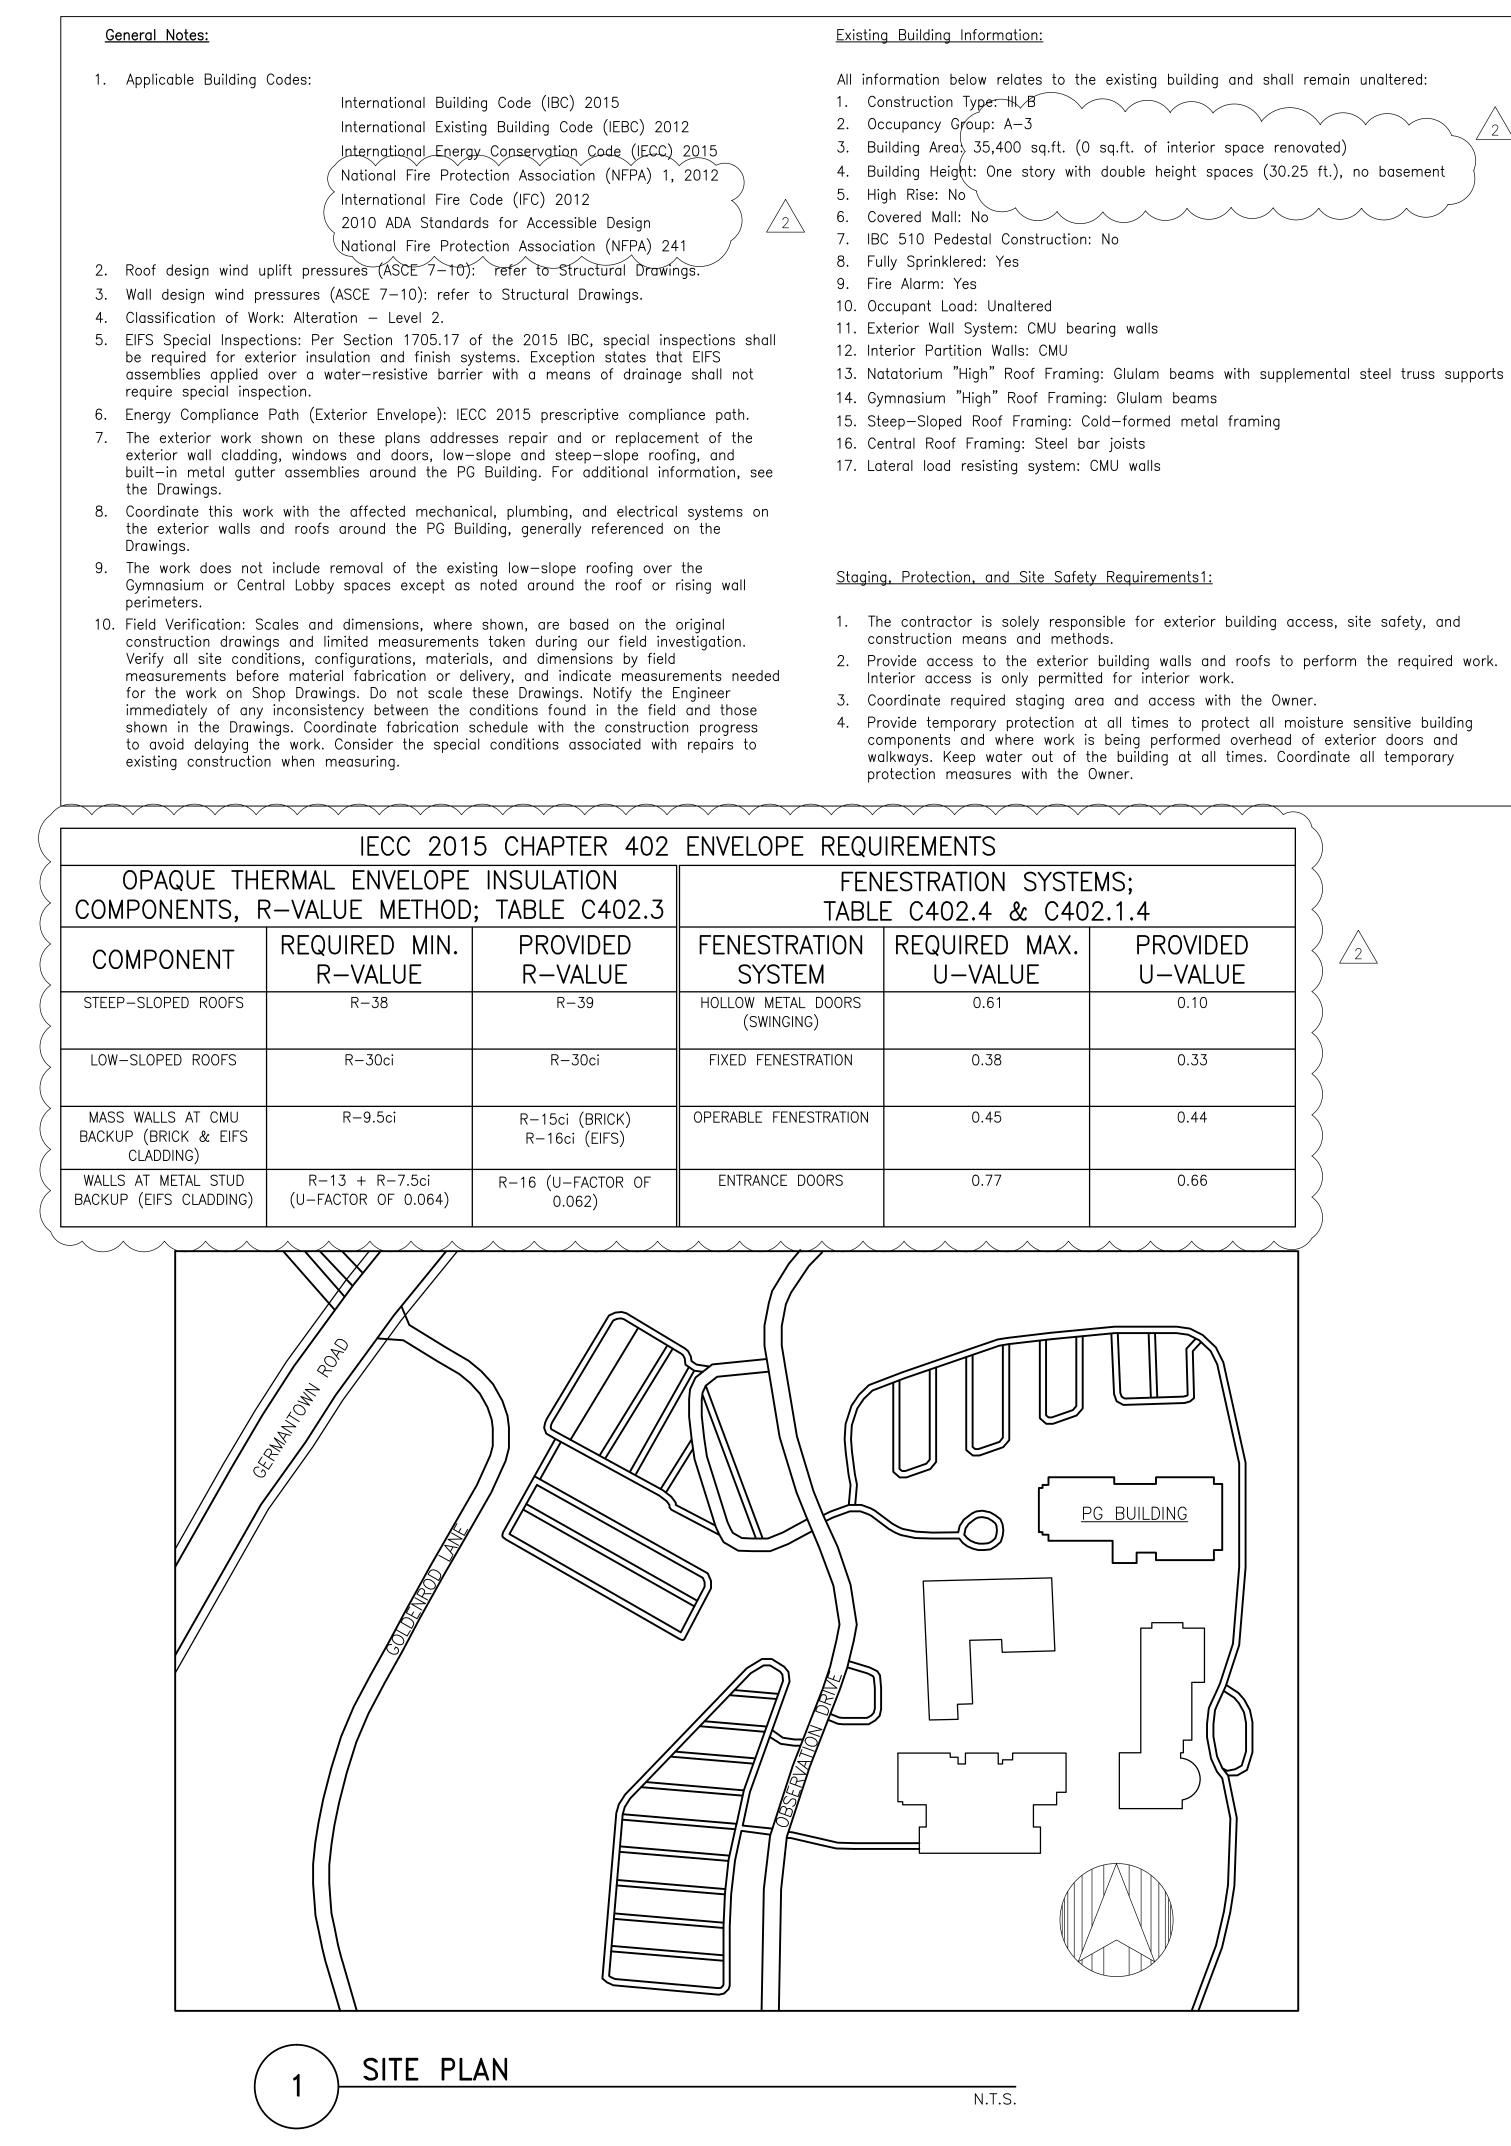
MONTGOMERY COLLEGE GERMANTOWN CAMPUS 20200 OBSERVATION DRIVE GERMANTOWN, MD 20876 PREPARED BY:

SIMPSON GUMPERTZ & HEGER INC. 1828 L STREET NW, SUITE 950 WASHINGTON, DC 20036


		A402	WALL SECTIONS
LIST OF DRAWINGS		A403	WALL SECTIONS
G001	COVER SHEET	A404	WALL SECTIONS
G002	SITE PLAN AND GENERAL NOTES	A405	WALL SECTIONS
C100	SITE PLAN	A406	WALL SECTIONS
AD100	FIRST FLOOR DEMOLITION PLAN	A407	WALL SECTIONS
AD110	ROOF DEMOLITION PLAN	A408	WALL SECTIONS
AD201	DEMOLITION ELEVATIONS	A500	TYPICAL MASONRY AND FLASHING DETAILS
AD202	DEMOLITION ELEVATIONS	A510	EIFS DETAILS
AD203	DEMOLITION ELEVATIONS	A520	SOFFIT DETAILS
AD204	DEMOLITION ELEVATIONS	A530	LOW-SLOPE ROOFING DETAILS
AD205	DEMOLITION ELEVATIONS	A531	STEEP-SLOPE ROOFING DETAILS
AD206	DEMOLITION ELEVATIONS	A600	FENESTRATION ELEVATIONS
A100	OVERALL FIRST FLOOR PLAN	A610	FENESTRATION DETAILS
A101	PARTIAL FIRST FLOOR PLAN	A611	FENESTRATION DETAILS
A102	PARTIAL FIRST FLOOR PLAN	S001	GENERAL NOTES
A103	PARTIAL FIRST FLOOR PLAN	S110	LOW ROOF FRAMING PLAN
A110	OVERALL ROOF PLAN	S111	UPPER ROOF FRAMING PLAN
A111	PARTIAL ROOF PLAN	S300	DETAILS
A112	PARTIAL ROOF PLAN	S301	DETAILS $\frac{1}{2}$
A113	PARTIAL ROOF PLAN	EY001	SECURITY REFERENCE SHEET
A201	ELEVATIONS	EY100	OVERALL FIRST FLOOR PLAN
A202	ELEVATIONS	EY101	SECURITY PARTIAL FIRST FLOOR
A203	ELEVATIONS	EY102	SECURITY PARTIAL FIRST FLOOR
A204	ELEVATIONS	EY103	SECURITY PARTIAL FIRST FLOOR
A205	ELEVATIONS	EY501	SECURITY DETAILS
A206	ELEVATIONS	E001	ELECTRICAL GENERAL NOTES
A300	BUILDING SECTIONS	E101	
A301	BUILDING SECTIONS	E102	
A400	WALL SECTIONS	E201	
A401	WALL SECTIONS	E202	

ENGINEER IN RESPONSIBLE CHARGE: DAVID S. SLICK (MD PE NO. 15484)



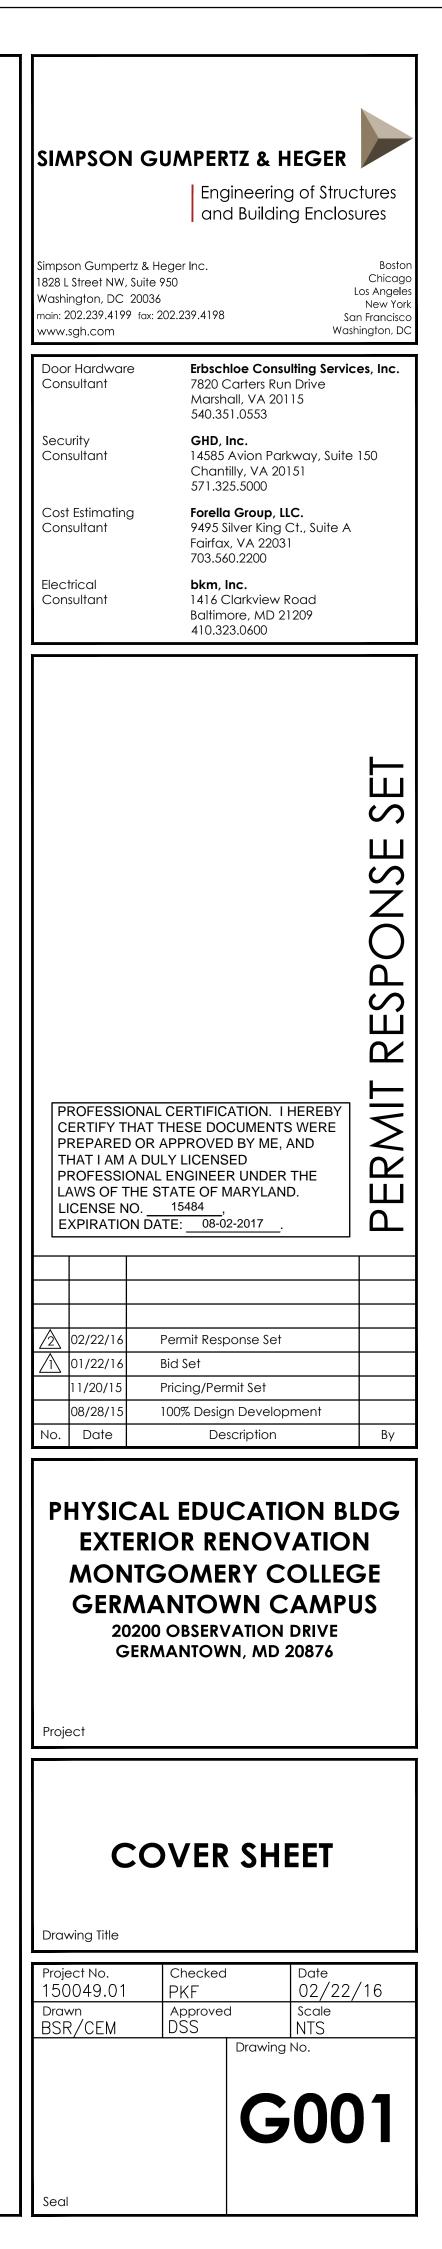

- 5. Maintain safe pedestrian access to publicly trafficked walk areas at all times. Maintain all emergency egress routes, meeting all applicable building codes and regulatory requirements.
- 6. Protect all landscaping from construction activity, including, but not limited to, shrubbery, grass, patios, paving, and walkways. Repair all damage to landscaping at no cost to the Owner.
- 7. Protect all exterior building components newly installed or scheduled to remain, including, but not limited to, windows, masonry, glazing, EIFS, and roofing from construction activity. Repair all damage to building components at no cost to the Owner. Where roof top construction activity and construction traffic is required, provide temporary protection, consisting of $1-\frac{1}{2}$ in. thick extruded polystyrene insulation covered with plywood over completed roof areas and existing—to—remain roof areas. Ballast temporary protection to prevent wind uplift.
- 8. Protect scaffolding and the building against unauthorized access (day and night).
- 9. Provide appropriate covered dumpsters for temporary debris storage during construction activity. Goordinate placement and removal of the dumpsters with the Qwner. 10. Overhead protection.
- >11. Where the building is protected by fire protection systems, such systems shall be
- maintained operational at all times during alteration as required per NFPA 1, 16.4.4.1. 12. Where alteration requires modification of a portion of the fire protection system, the remainder of the system shall be kept in service and the fire department shall by
- notified as required per NFPA 1, 16.4.4.2. 13. When it is necessary to shut down the system, the Authority Having Jurisdiction shall have the authority to require alternative measures of protection until the system is returned to service as required per NFPA 1, 16.4.4.3.
- 14. The fire department shall be notified when the system is shut down and when the
- system is returned to service as required per NFPA 1, 16.4.4.4. 15. All required exit components shall be maintained in accordance with the building code as deemed necessary by the Authority Having Jurisdiction as required per NFPA 1,
- 16.4.4.5. 16. Fire-resistive assemblies and construction shall be maintained as required per NFPA 1
- 16.4.4.6.

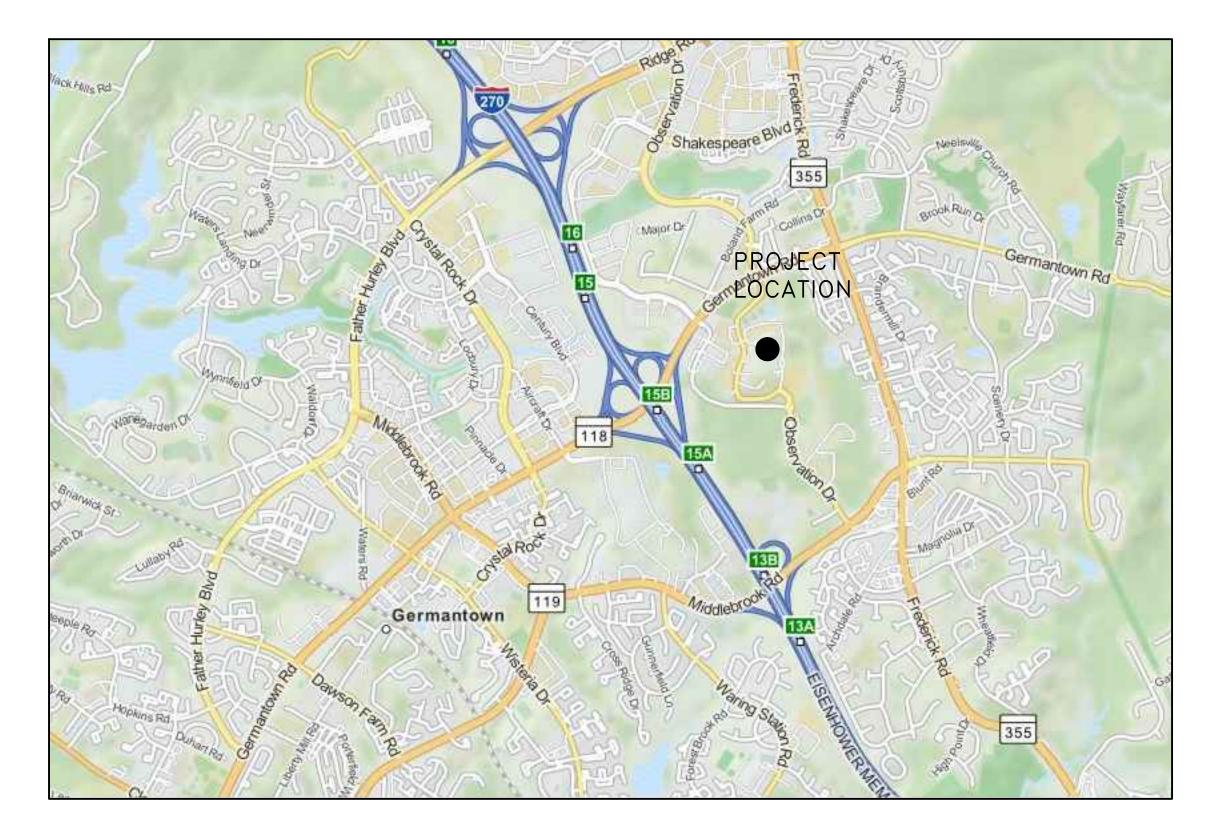

AREA MAP

			-
^ (Proposed Schedule:		
	Proposed Schedule: Natatorium Walls Natatorium Roof (Low–Slope) Natatorium Roof (Steep–Slope) Windows Classroom Walls Around Windows Office Walls Around Windows Gymnasium Walls Gymnasium Roofs Substantial Completion	– July 2016 – August 2016	

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B	rawn SR/CEM	Approve DSS	Drawing	scale NTS No.	2

GENERAL NOTES:

- A. Project site shown is within the property line of the College property; boundary extends along Germantown Rd. on the north side and Frederick Rd. on the east side; refer to G002.
- B. All utility lines and below-grade piping are shown schematically based on existing drawings, dated 23 Nov. 1977. Contractor shall verify the location of all buried elements prior to excavation, including all measures mandated by the local jurisdiction, and take all precautions necessary to protect existing-to-remain elements from the Work.
- C. Unless noted otherwise, all utilities shown are existing to remain and shown for coordination purposes only. D. Notify the Engineer if the existing downleader
- connection to the stormwater management system cannot be reused or is not serviceable.
- E. The extent of excavation shown includes the extent of all lay-back and benching necessary to perform work.


- F. Remove and replace in-kind all sidewalks that extend within the excavation area.
- G. Area of site disturbance, including lay down areas for soil and construction activities: <u>5,374 sq.ft.</u>
- H. Quantity of earth movement and excavation: <u>425 cy.</u>
- I. Area of new impervious landscaping: 0 sq.ft.
- J. Implement all sediment control measures as
- determined by Montgomery County.


-CONSTRUCTION SITE ENTRANCE;

DEPARTMENT ACCESS TO SITE

MAINTAIN CURRENT FIRE

- K. Protect all existing yard inlets L. Remove and dispose of all existing vegetation and wood edging within excavation area, unless noted otherwise.
- angle M. Replant and restore all turf grass damaged or angle
- disturbed as a result of construction activities. N. Provide aluminum edging around footprint of building located 24 in. from face of new cladding. Provide
- new river stone landscaping and filter fabric to match existing and extend from face of building to new edging.

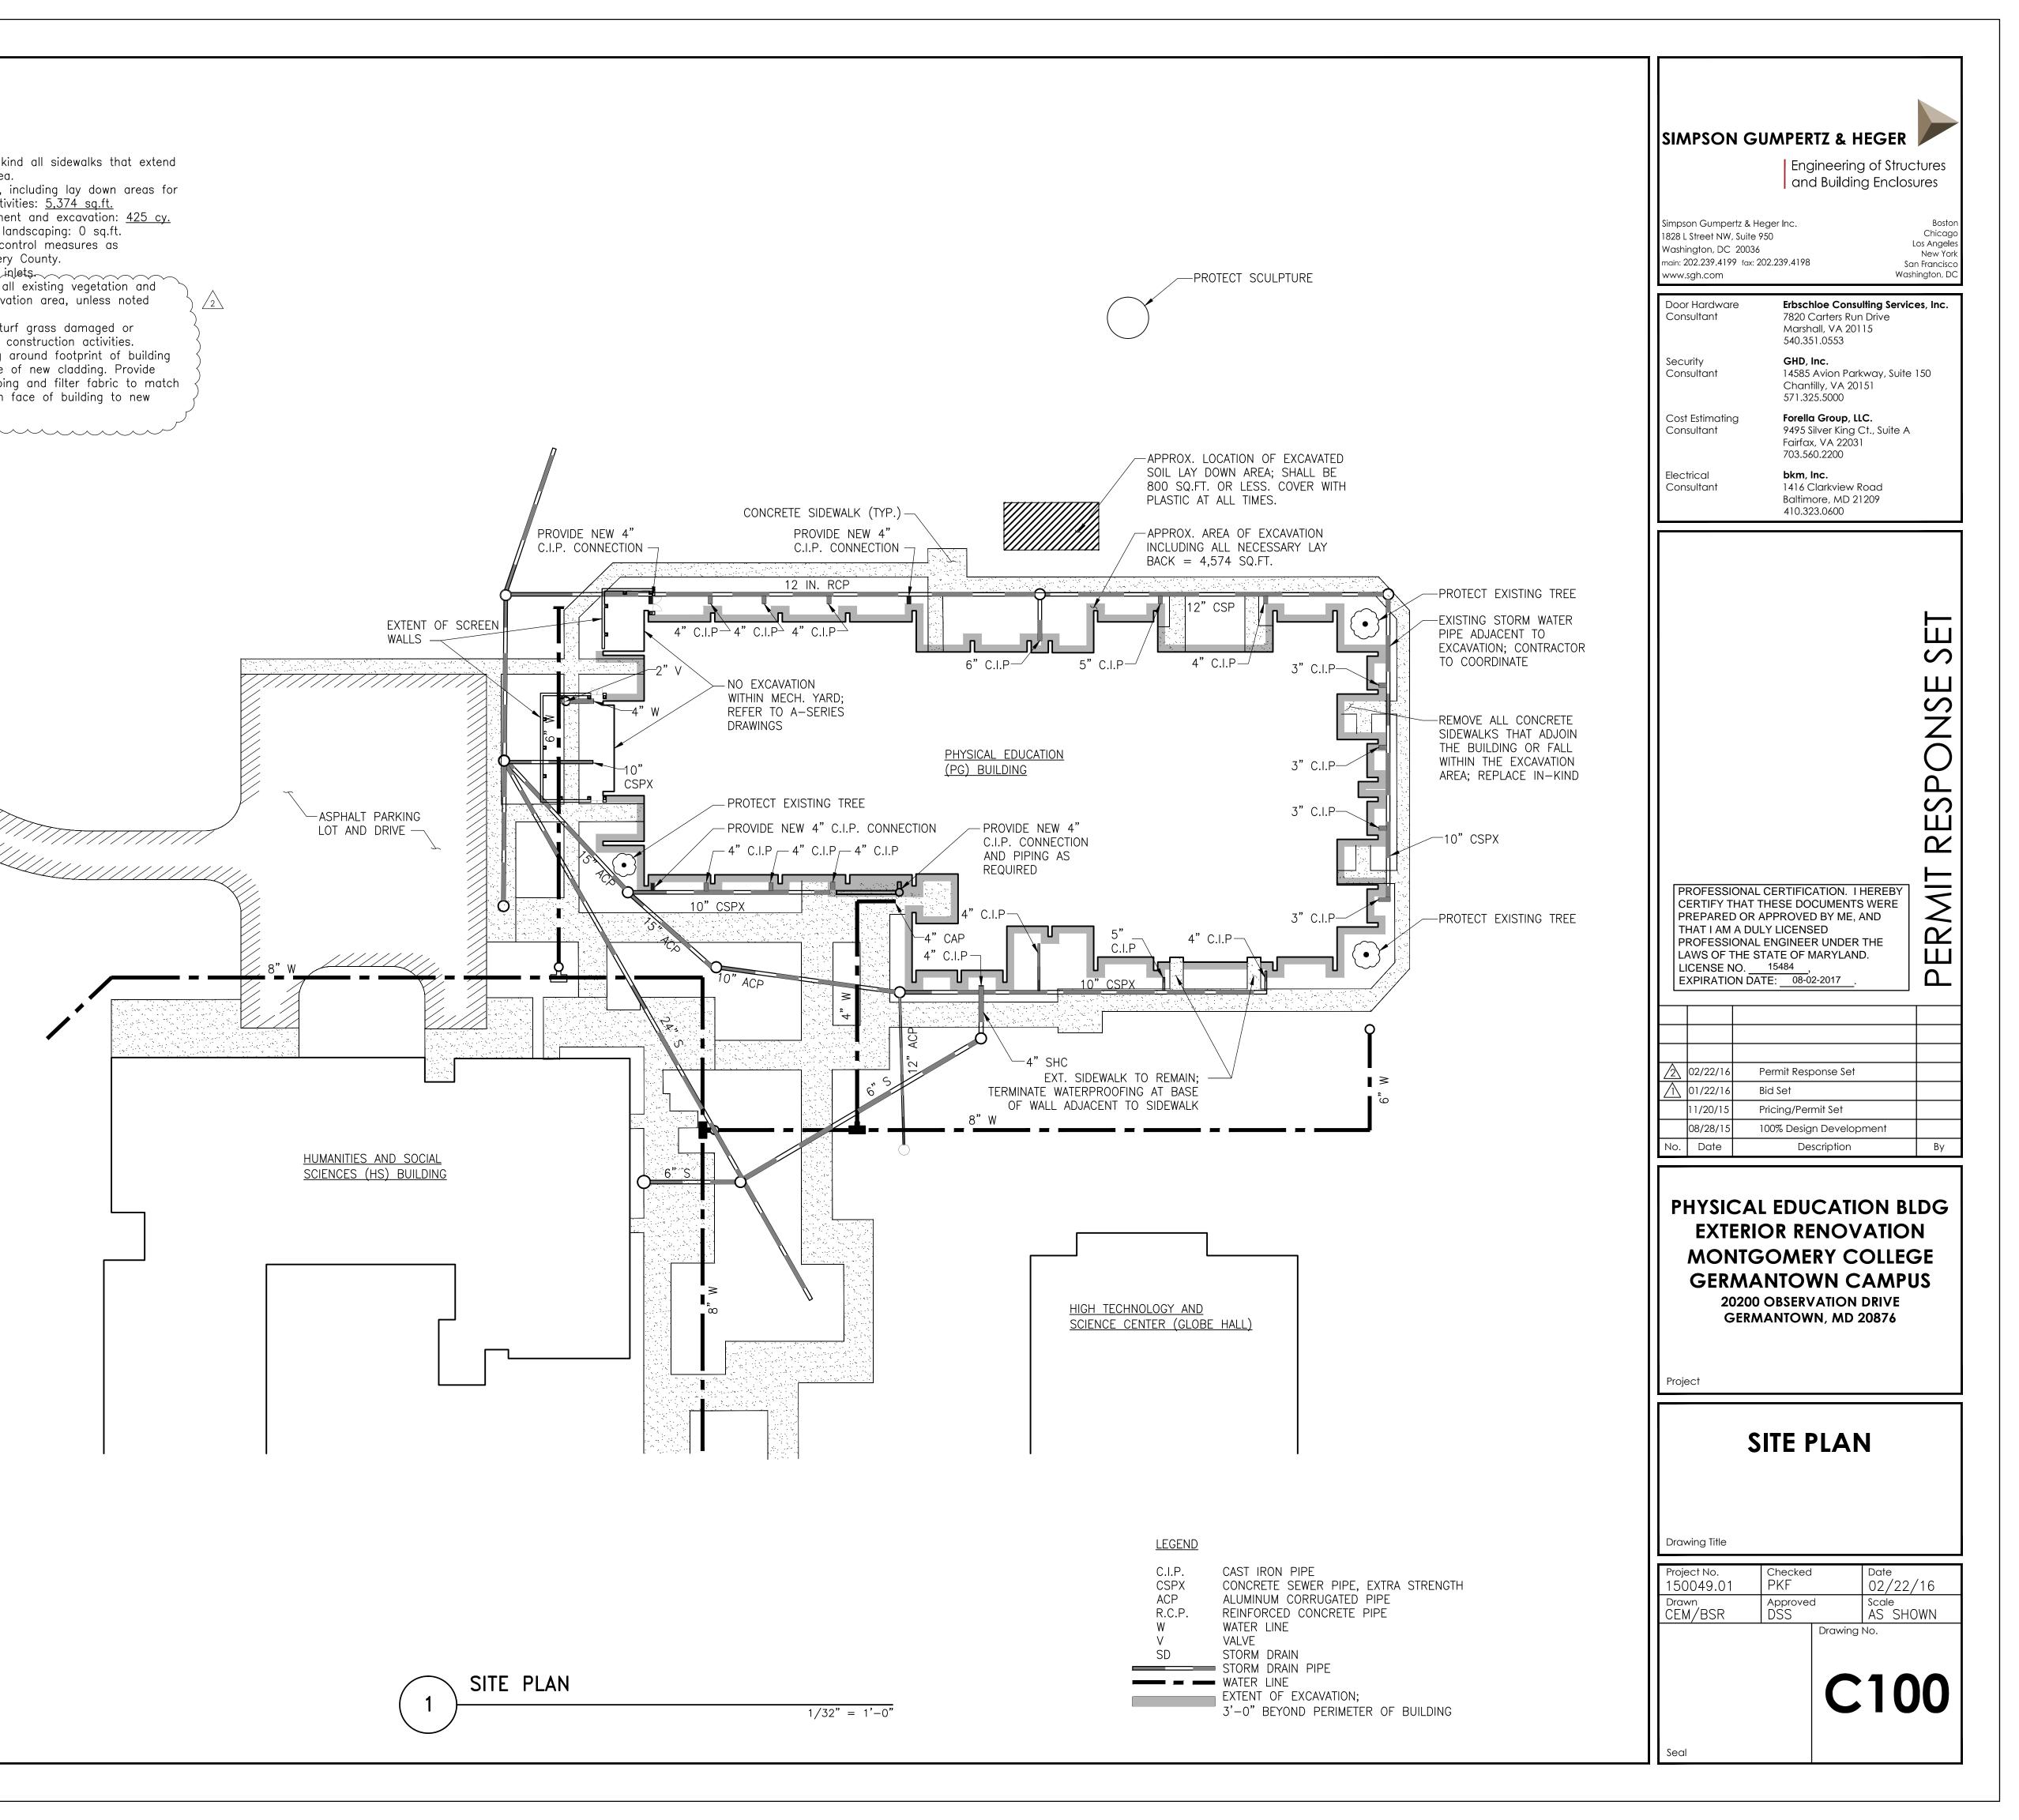

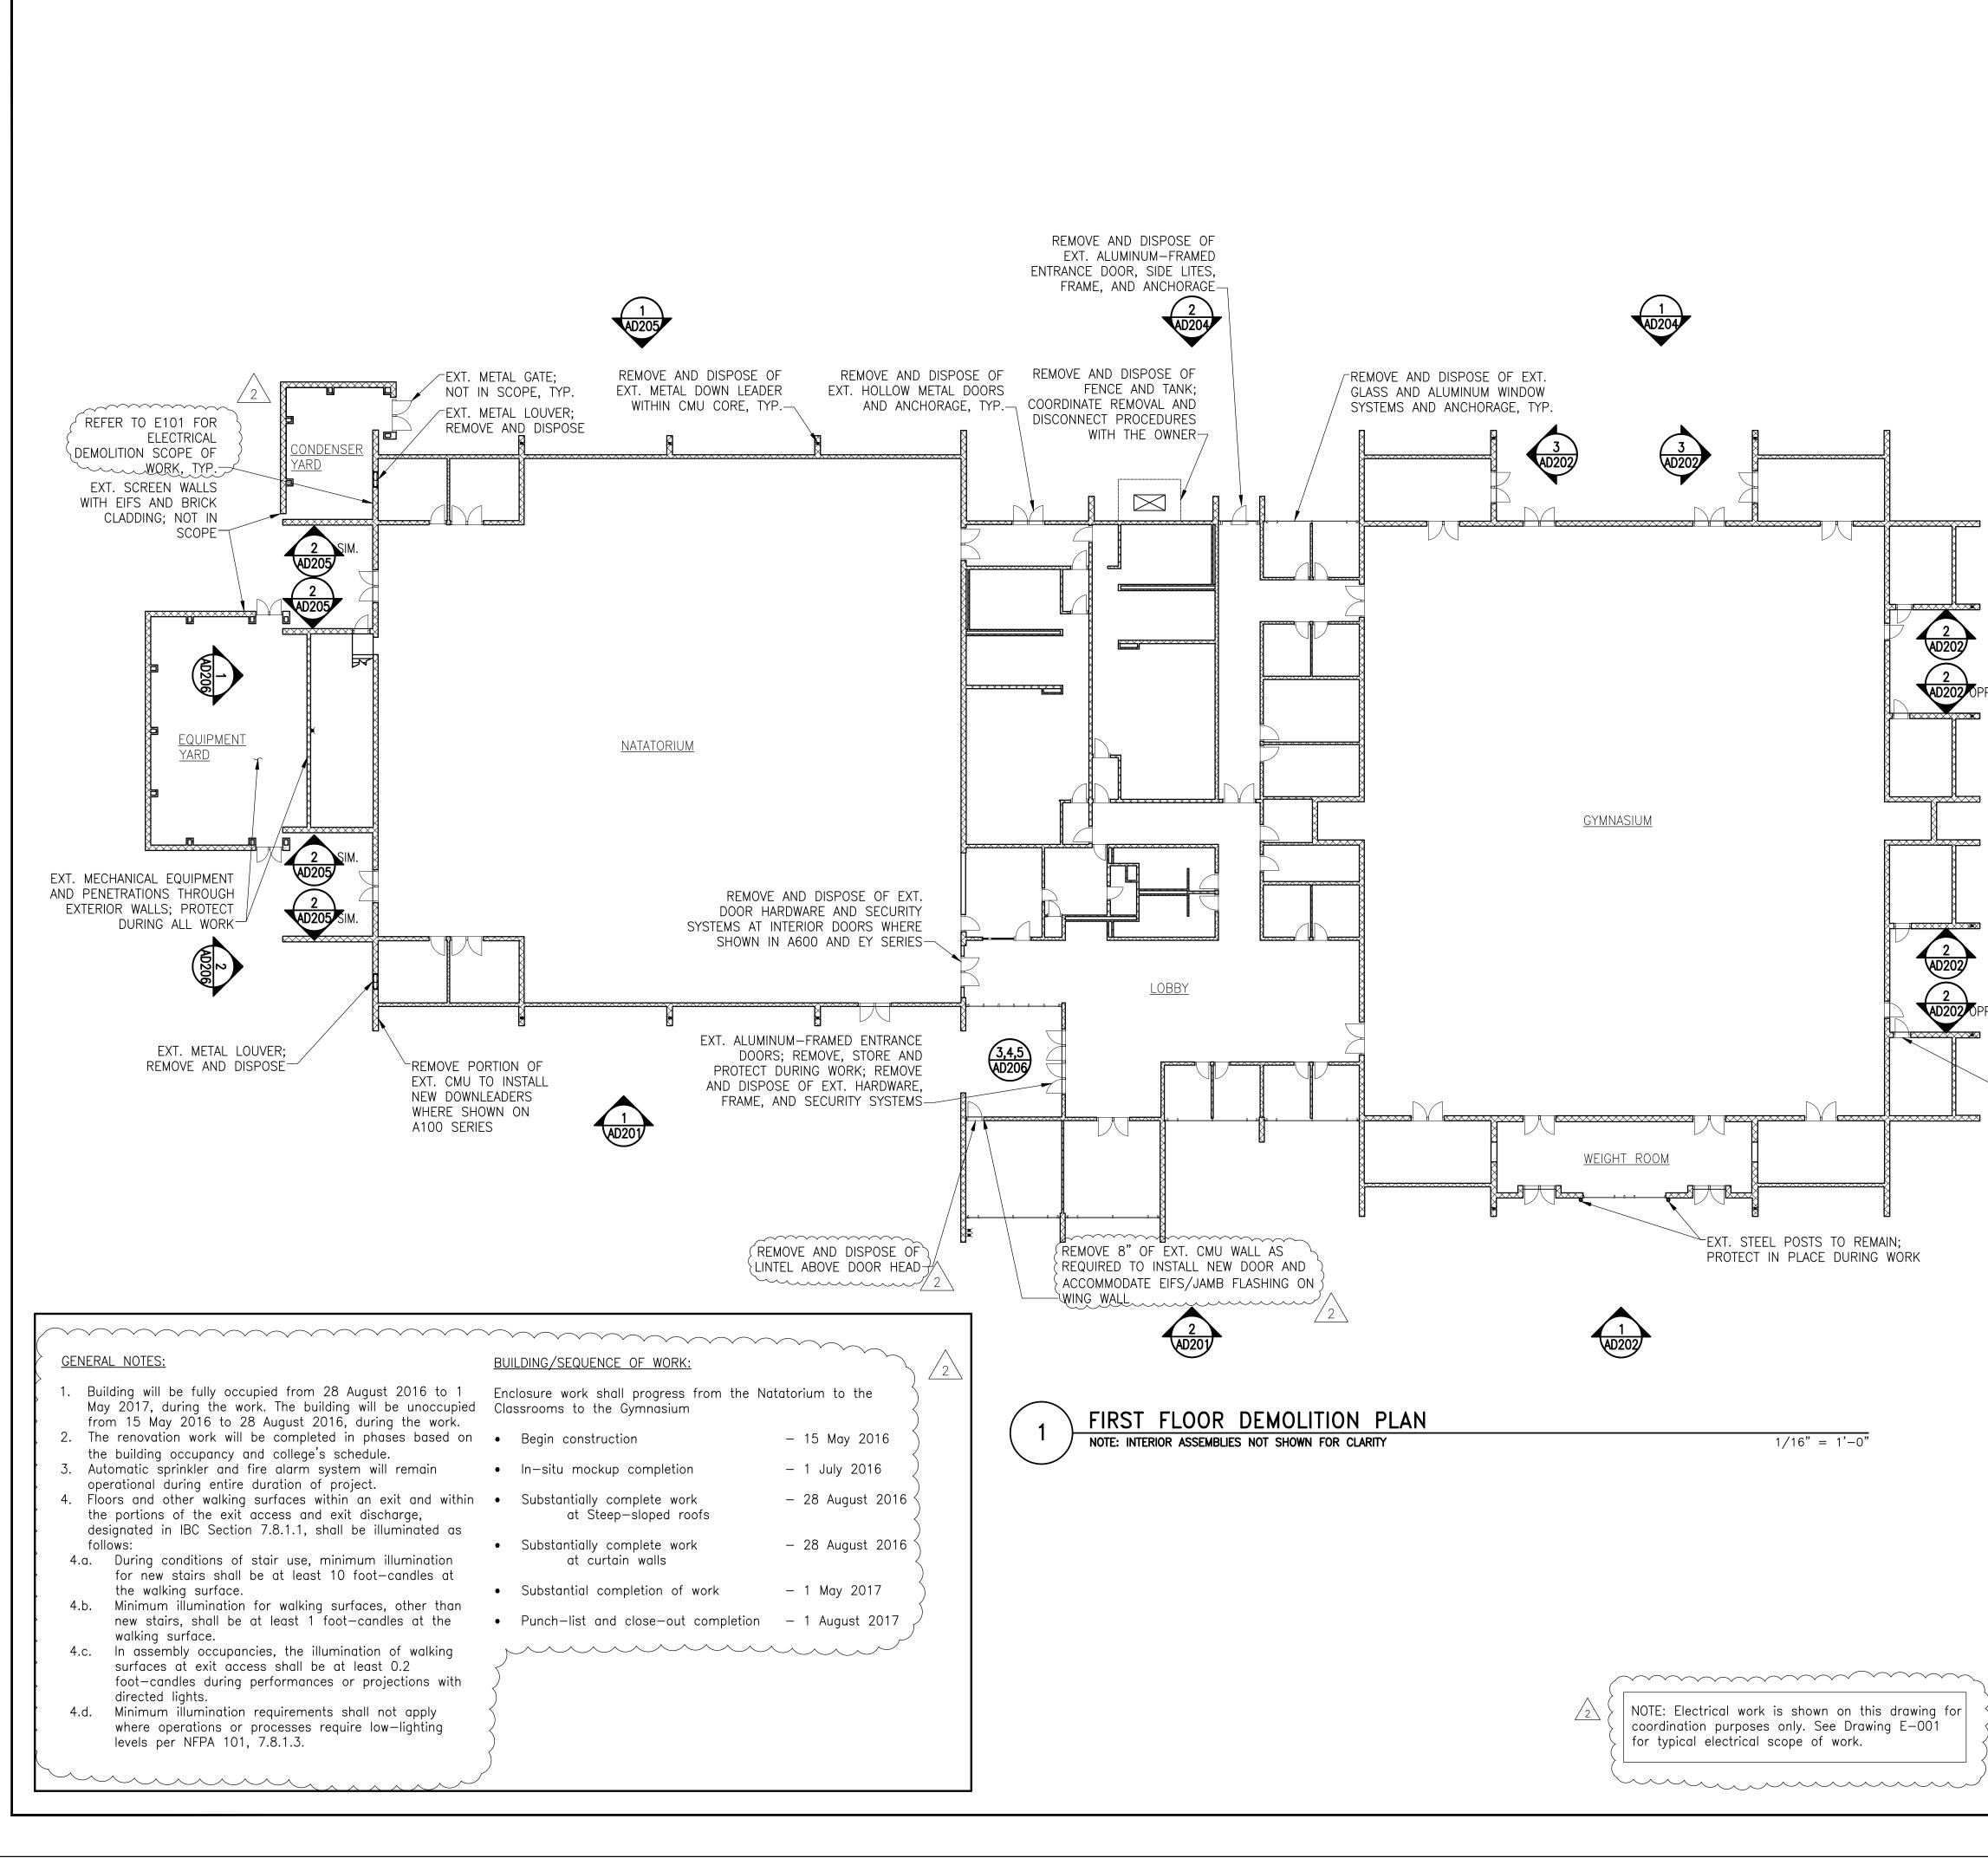

Exterior Walls:

- 1. Excavate the existing soil or gravel surfacing around the building perimeter to expose the existing wall footings.
- 2. Existing stucco cladding over CMU backup walls to remain. Remove and dispose any loose or damaged existing stucco cladding; patch and repair damaged or removed stucco as required.
- 3. Remove and dispose of exposed exterior downleaders. Remove and dispose of the existing stucco cladding and CMU wing walls where shown on the drawings to remove and replace the existing downleaders set into the CMU wing walls.
- 4. Remove and dispose of the existing EIFS cladding, rigid insulation, sheathing, flashings, metal copings and accessories, and miscellaneous metal furrings supporting the EIFS cladding assemblies at the upper and lower soffits, exterior beams, Weight Room addition, and other wall areas around the building.
- 5. Remove and dispose of the existing exterior windows and entrance door assemblies, clerestory windows, and exterior hollow-metal doors, including all perimeter frames and anchorage, unless noted otherwise.
- Remove and dispose of the existing door hardware and security systems at interior doors where shown in A600 and EY Series. 7. Openings at removed exterior doors serving
- _as exit doors must be maintained for appropriate egress; replacement doors must ightarrowhave appropriate panic hardware in
- accordance with IBC Section 1010.1.9.9 and Section 1010.1.10, as shown on A600. 8. Remove and dispose of the existing wood trellises. Existing trellis anchorage to remain.
- Protect in place the existing exterior metal columns on the south elevation of the Weight Room.
- 10. Remove and store, or protect in place, all exterior light fixtures, security cameras, fans, louvers and vents, fire alarm and fire department connection, access hatches, and other miscellaneous components on the exterior wall unless otherwise described in the Drawings.
- 11. Remove the existing exterior conduits over the cladding assembly and relocate within the building interior; extend through exterior wall and provide new cladding where required to service exterior components to remain.


-REMOVE AND STORE, OR PROTECT IN PLACE, EXT. METAL LOUVERS ABOVE HOLLOW METAL DOOR, TYP. AT EAST ELEVATION


LEGEND DOOR SWING DIRECTION; _ REMOVE AND DISPOSE OF EXT. EXTERIOR DOORS ONLY; UNLESS NOTED OTHERWISE REMOVE AND DISPOSE OF EXT. _ ALUMINUM-FRAMED WINDOWS


> METAL LOUVER EXT. CMU WALLS TO REMAIN; _

PATCH AND REPAIR AS NECESSARY REMOVE AND DISPOSE OF EXT. DOWN LEADER


Seal

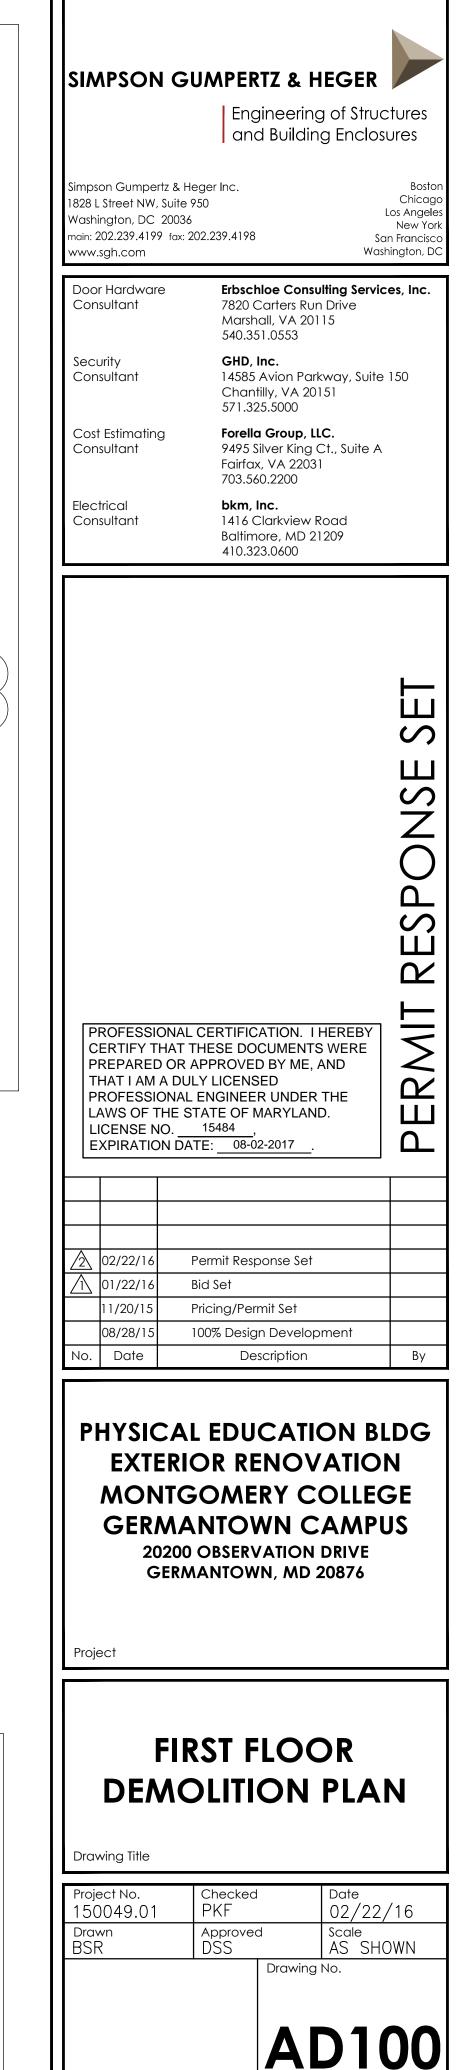

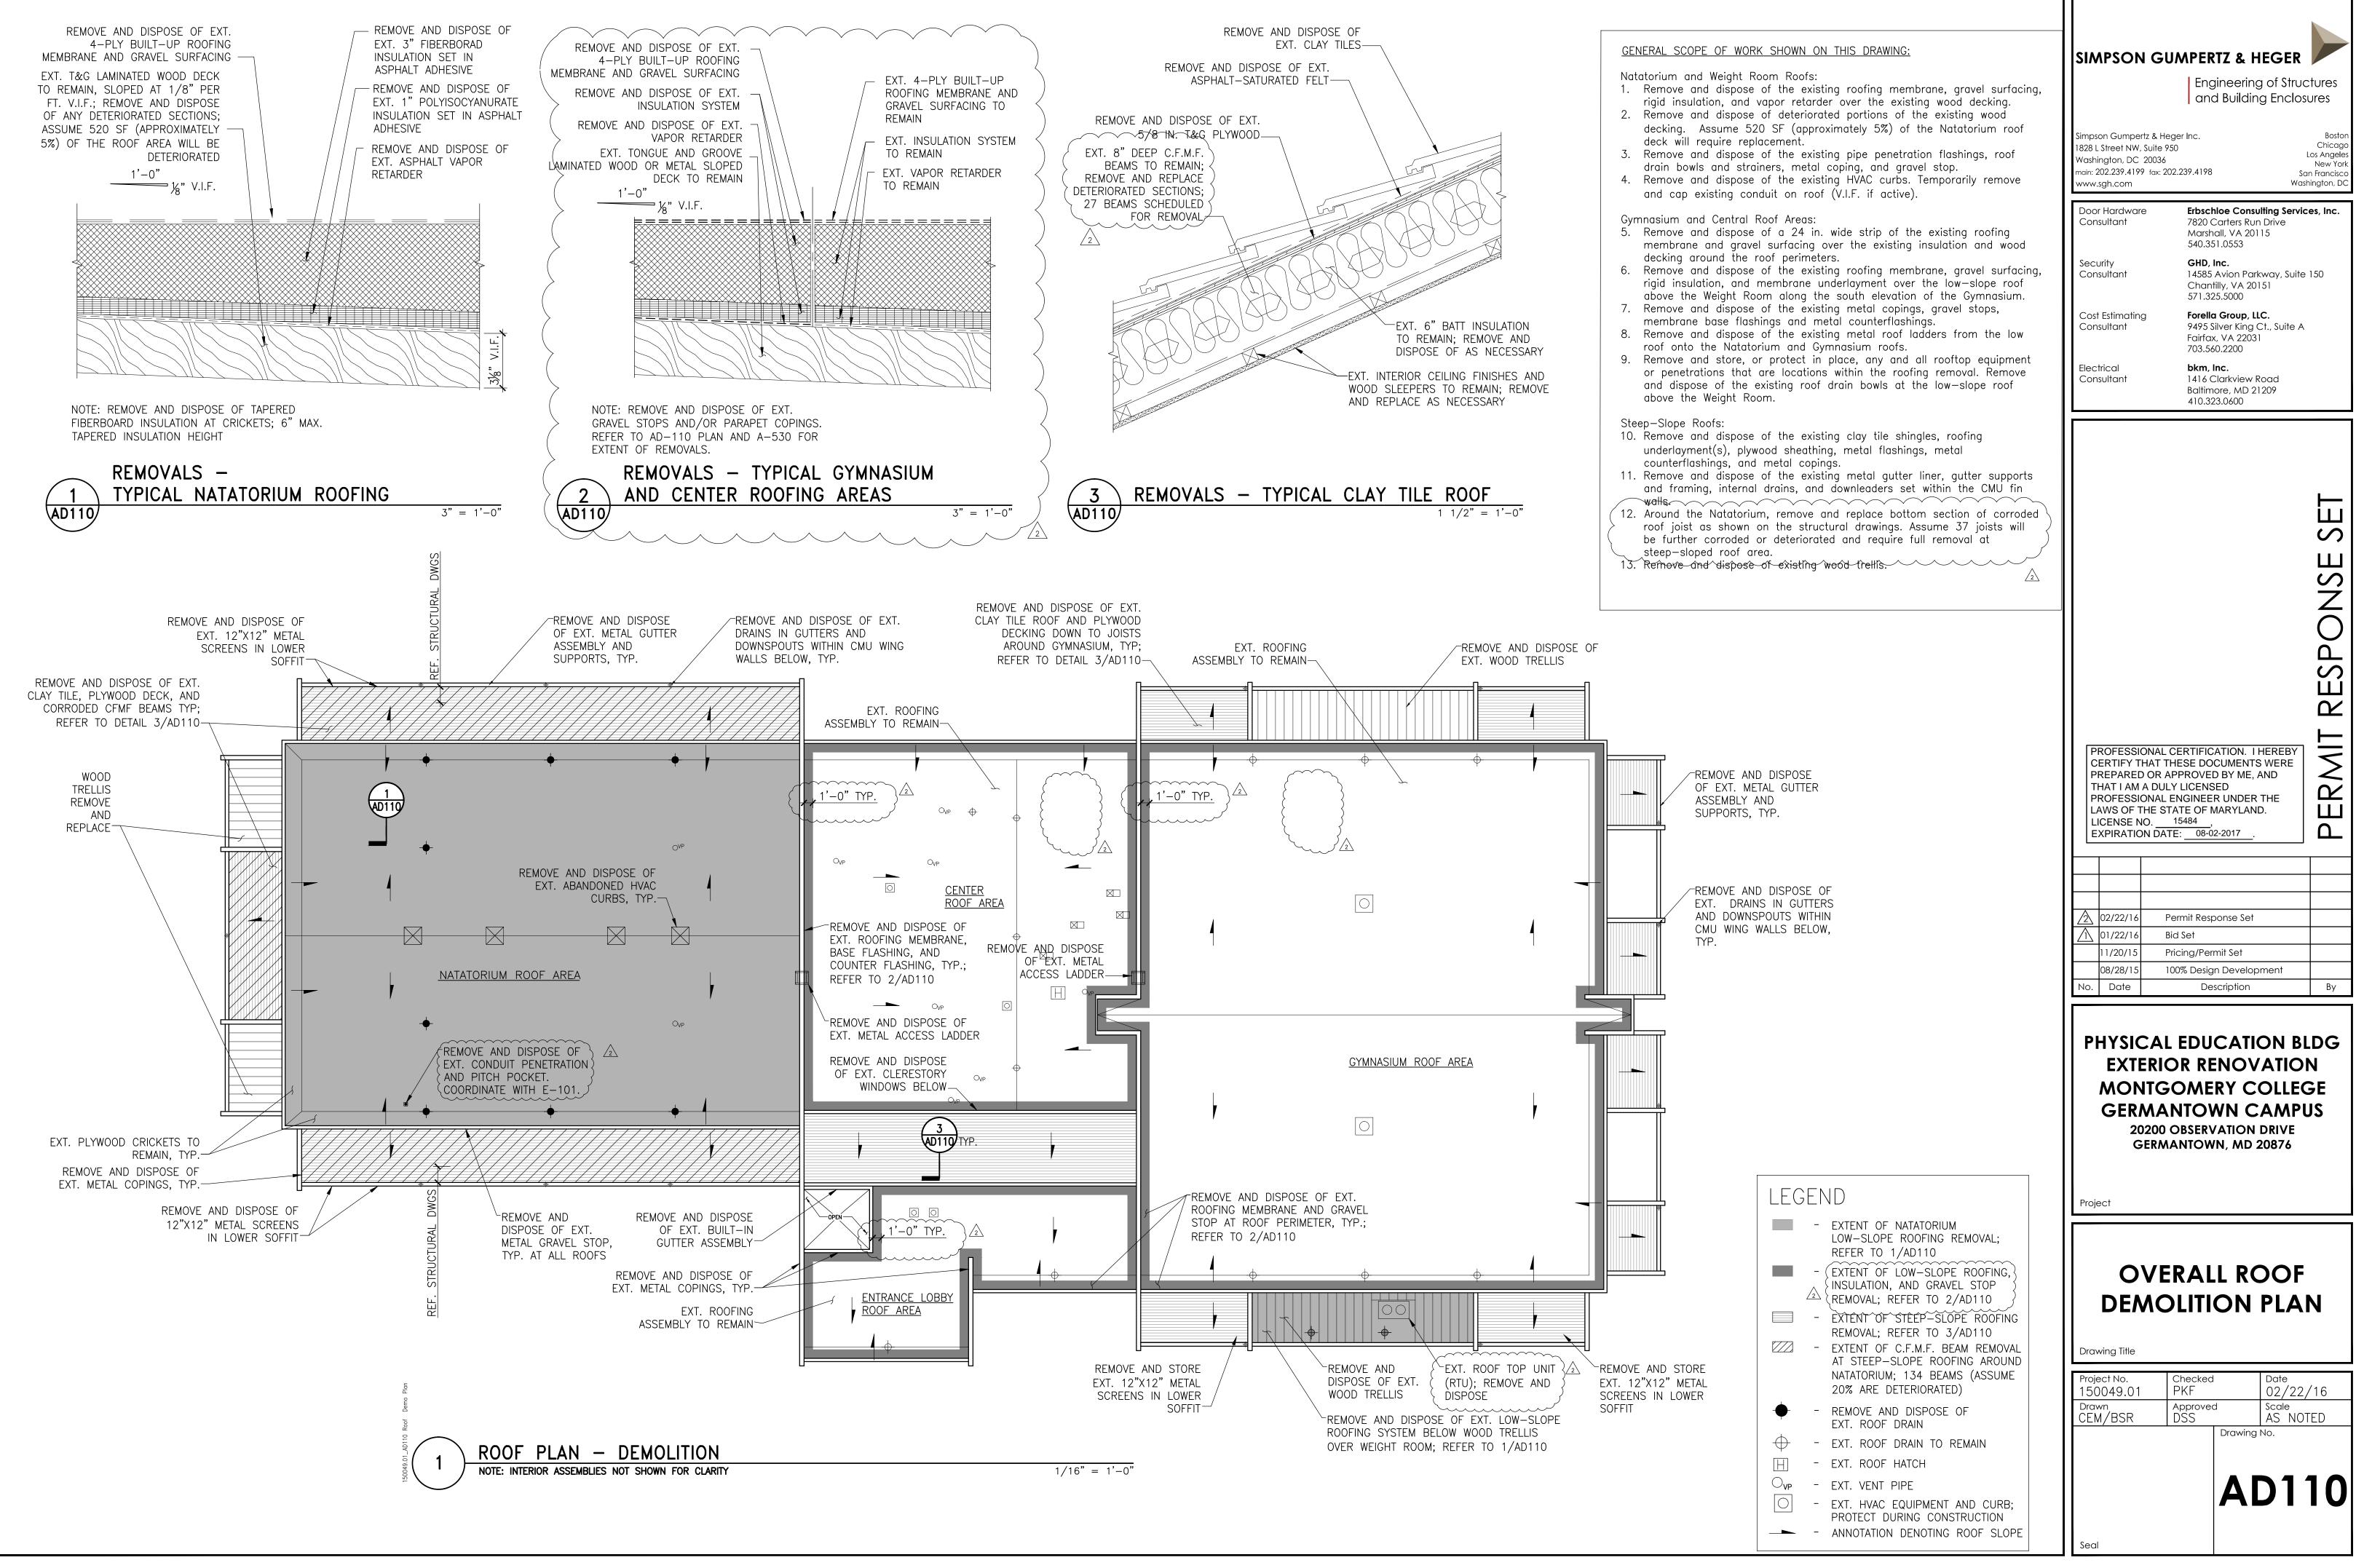


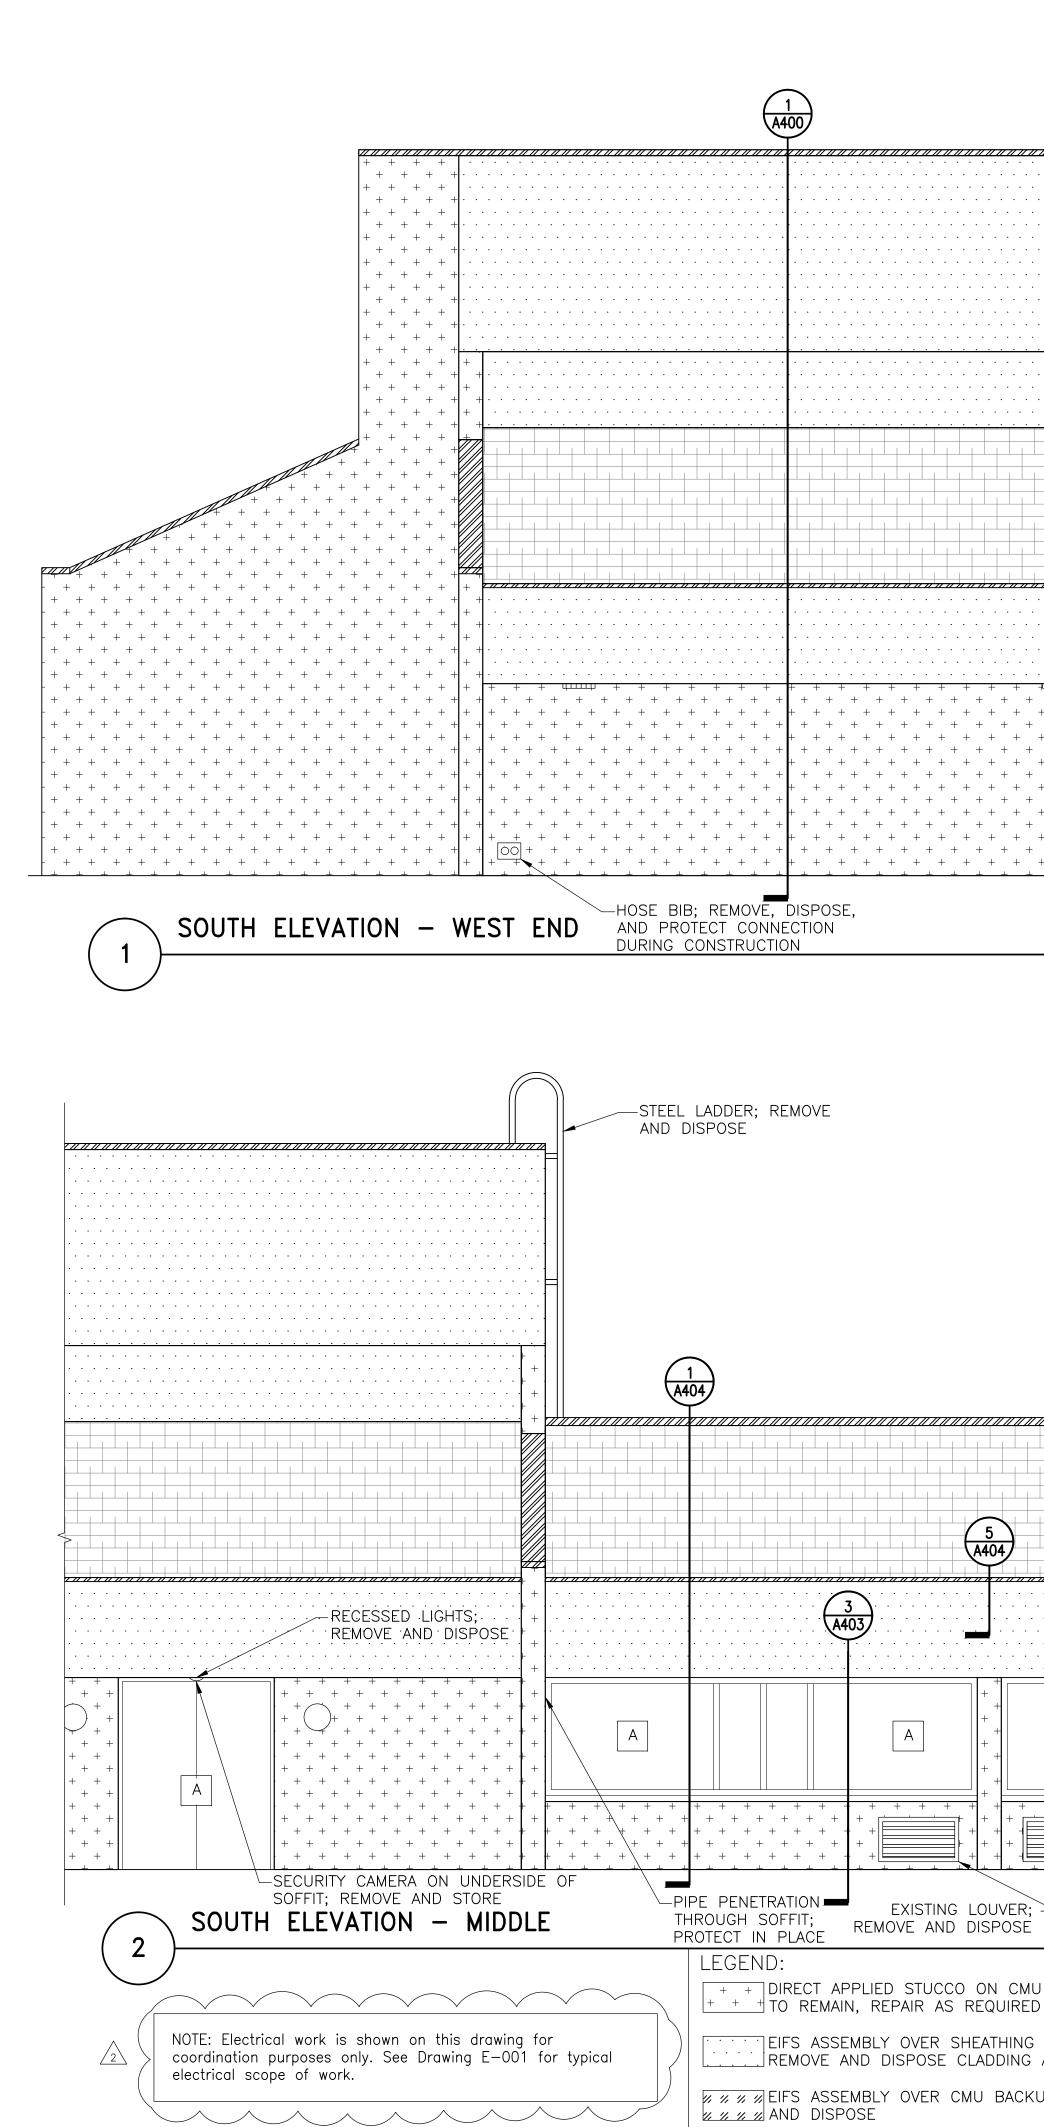

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	FIRE ALARM BELL; REMOVE AND STORE. MAINTAIN CONNECTION UNTIL NEW CONNECTION IS INSTALLED AND INTEGRATED WITH SERVICE. COORDINATE WITH COLLEGE, AHJ, AND FIRE DEPARTMENT AS REQUIRED PER NFPA 1,
	ATED WITH AND FIRE 1, 16.4.4 REMOVE AND DISPOSE DOWN
	TS AS SHOWN ON AD110 TOP AND COPINGS; REMOVE COP AND COPINGS; REMOVE

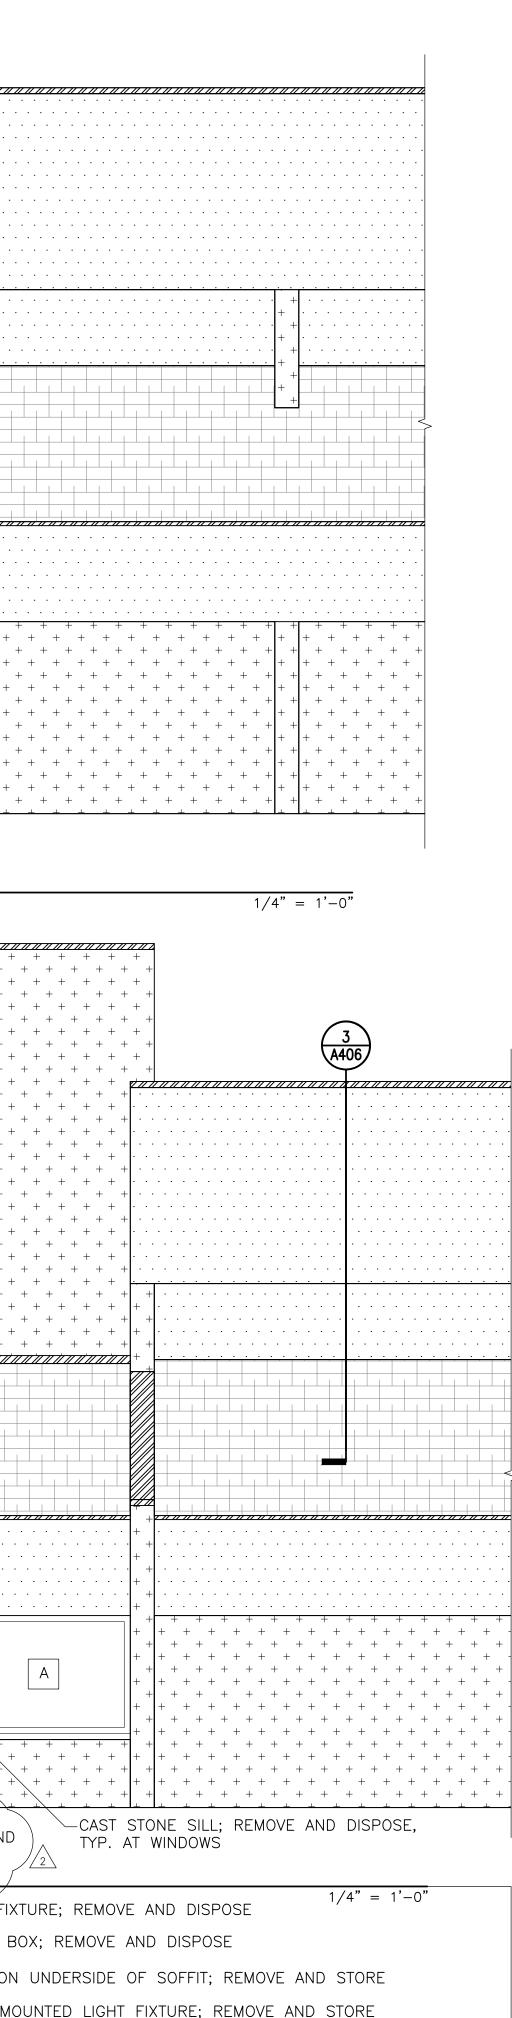

SIMPSON	GUMPERTZ & HEGER
	Engineering of Structures and Building Enclosures
Simpson Gumpertz & 1828 L Street NW, Sui Washington, DC 200	ite 950 Chicago D36 Los Angeles New York
main: 202.239.4199 fc www.sgh.com	1x: 202.239.4198 San Francisco Washington, DC
Door Hardware Consultant	Erbschloe Consulting Services, Inc. 7820 Carters Run Drive Marshall, VA 20115 540.351.0553
Security Consultant	GHD, Inc. 14585 Avion Parkway, Suite 150 Chantilly, VA 20151 571.325.5000
Cost Estimating Consultant	Forella Group, LLC. 9495 Silver King Ct., Suite A Fairfax, VA 22031 703.560.2200
Electrical Consultant	bkm, Inc. 1416 Clarkview Road Baltimore, MD 21209 410.323.0600
CERTIFY THA PREPARED O THAT I AM A I PROFESSION LAWS OF THE LICENSE NO.	AL CERTIFICATION. I HEREBY THESE DOCUMENTS WERE R APPROVED BY ME, AND DULY LICENSED AL ENGINEER UNDER THE E STATE OF MARYLAND. 15484 DATE:
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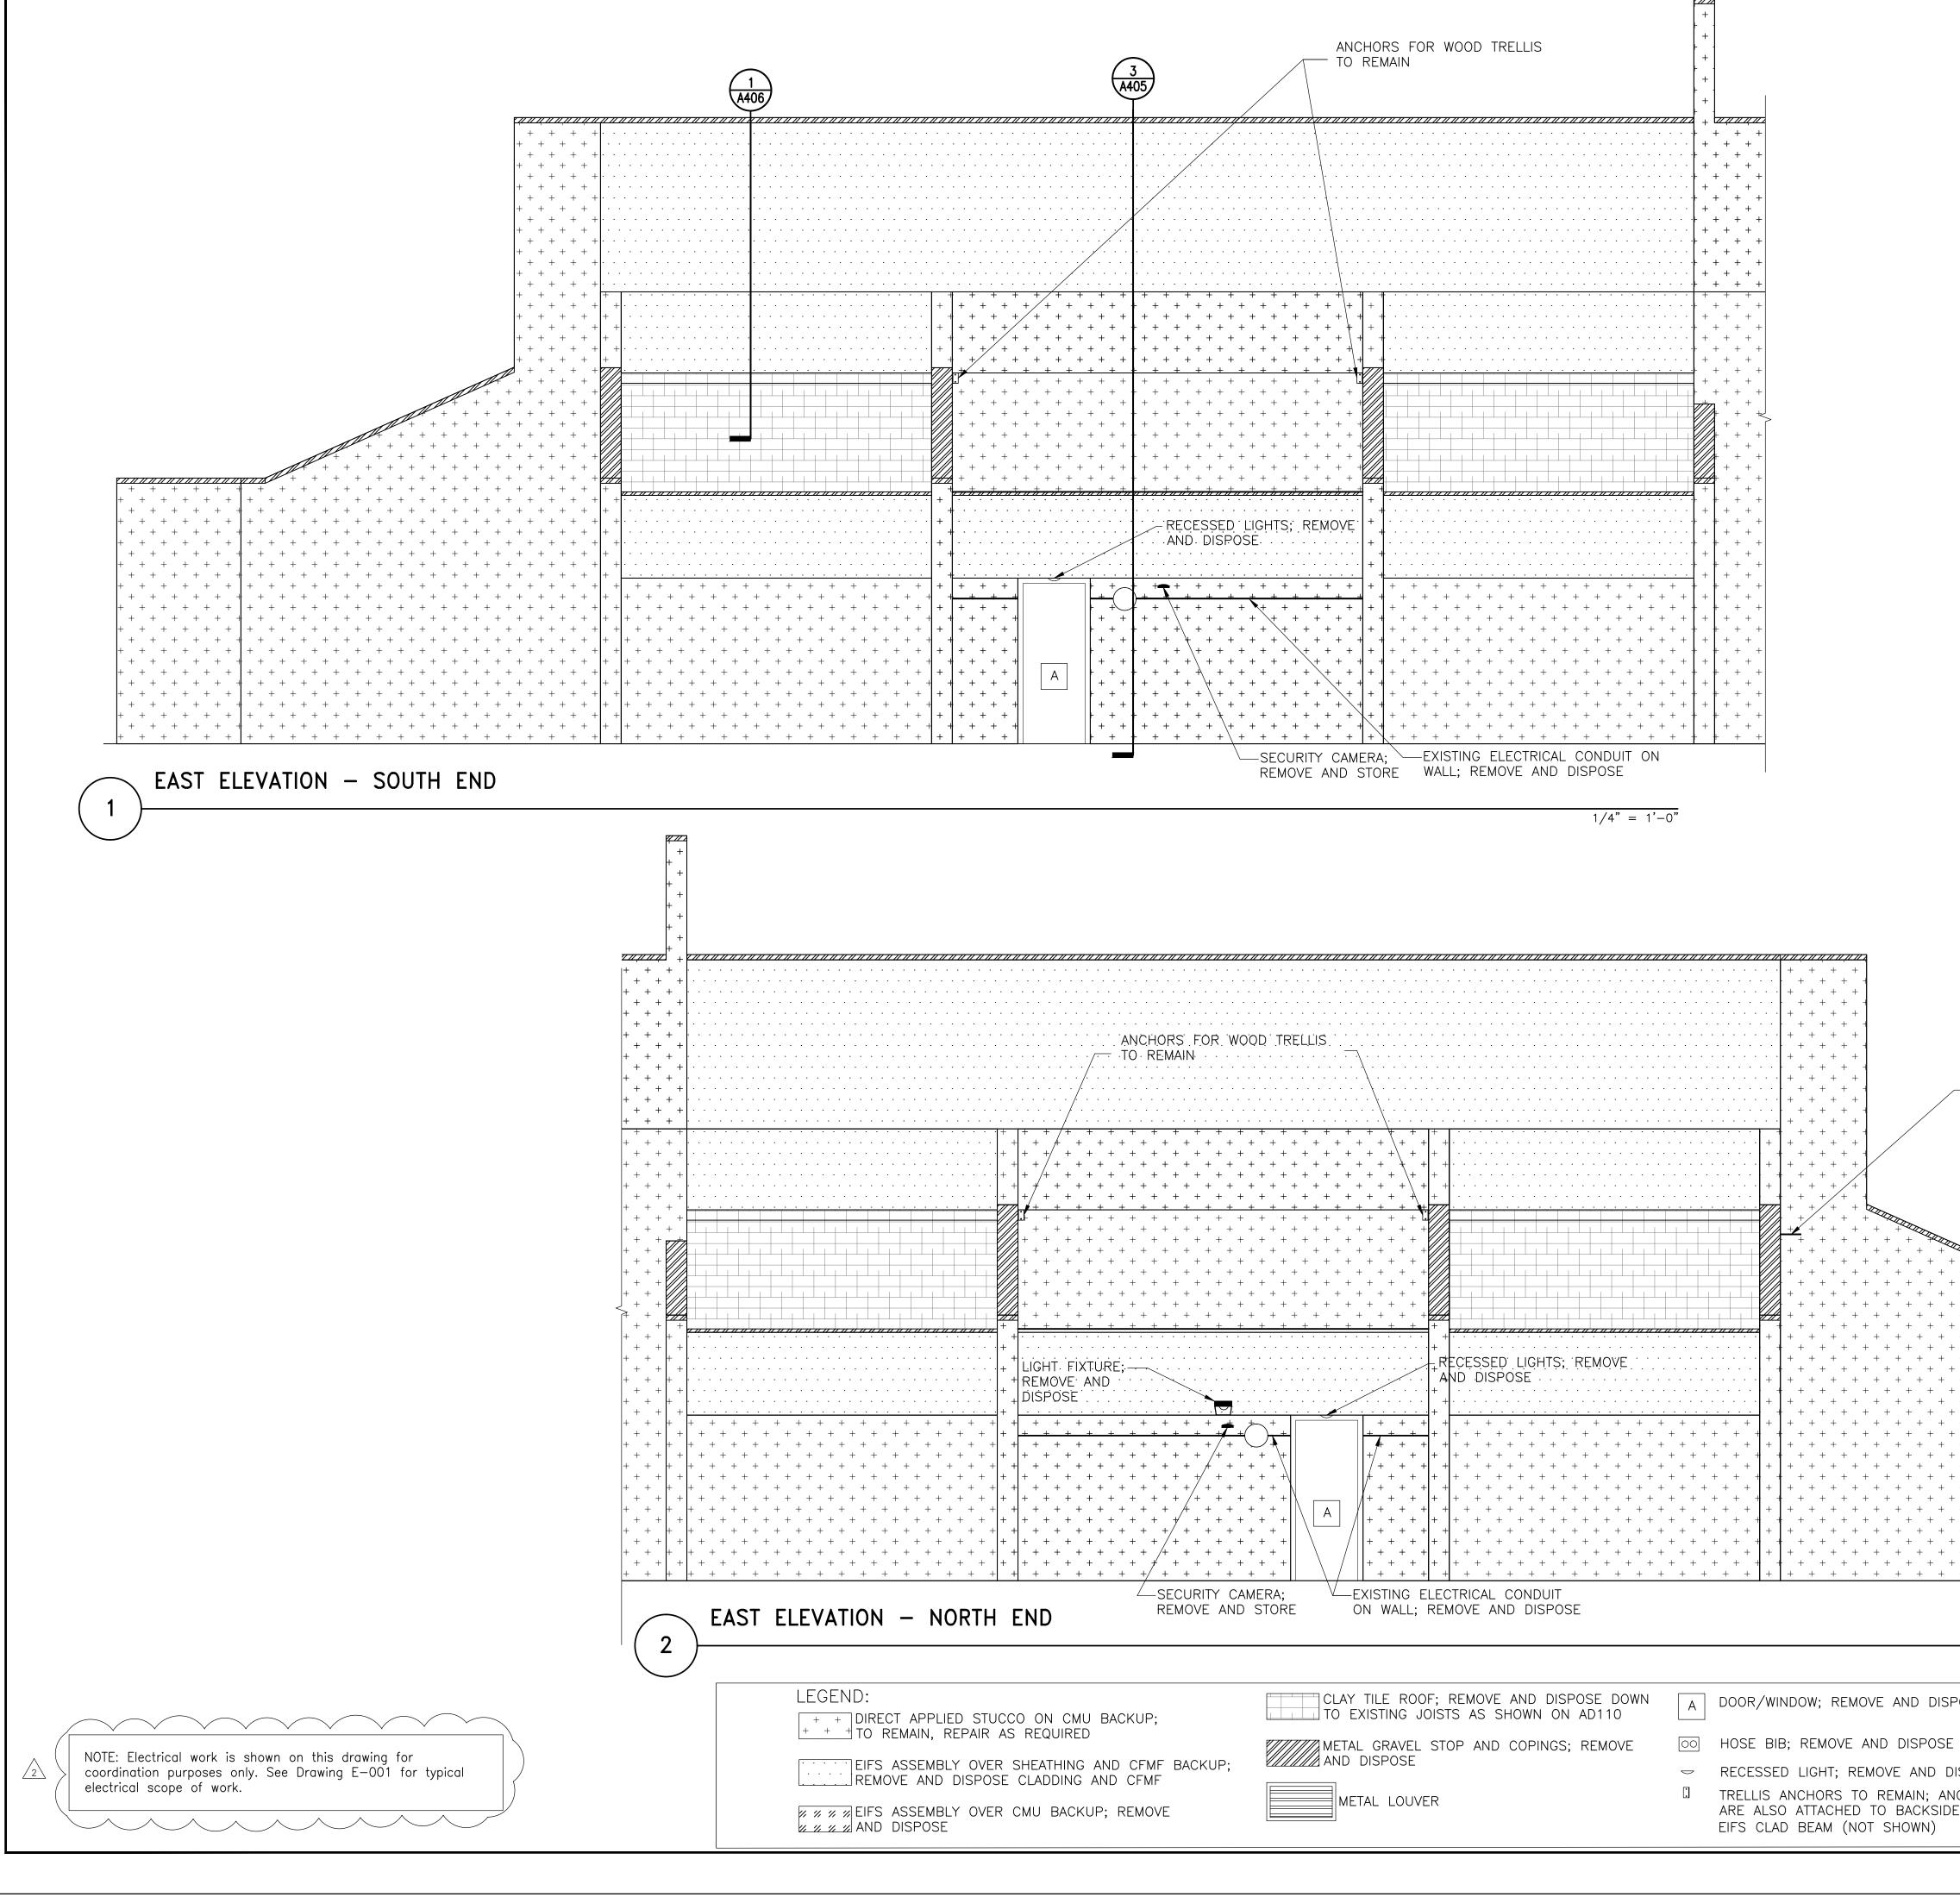
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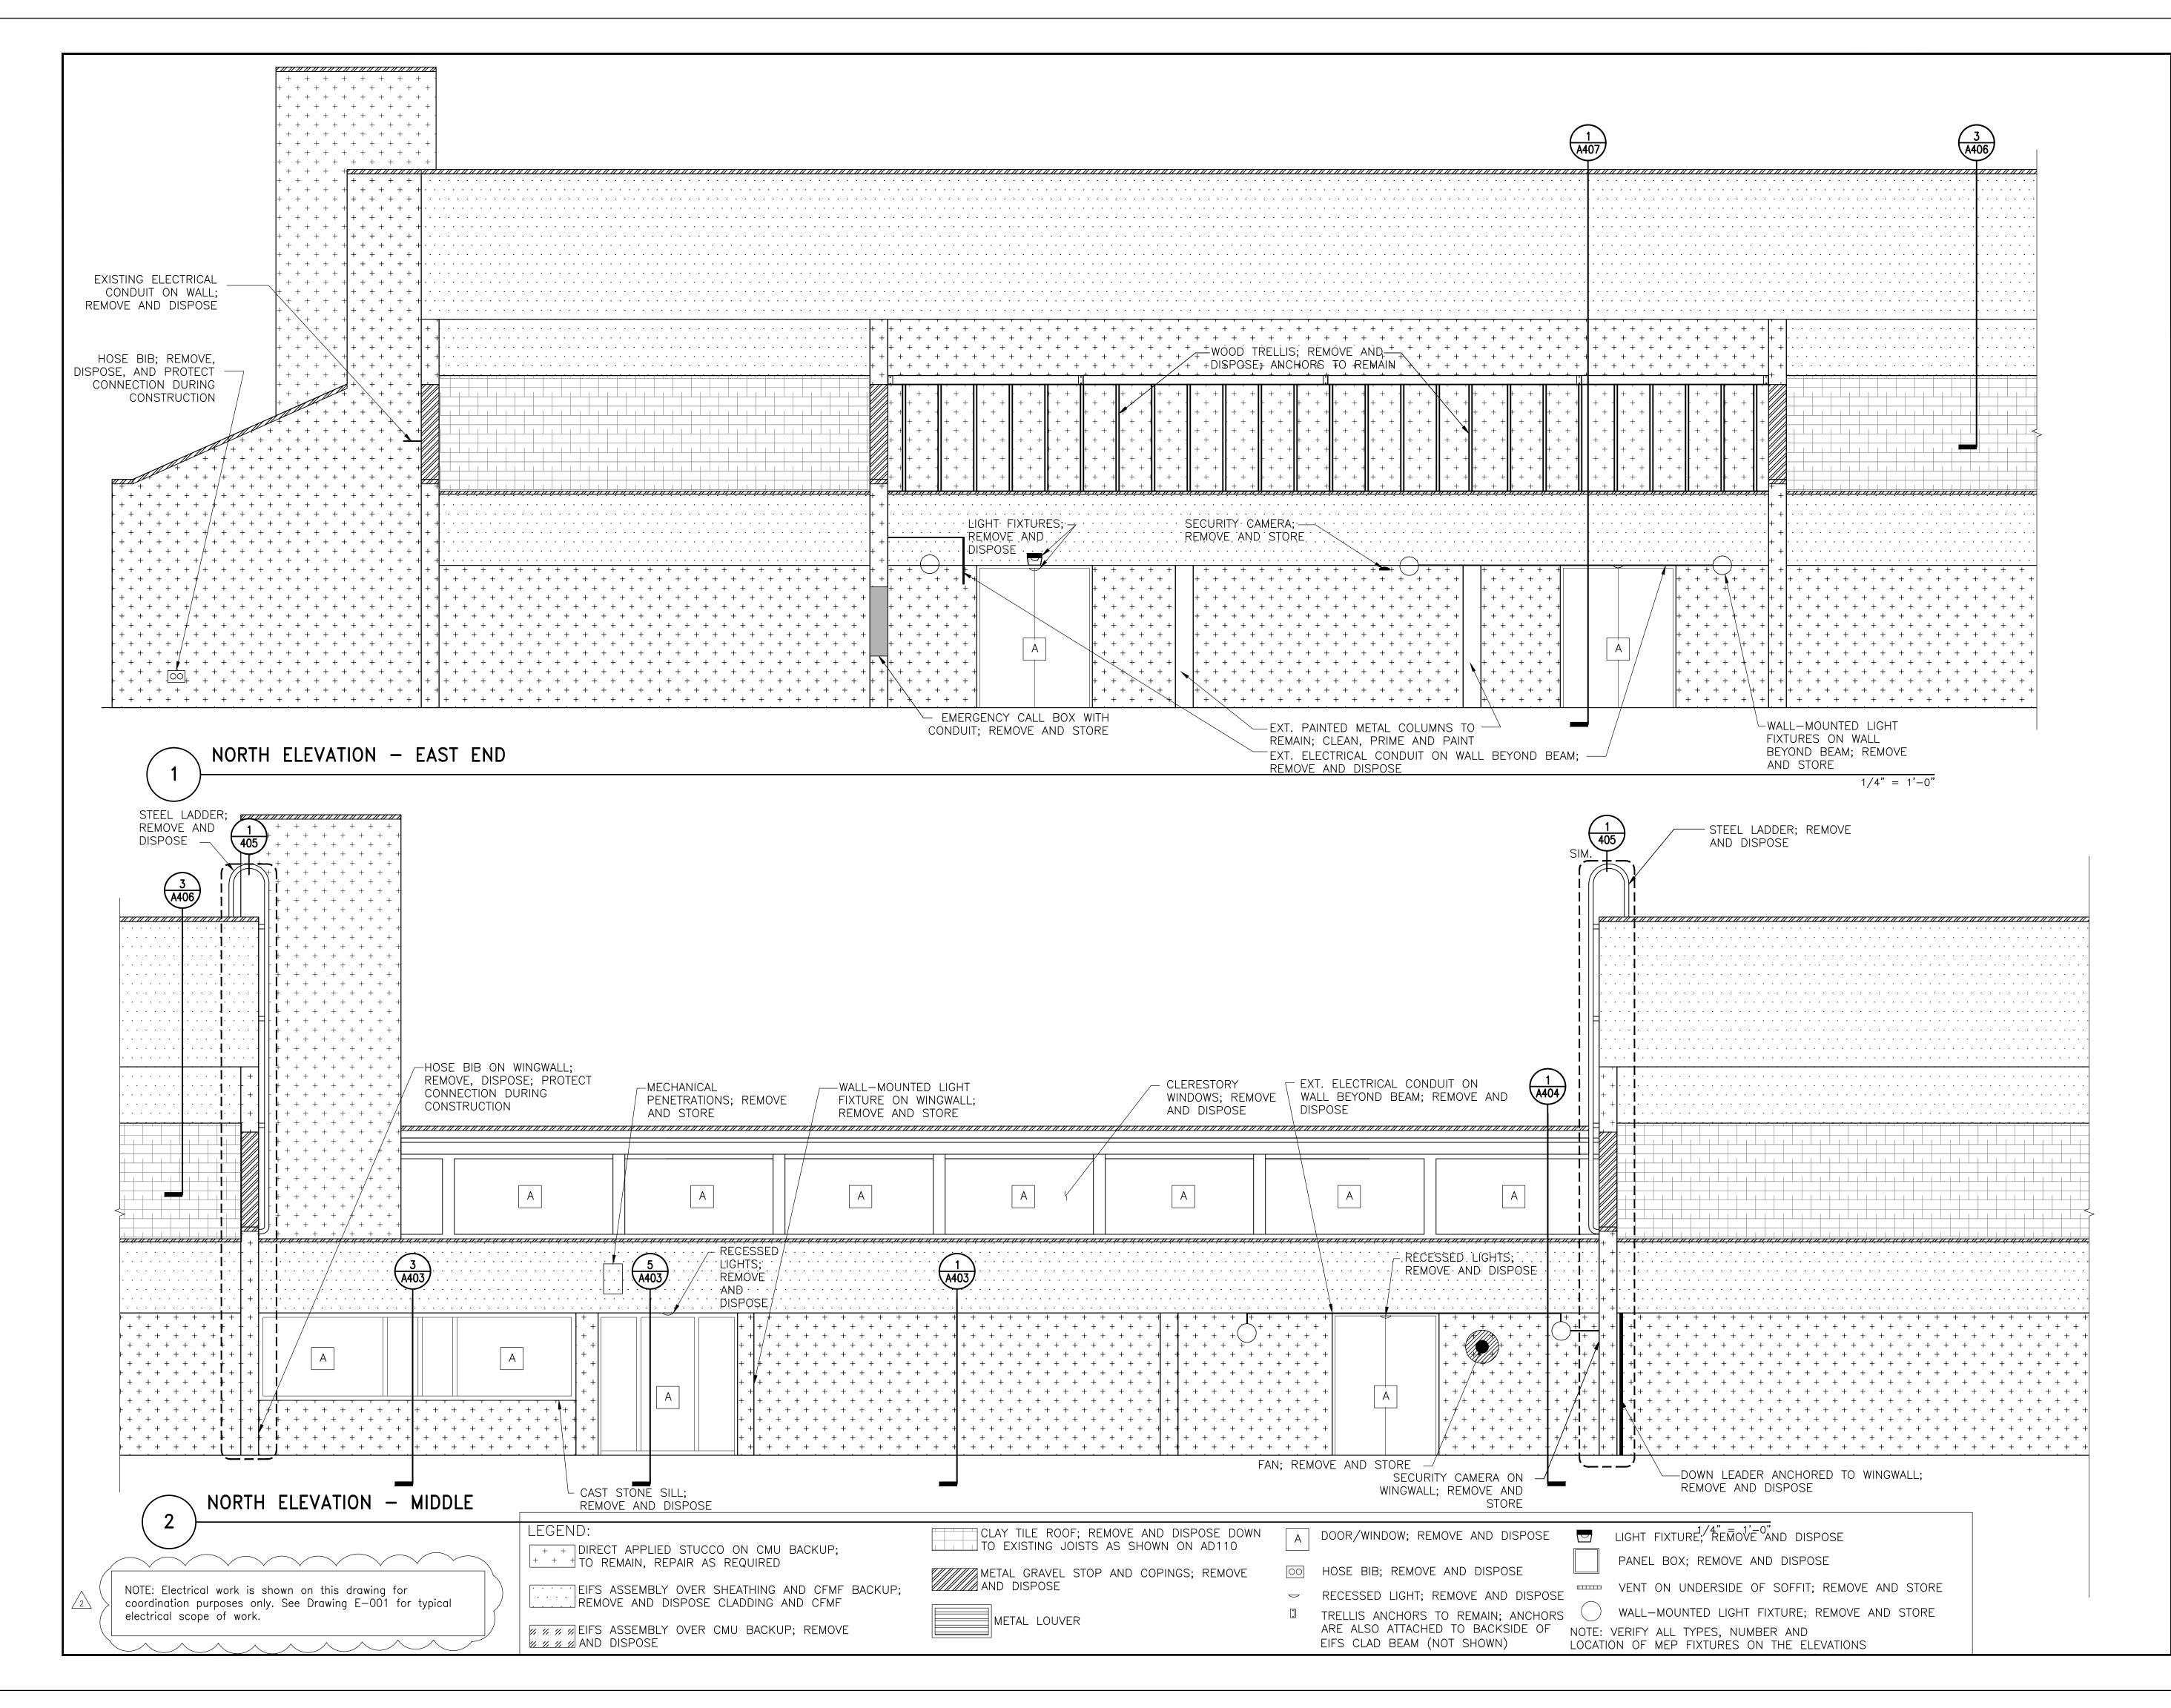
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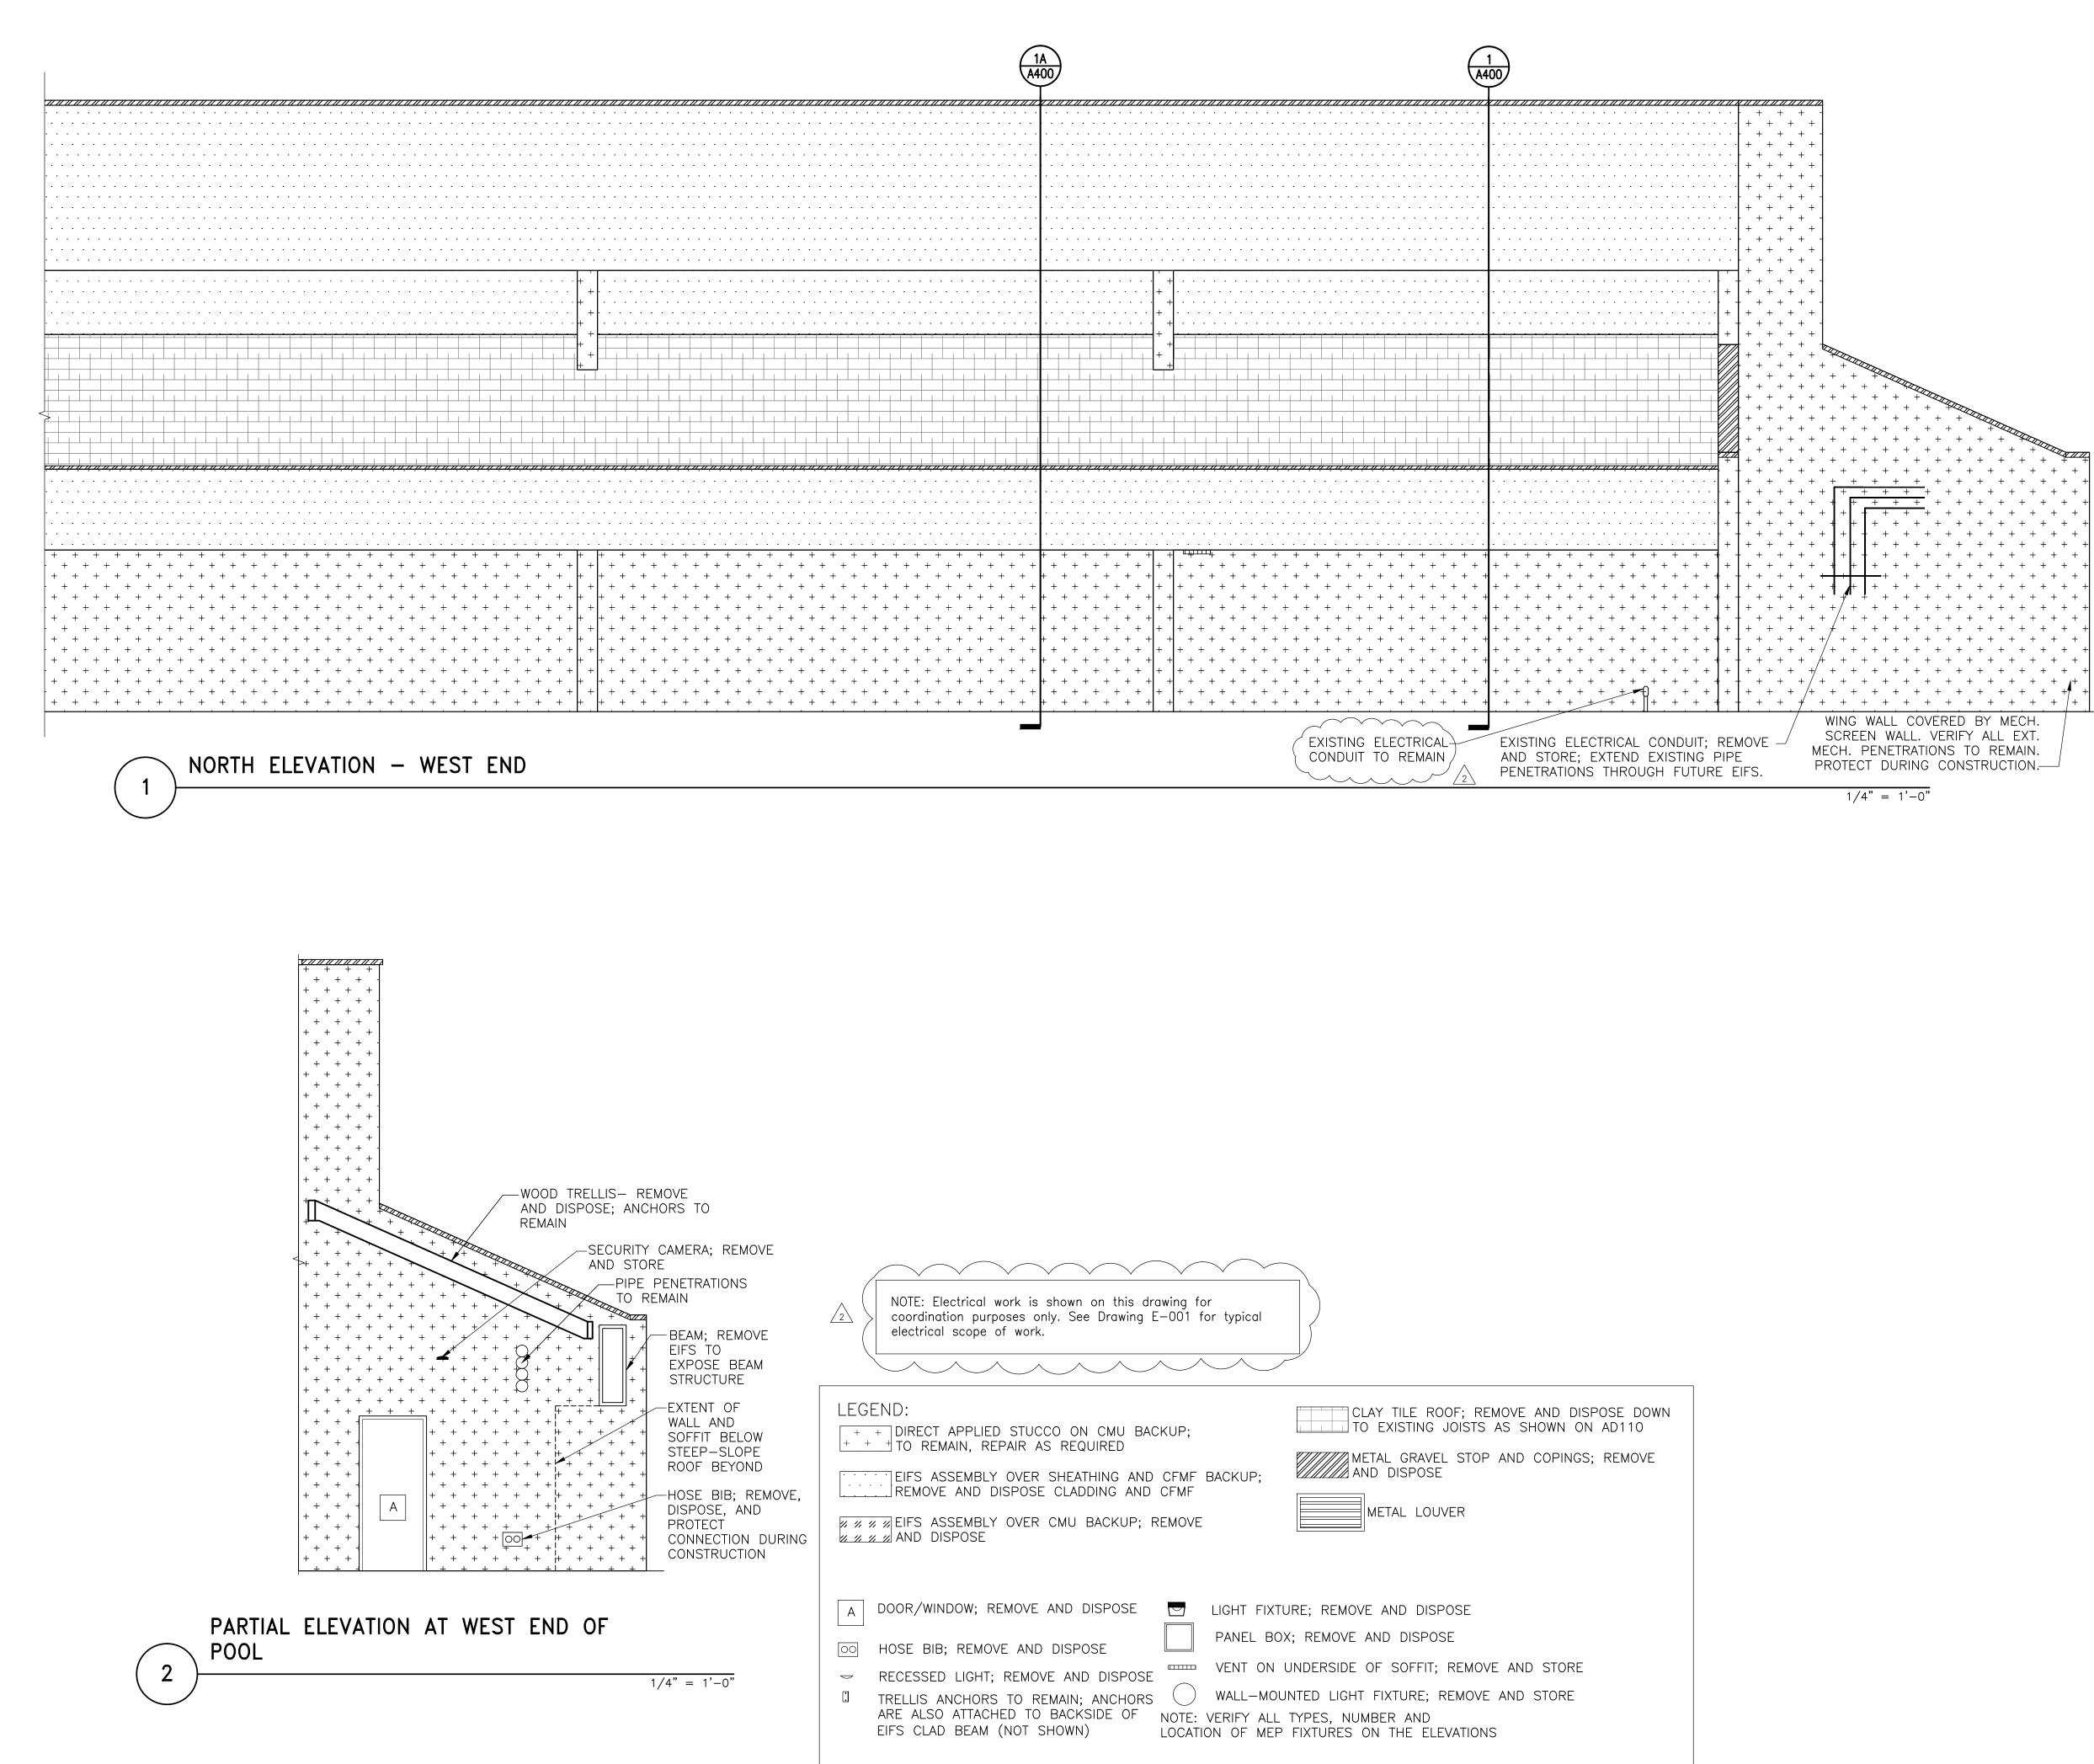

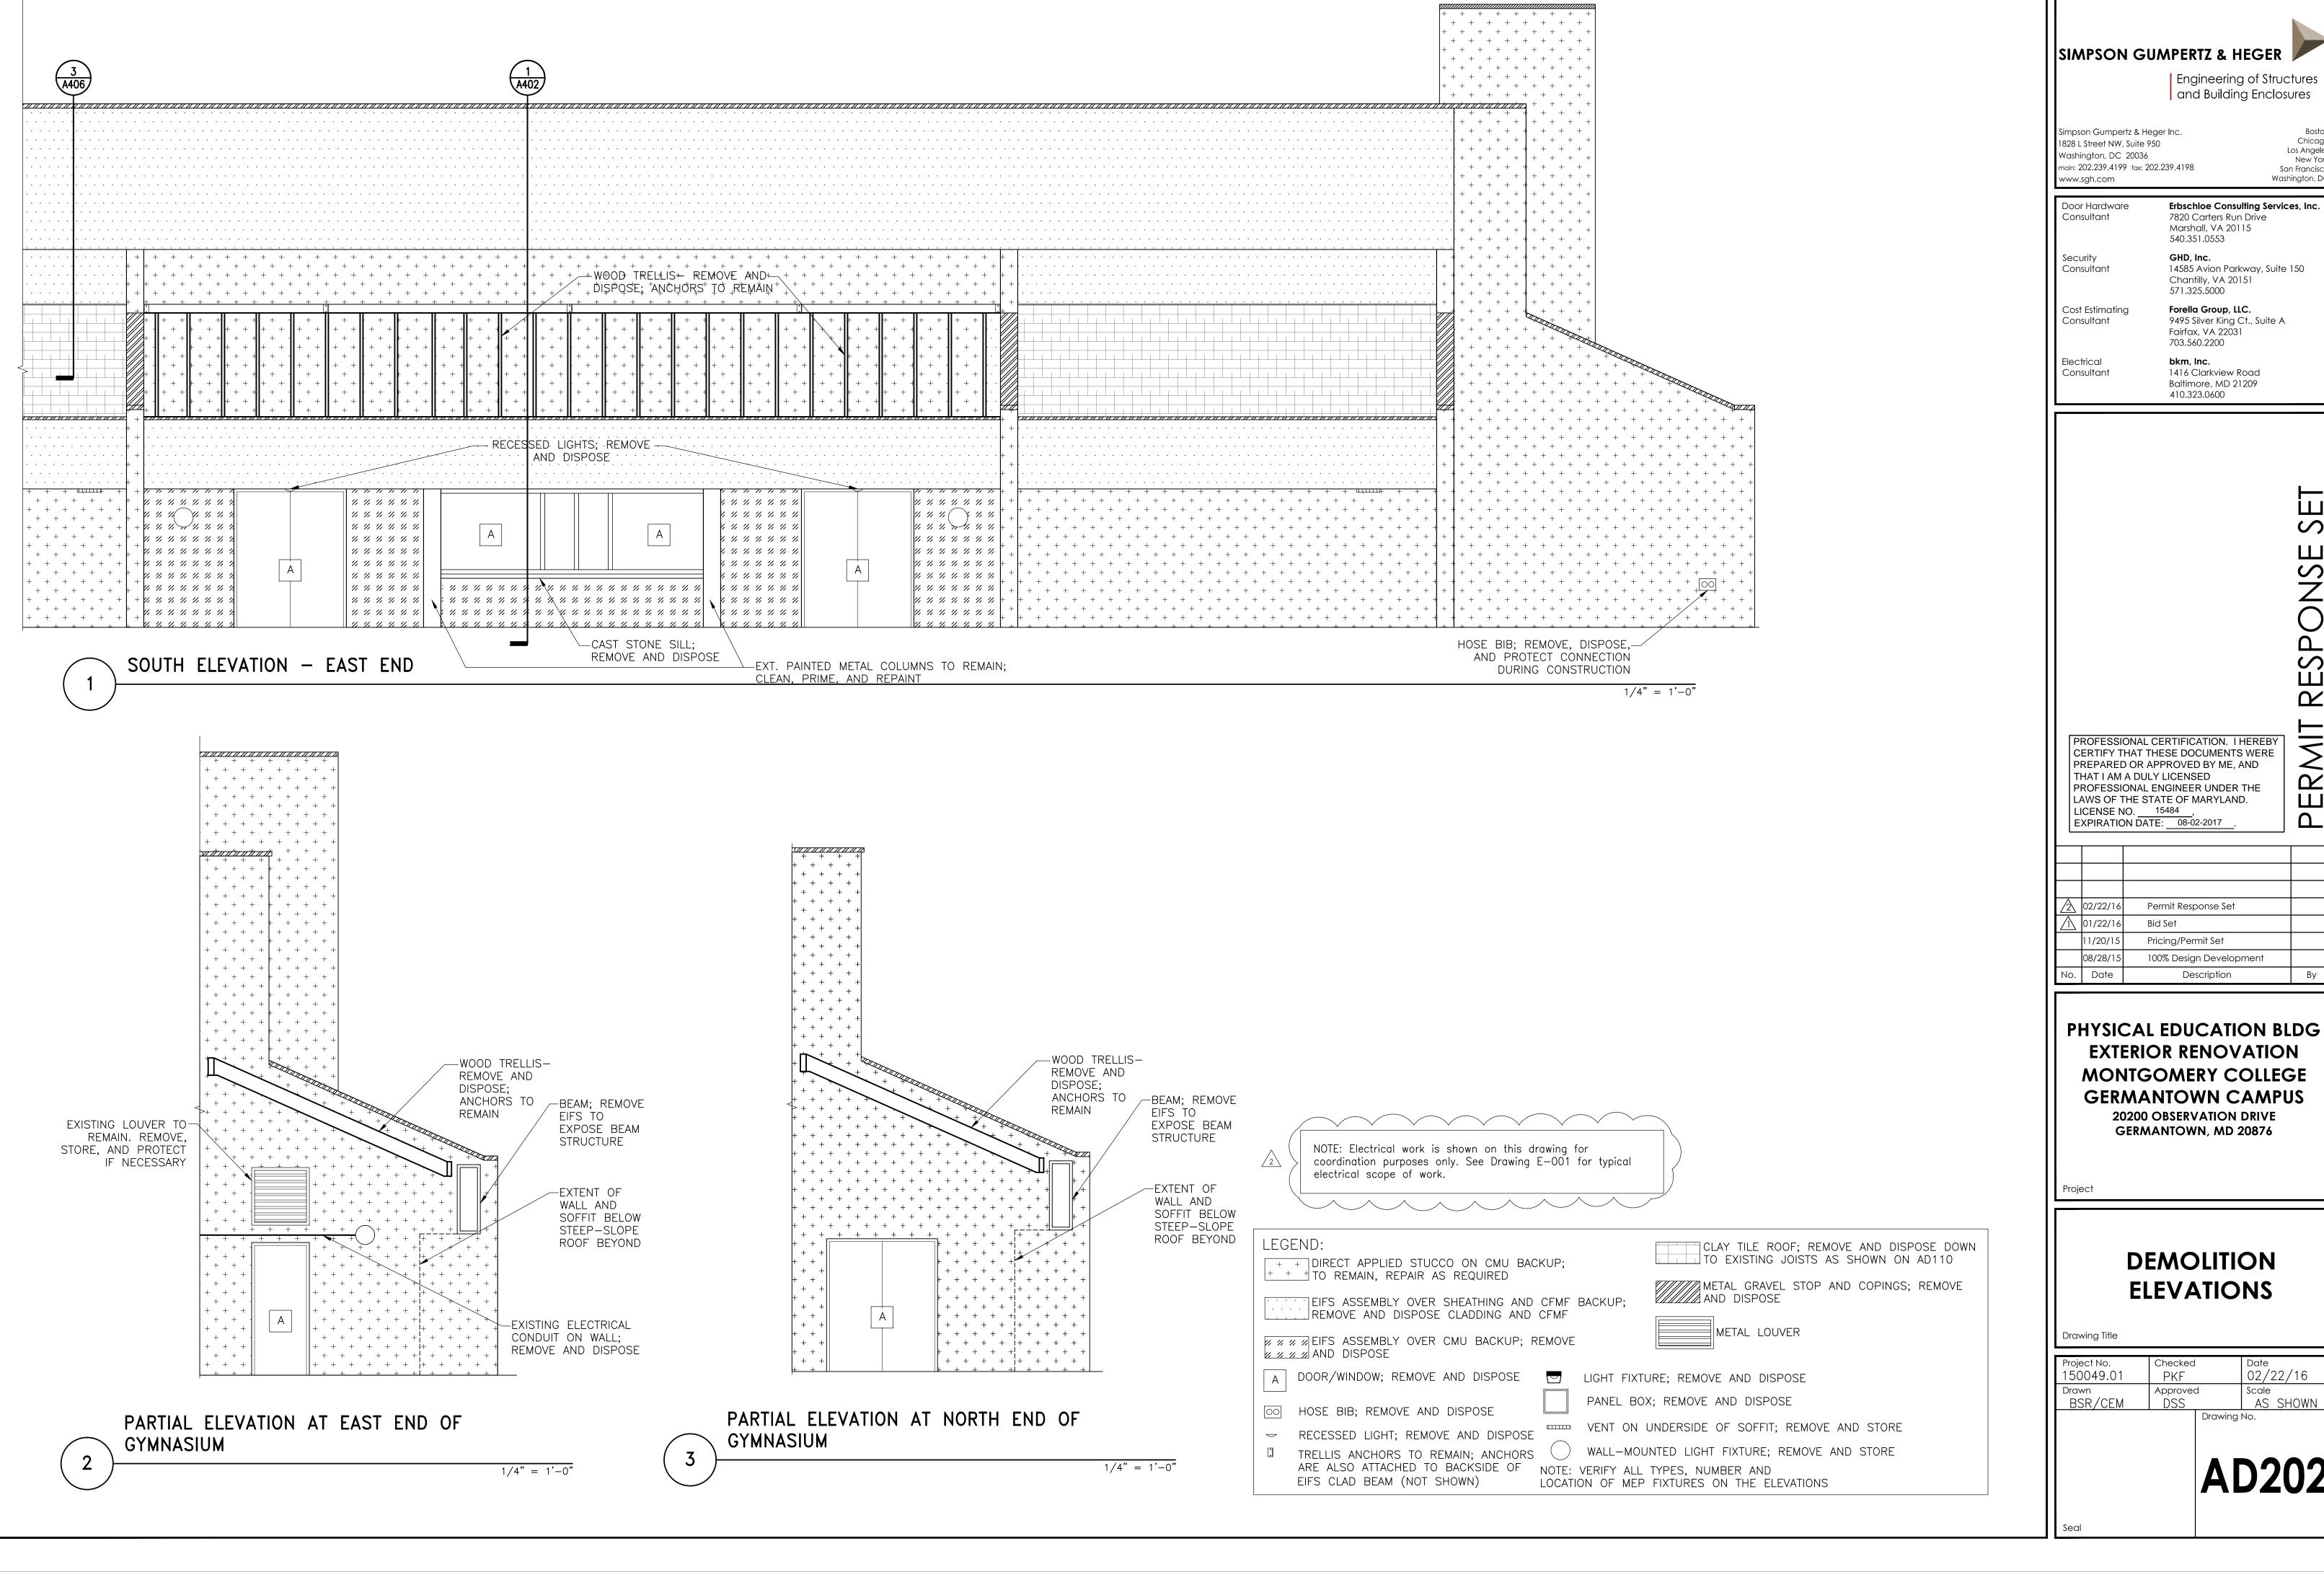
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ELECTRICAL CONDUIT ON WALL; REMOVE AND DISPOSE ©///22/14 Bid Sef Image: Sef MALL; REMOVE AND DISPOSE In//20/13 Pricing/Permit Set Image: Sef MOLDISPOSE Dispose In//20/13 Pricing/Permit Set Image: Sef MOLDISPOSE Dispose In//20/13 Pricing/Permit Set Image: Sef Image: Sef MOLDISPOSE Dispose PHYSICAL EDUCATION BLDG EXTERIOR RENOVATION BLDG EXTERIOR RENOVATION DRIVE GERMANTOWN CAMPUS 20200 OBSERVATION DRIVE GERMANTOWN, MD 20876 //* + + +		C P T L L	CERTIFY THA PREPARED C THAT I AM A PROFESSION AWS OF THI ICENSE NO	AT THESE DR APPRC DULY LICI NAL ENGIN E STATE (DOCUMENTS OVED BY ME, A ENSED NEER UNDER T OF MARYLAND	WERE ND THE	ERMIT RESPONSE
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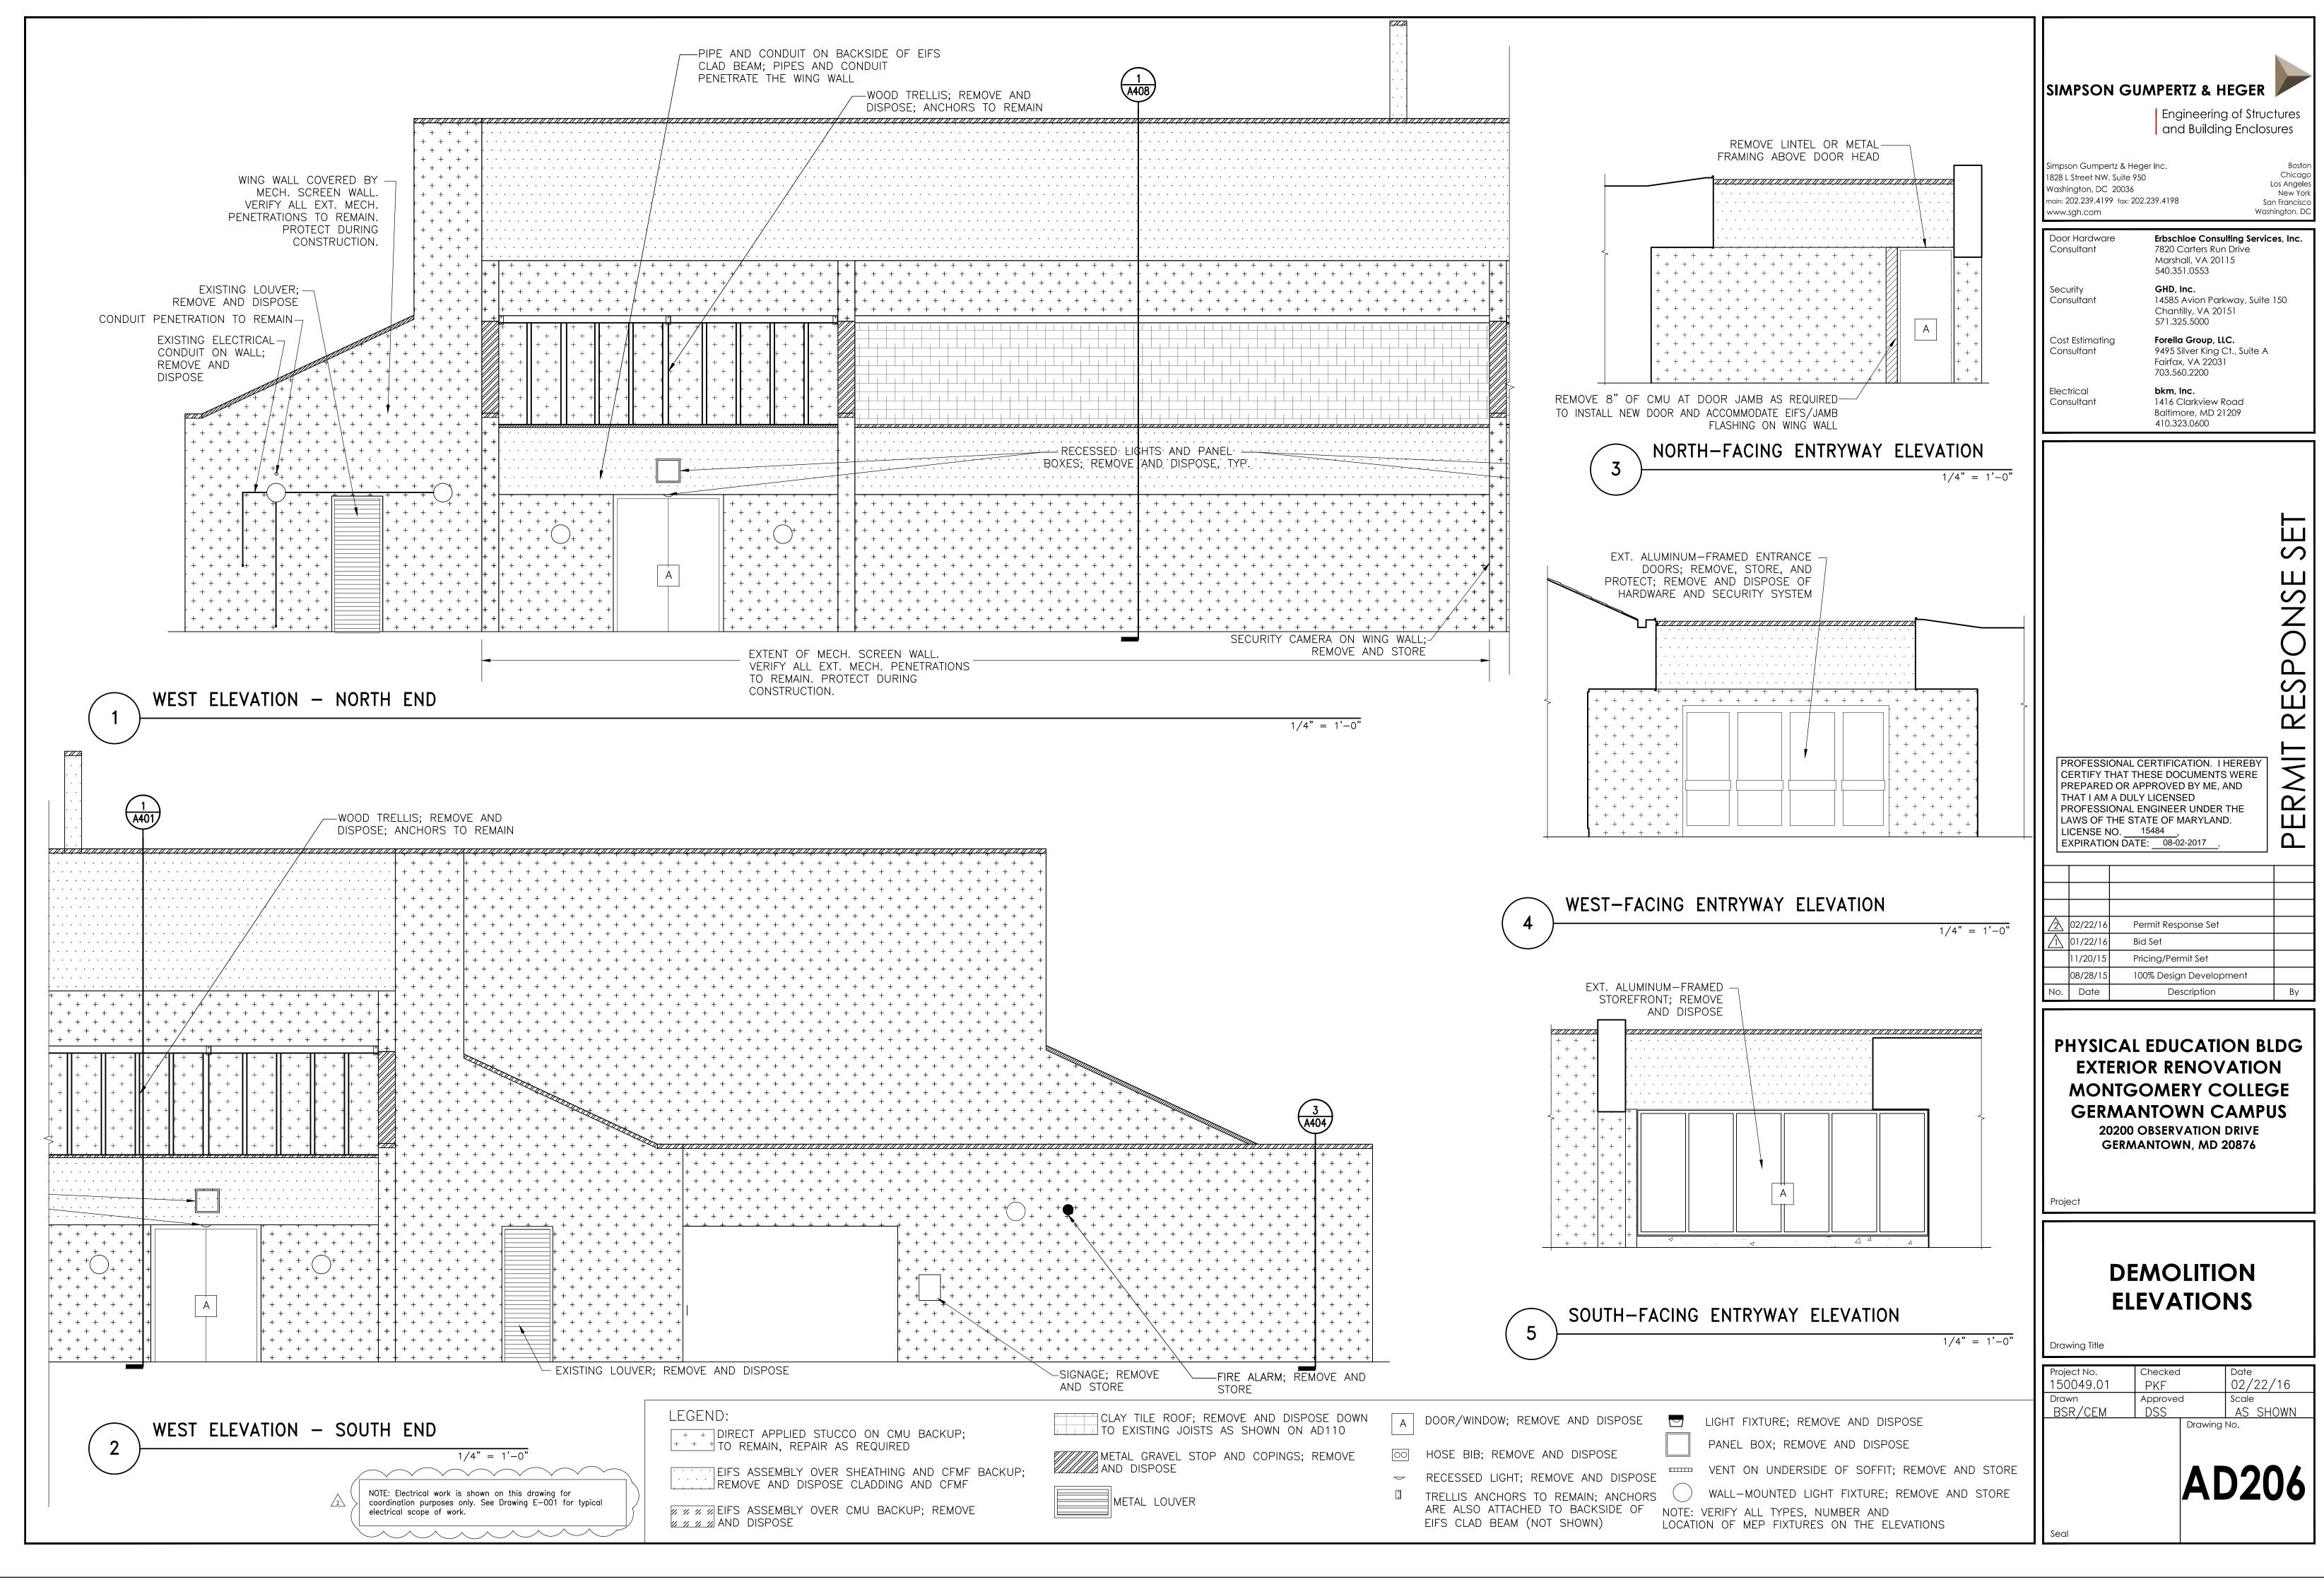
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Door Hardware Consultant	7820 Carters Run Marshall, VA 2011	
Security Consultant	540.351.0553 GHD, Inc. 14585 Avion Park Chantilly, VA 201 571.325.5000	
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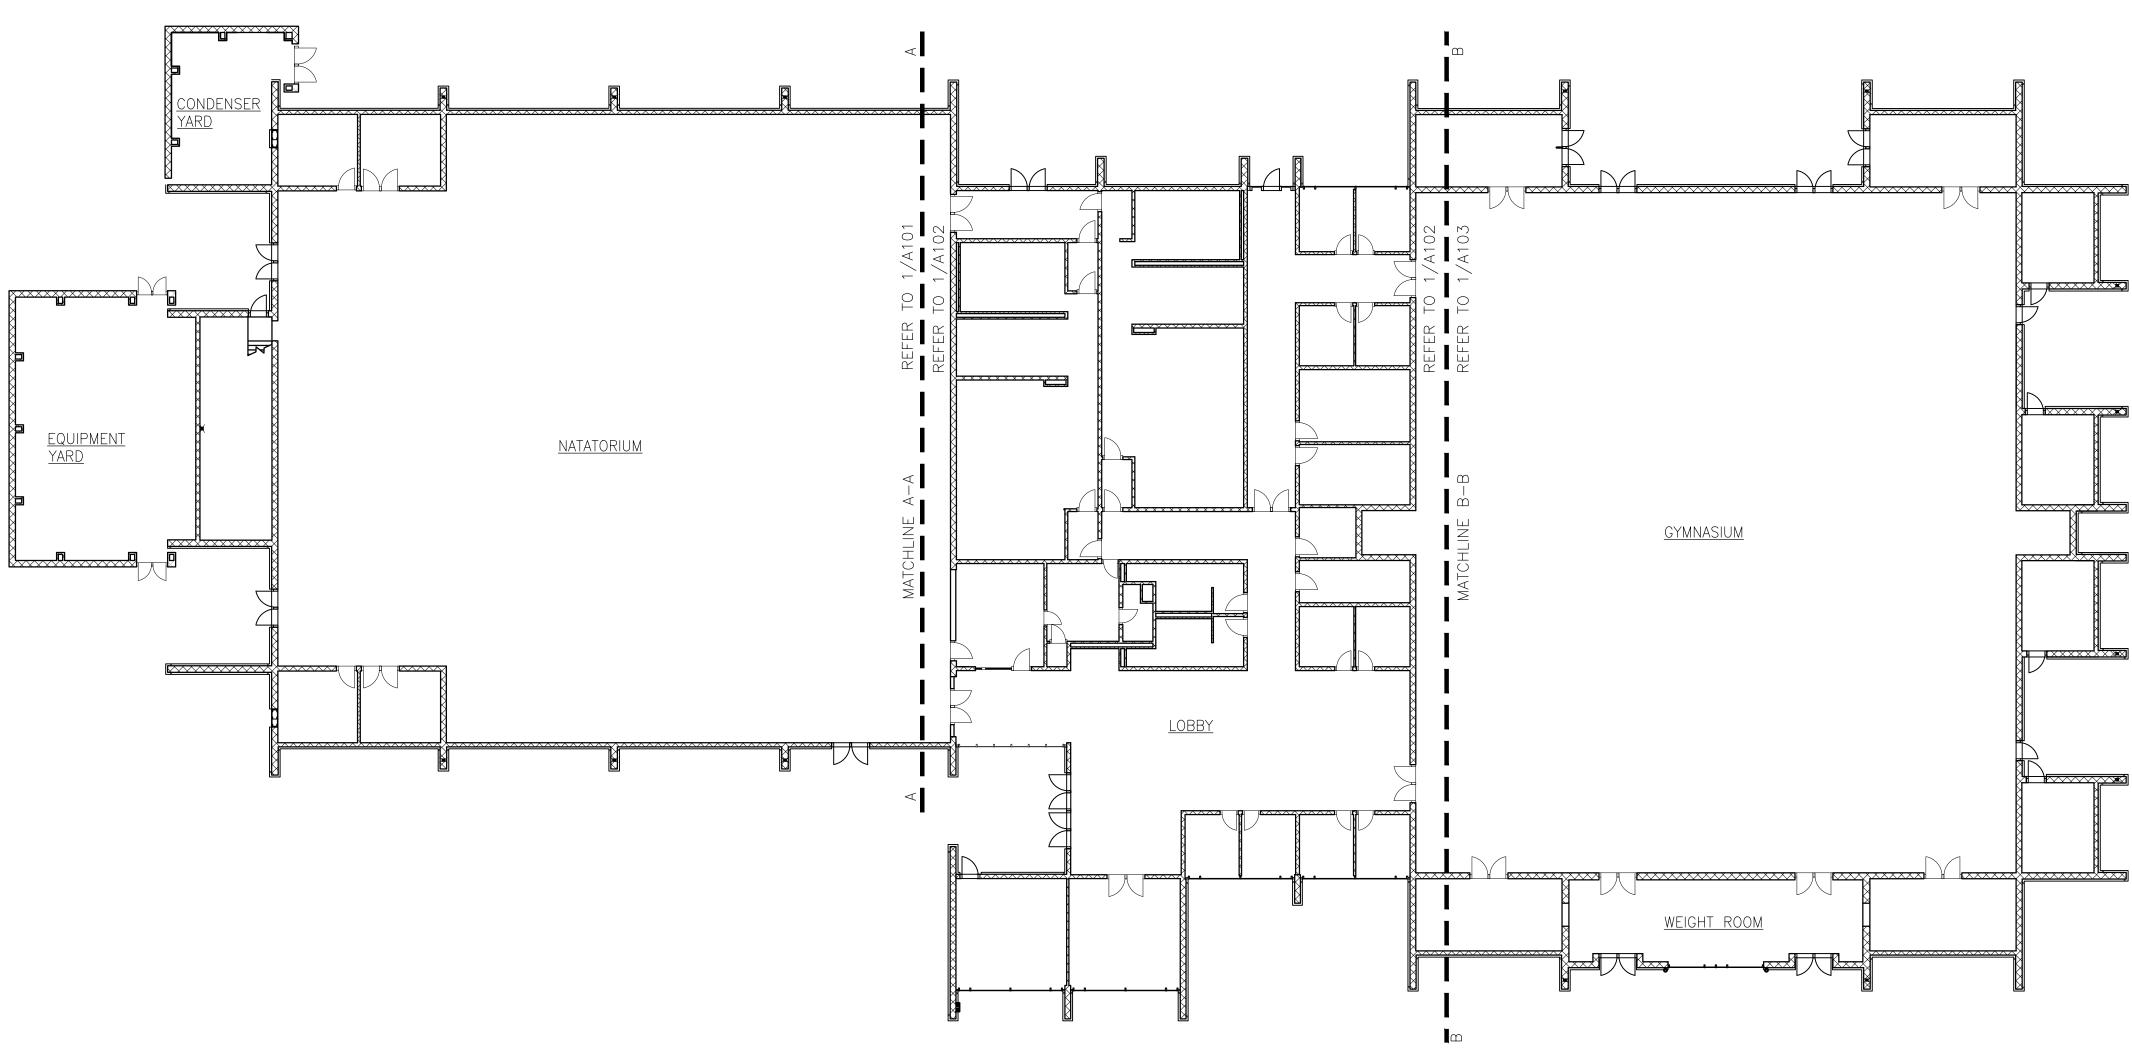
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main: 202.239.4199 fax: 202.2 www.sgh.com Door Hardware Consultant Security Consultant Electrical Consultant Electrical Consultant PROFESSIONAL CE CERTIFY THAT THE PREPARED OR APE THAT I AM A DULY I PROFESSIONAL EN LAWS OF THE STATE EXPIRATION DATE: 02/22/16	Erbschloe 7820 Carte Marshall, V 540.351.05 GHD, Inc. 14585 Avia Chantilly, V 571.325.50 Forella Gra 9495 Silver Fairfax, VA 703.560.22 bkm, Inc. 1416 Clark Baltimore, 410.323.06 SE DOCUM PROVED BY LICENSED NGINEER UN 5484 : 08-02-20 mit Response	Pris Run Drive (A 20115 53 on Parkway, S (A 20151 00 Dup, LLC. King Ct., Suit 22031 00 view Road MD 21209 00 View Road MD 21209 00 VIER THE YLAND.	suite 150
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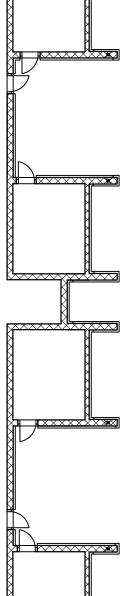





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1. Install CMU curb over existing footing below grade. 2. Patch over any areas of delaminated or missing stucco cladding on the CMU walls with a cementitious parge coat to provide a smooth backup wall substrate. Repair all spalled or damaged CMU per structural drawings. 3. Replace the existing downleaders in the CMU wing walls with new downleaders and tie into the existing drainage assembly. Provide new downleaders in the CMU wing walls where shown on the drawings. Patch the CMU wing walls to provide a smooth substrate over the downleaders. 4. Provide new C.F.M.F. and furrings at the upper and lower soffits, and at vertical

exterior wall areas where shown on the drawings. locate framing along the underside of the soffits to account for the increased exterior insulation thickness and maintain existing elevation of the soffit finish and window/door

5. Provide new exterior gypsum sheathing over the upper and lower soffit framing and furrings and over framed exterior wall areas.

6. Extend existing electrical, plumbing, and mechanical fixtures and other miscellaneous components out of the wall to accommodate the increased

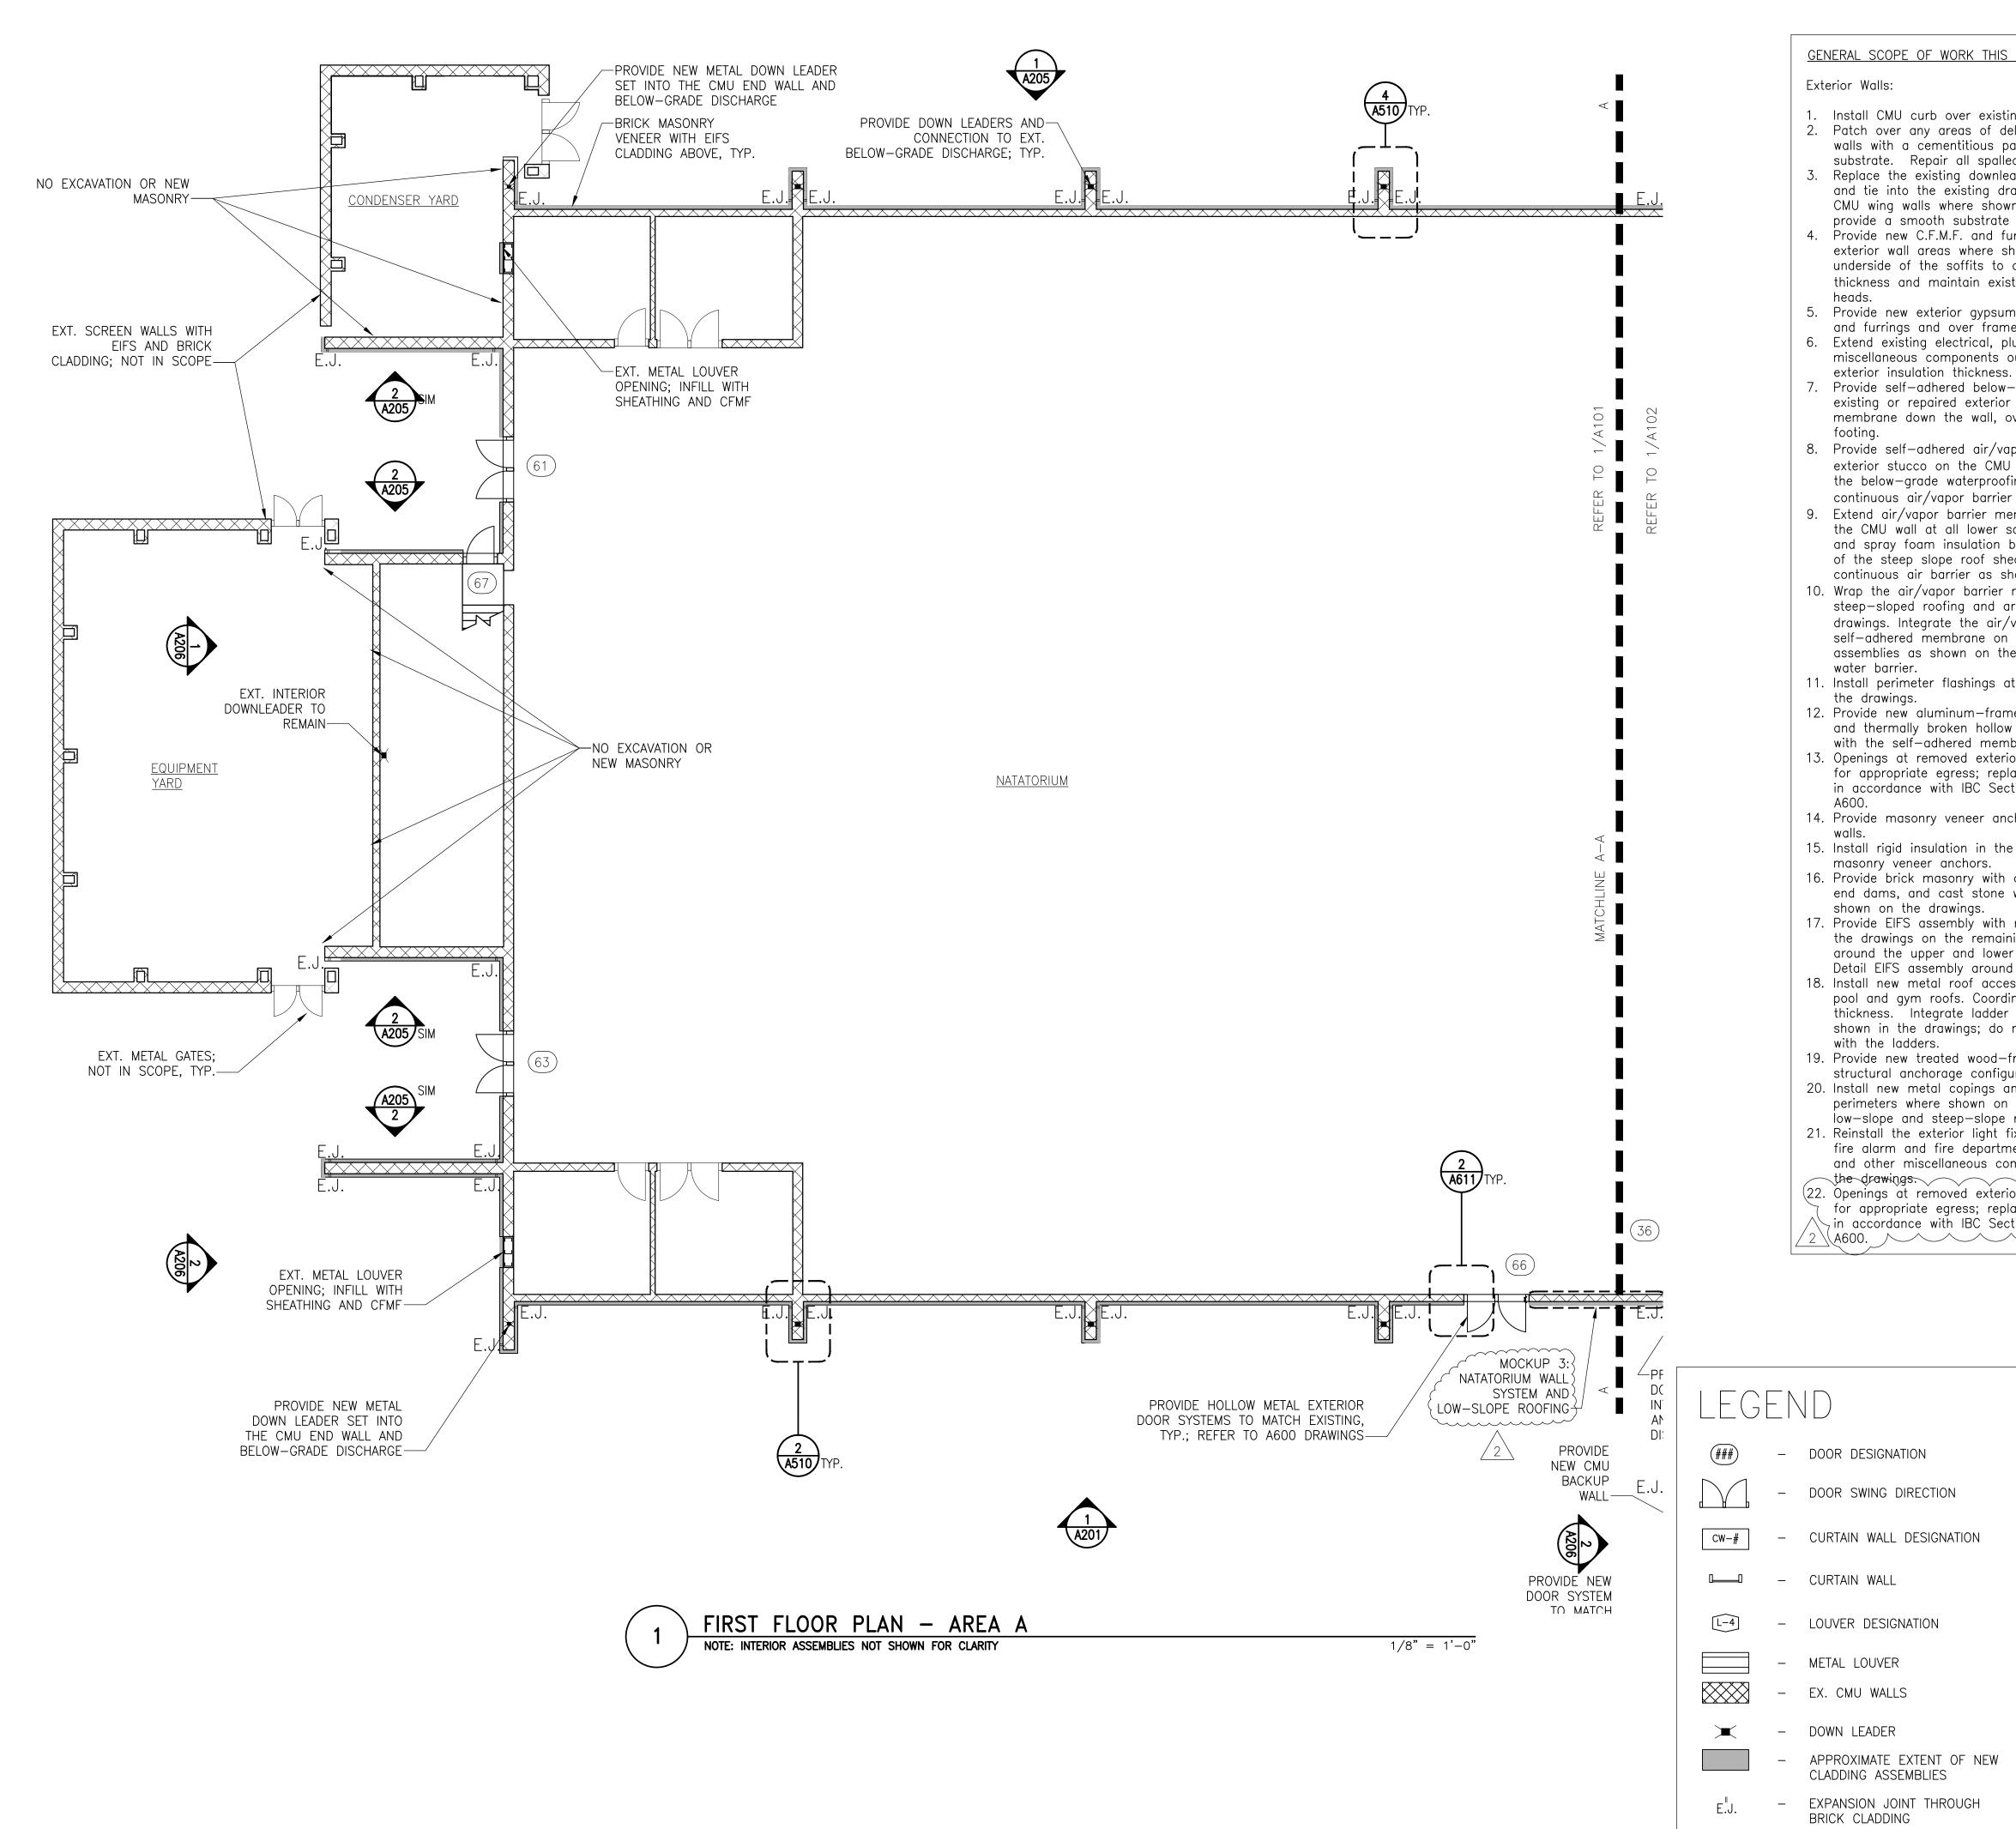7. Provide self-adhered below-grade waterproofing membrane over the base of the existing or repaired exterior stucco on the CMU walls. extend the self-adhered membrane down the wall, over the new curb, and to the top of the existing

8. Provide self-adhered air/vapor barrier membrane over the existing or repaired exterior stucco on the CMU walls. Integrate the air/vapor barrier membrane with the below-grade waterproofing and the roofing assembly to provide a continuous air/vapor barrier system.

9. Extend air/vapor barrier membrane past the soffit cladding and to the top of the CMU wall at all lower soffits below steep-sloped roofs. Provide metal lath and spray foam insulation between the top of the CMU wall and the underside of the steep slope roof sheathing, around the sloped beams, to form a continuous air barrier as shown on the drawings.

10. Wrap the air/vapor barrier membrane around lower soffits not below steep-sloped roofing and around the upper soffits, where shown on the drawings. Integrate the air/vapor barrier membrane with the adjacent self-adhered membrane on the vertical exterior walls and steep-slope roofing

assemblies as shown on the drawings to maintain a continuous air, vapor, and 11. Install perimeter flashings at all exterior door and window openings as shown on

12. Provide new aluminum-framed exterior storefront and entrances, curtain walls,

and thermally broken hollow metal doors. integrate the fenestration components with the self-adhered membrane on the exterior walls. 13. Openings at removed exterior doors serving as exit doors must be maintained for appropriate egress; replacement doors must have appropriate panic hardware

in accordance with IBC Section 1010.1.9.9 and Section 1010.1.10, as shown on 14. Provide masonry veneer anchors around the bottom perimeter of the first floor

15. Install rigid insulation in the exterior wall cavity between and around the

16. Provide brick masonry with dedicated through-wall flashing, weeps, mortar net, end dams, and cast stone water table around the base of the exterior walls as

17. Provide EIFS assembly with metal lath and insulation thicknesses as shown in the drawings on the remaining exterior walls above the cast stone water table, around the upper and lower soffits, and other locations shown on the drawings. Detail EIFS assembly around exterior wall penetrations and other components. 18. Install new metal roof access ladders extending from the low roof up to the pool and gym roofs. Coordinate ladder dimensions with the new cladding thickness. Integrate ladder supports with the new self-adhered membrane as

shown in the drawings; do not penetrate the new or existing roofing assemblies 19. Provide new treated wood-framed trellises. See structural drawings for new

structural anchorage configuration. 20. Install new metal copings and gravel edge stops at top of all walls and roof

perimeters where shown on the drawings; coordinate this work with the low-slope and steep-slope roofing installation


21. Reinstall the exterior light fixtures, security cameras, fans, louvers and vents, fire alarm and fire department connection, access hatches, electrical conduits, and other miscellaneous components over the EIFS unless otherwise described in the drawings.


(22. Openings at removed exterior doors serving as exit doors must be maintained for appropriate egress; replacement doors must have appropriate panic hardware \succ in accordance with IBC Section 1010.1.9.9 and Section 1010.1.10, as shown on) $2 \Lambda 600.$

SIMPSON GUMPERTZ & HEGER

Engineering of Structures and Building Enclosures

Simpson Gumpertz & Heger Inc. Bos Chicag 1828 L Street NW, Suite 950 Los Angeles Washington, DC 20036 New York main: 202.239.4199 fax: 202.239.4198 San Francisco www.sgh.com Washington, DC Door Hardware Erbschloe Consulting Services, Inc. Consultant 7820 Carters Run Drive Marshall, VA 20115 540.351.0553 GHD, Inc. Security Consultant 14585 Avion Parkway, Suite 150 Chantilly, VA 20151 571.325.5000 Cost Estimating Forella Group, LLC. Consultant 9495 Silver King Ct., Suite A Fairfax, VA 22031 703.560.2200 bkm, Inc. Electrical Consultant 1416 Clarkview Road Baltimore, MD 21209 410.323.0600 ш $\boldsymbol{\mathcal{S}}$ Ш SZ Ο ĒSP $\mathbf{\mathcal{L}}$ Ī PROFESSIONAL CERTIFICATION. I HEREBY CERTIFY THAT THESE DOCUMENTS WERE PREPARED OR APPROVED BY ME, AND THAT I AM A DULY LICENSED \sim PROFESSIONAL ENGINEER UNDER THE LAWS OF THE STATE OF MARYLAND. Ш LICENSE NO. 15484 Δ EXPIRATION DATE: 08-02-2017 2 02/22/16 Permit Response Set 01/22/16 Bid Set 11/20/15 Pricing/Permit Set 08/28/15 100% Design Development No. Date Description PHYSICAL EDUCATION BLDG **EXTERIOR RENOVATION** MONTGOMERY COLLEGE GERMANTOWN CAMPUS 20200 OBSERVATION DRIVE GERMANTOWN, MD 20876 Project

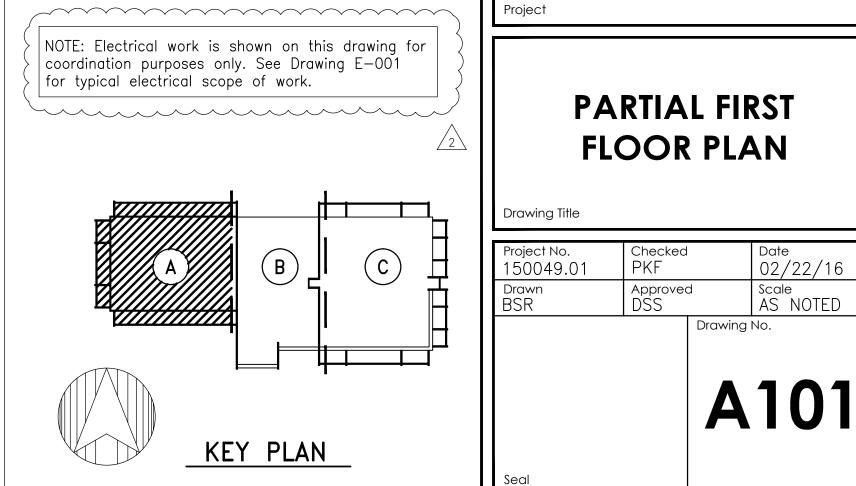

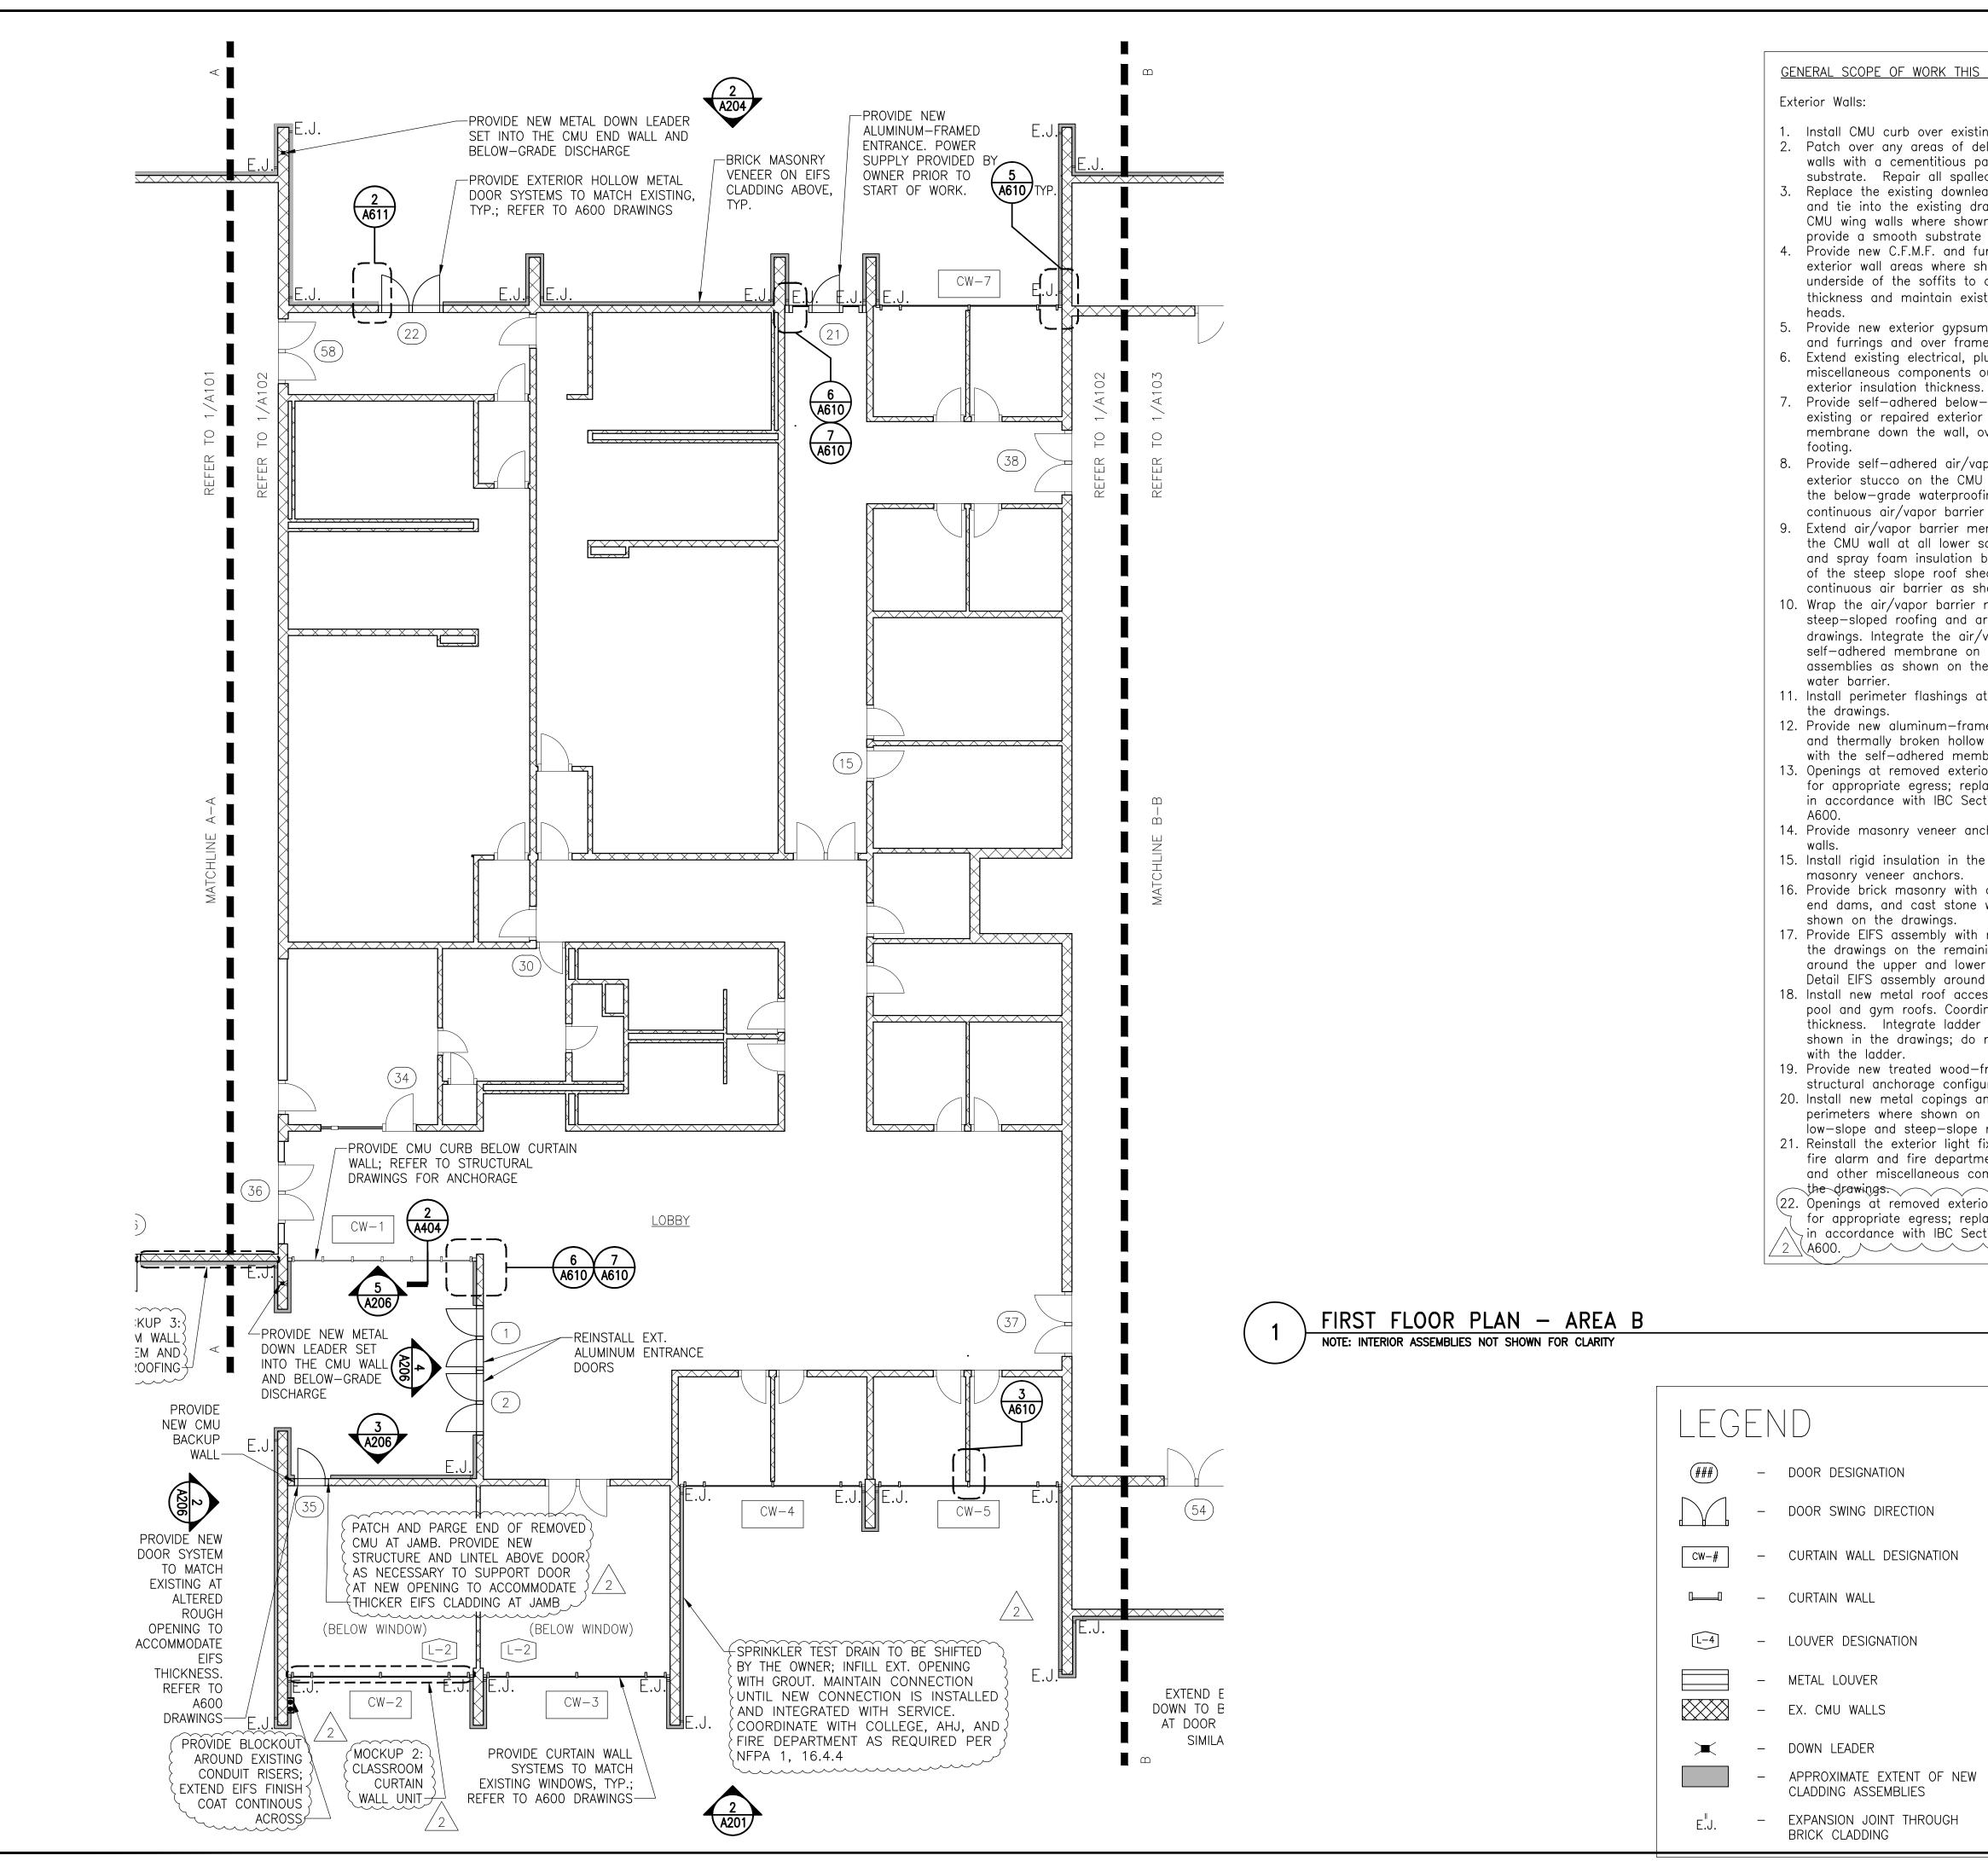

1. Install CMU curb over existing footing below grade. 2. Patch over any areas of delaminated or missing stucco cladding on the CMU walls with a cementitious parge coat to provide a smooth backup wall substrate. Repair all spalled or damaged CMU per structural drawings. 3. Replace the existing downleaders in the CMU wing walls with new downleaders and tie into the existing drainage assembly. Provide new downleaders in the CMU wing walls where shown on the drawings. Patch the CMU wing walls to provide a smooth substrate over the downleaders. 4. Provide new C.F.M.F. and furrings at the upper and lower soffits, and at vertical

exterior wall areas where shown on the drawings. locate framing along the underside of the soffits to account for the increased exterior insulation thickness and maintain existing elevation of the soffit finish and window/door

5. Provide new exterior gypsum sheathing over the upper and lower soffit framing and furrings and over framed exterior wall areas.

6. Extend existing electrical, plumbing, and mechanical fixtures and other miscellaneous components out of the wall to accommodate the increased

7. Provide self-adhered below-grade waterproofing membrane over the base of the existing or repaired exterior stucco on the CMU walls. extend the self-adhered membrane down the wall, over the new curb, and to the top of the existing

8. Provide self-adhered air/vapor barrier membrane over the existing or repaired exterior stucco on the CMU walls. Integrate the air/vapor barrier membrane with the below-grade waterproofing and the roofing assembly to provide a continuous air/vapor barrier system.

9. Extend air/vapor barrier membrane past the soffit cladding and to the top of the CMU wall at all lower soffits below steep-sloped roofs. Provide metal lath and spray foam insulation between the top of the cmu wall and the underside of the steep slope roof sheathing, around the sloped beams, to form a continuous air barrier as shown on the drawings.

10. Wrap the air/vapor barrier membrane around lower soffits not below steep-sloped roofing and around the upper soffits, where shown on the drawings. Integrate the air/vapor barrier membrane with the adjacent self-adhered membrane on the vertical exterior walls and steep-slope roofing

assemblies as shown on the drawings to maintain a continuous air, vapor, and

11. Install perimeter flashings at all exterior door and window openings as shown on

12. Provide new aluminum-framed exterior storefront and entrances, curtain walls, and thermally broken hollow metal doors. integrate the fenestration components with the self-adhered membrane on the exterior walls.

13. Openings at removed exterior doors serving as exit doors must be maintained for appropriate egress; replacement doors must have appropriate panic hardware in accordance with IBC Section 1010.1.9.9 and Section 1010.1.10, as shown on

14. Provide masonry veneer anchors around the bottom perimeter of the first floor

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perimeters where shown on the drawings; coordinate this work with the low-slope and steep-slope roofing installation

21. Reinstall the exterior light fixtures, security cameras, fans, louvers and vents, fire alarm and fire department connection, access hatches, electrical conduits, and other miscellaneous components over the EIFS unless otherwise described in the drawings.

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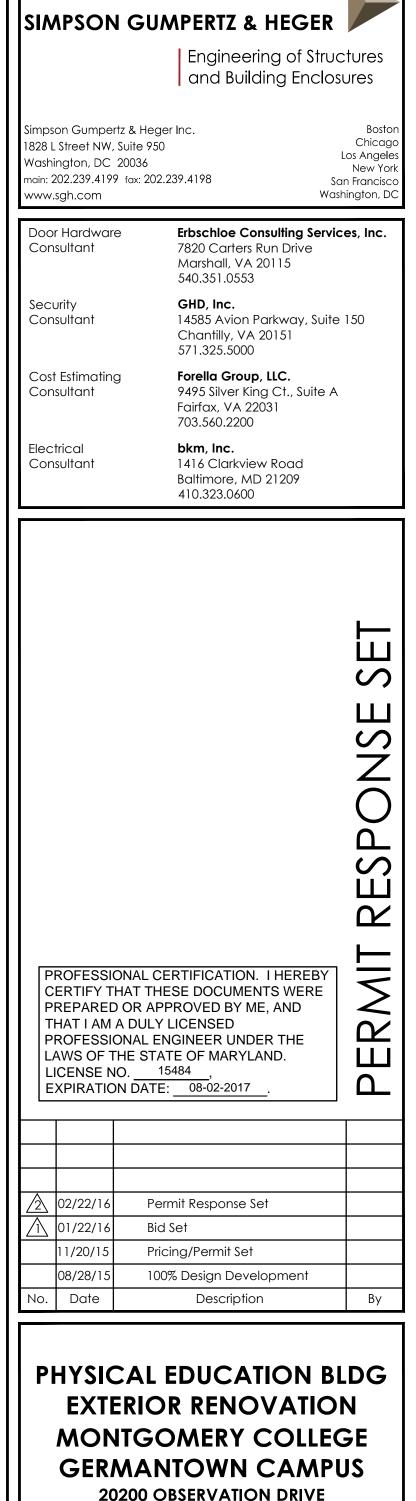
> 1/8" = 1'-0"NOTE: Electrical work is shown on this drawing for coordination purposes only. See Drawing E-001

> > for typical electrical scope of work.

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KEY PLAN

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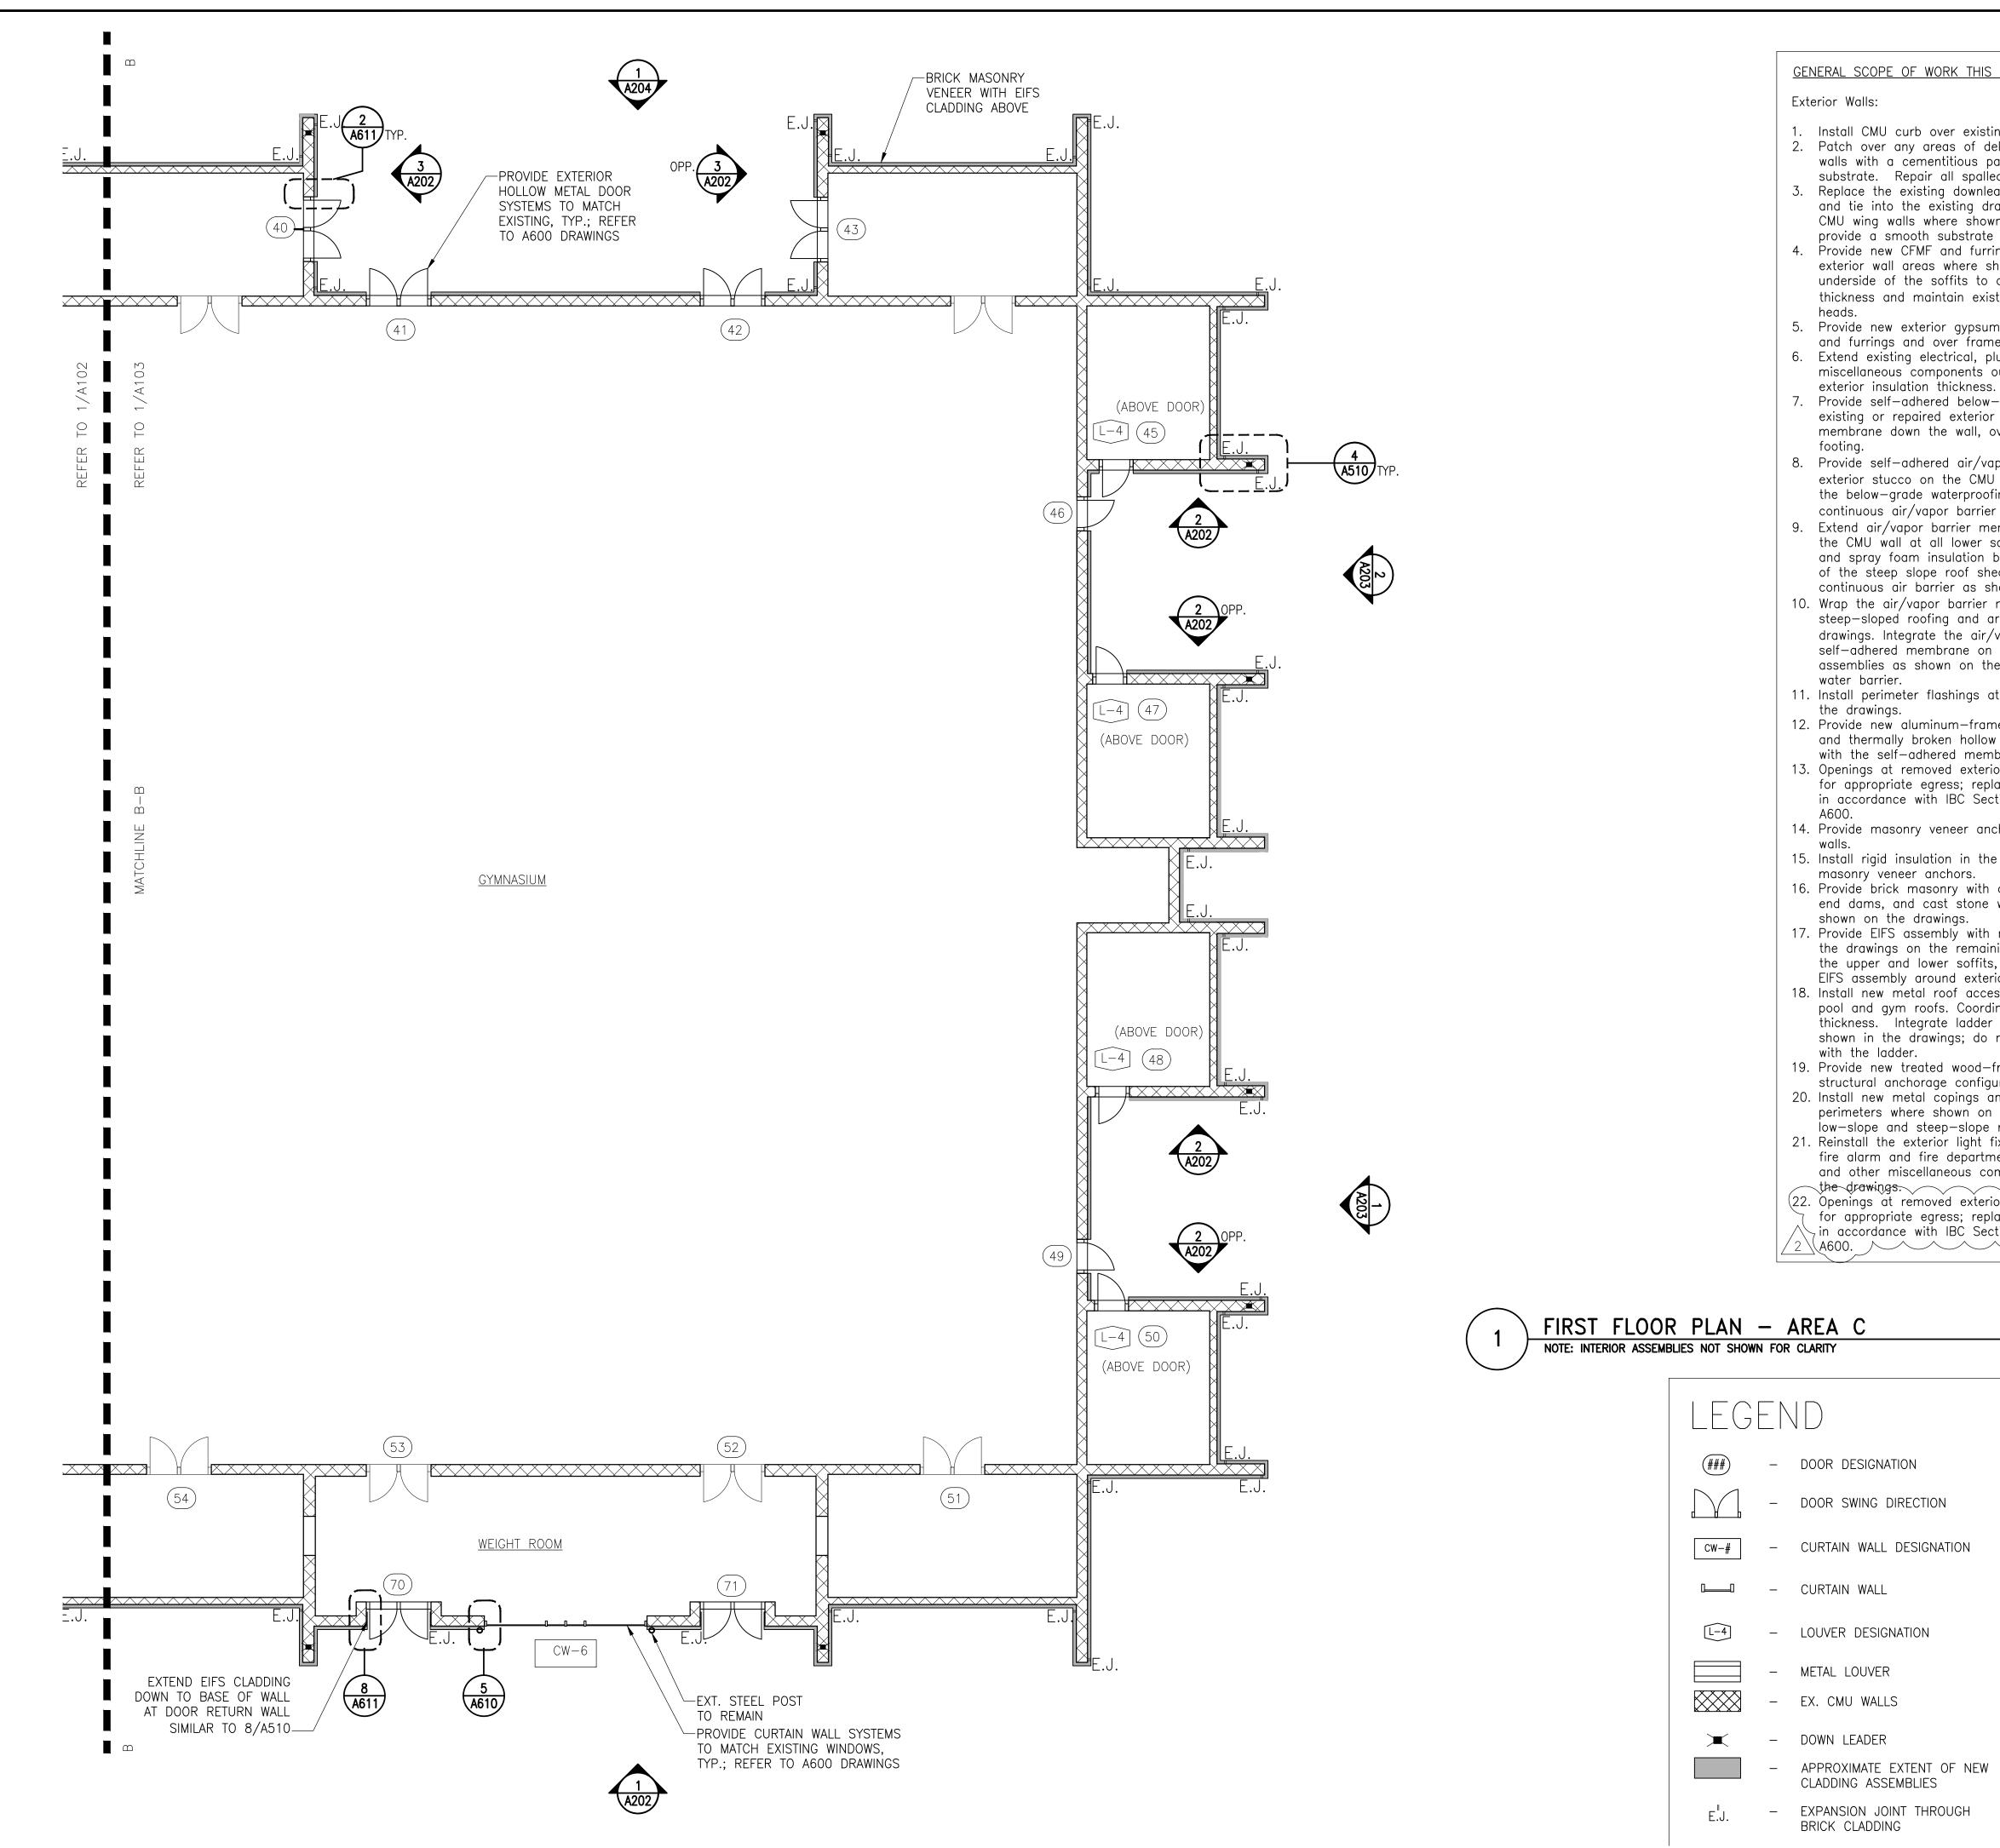
GERMANTOWN, MD 20876

Project

Seal

PARTIAL FIRST FLOOR PLAN

Drawing Title Checked roiect No 02/22/16 150049.01 PKF Drawn Approved Scale AS NOTED BSR DSS Drawing No. A102



1. Install CMU curb over existing footing below grade. 2. Patch over any areas of delaminated or missing stucco cladding on the CMU walls with a cementitious parge coat to provide a smooth backup wall substrate. Repair all spalled or damaged CMU per structural drawings. 3. Replace the existing downleaders in the CMU wing walls with new downleaders and tie into the existing drainage assembly. Provide new downleaders in the CMU wing walls where shown on the drawings. Patch the CMU wing walls to provide a smooth substrate over the downleaders. 4. Provide new CFMF and furrings at the upper and lower soffits, and at vertical

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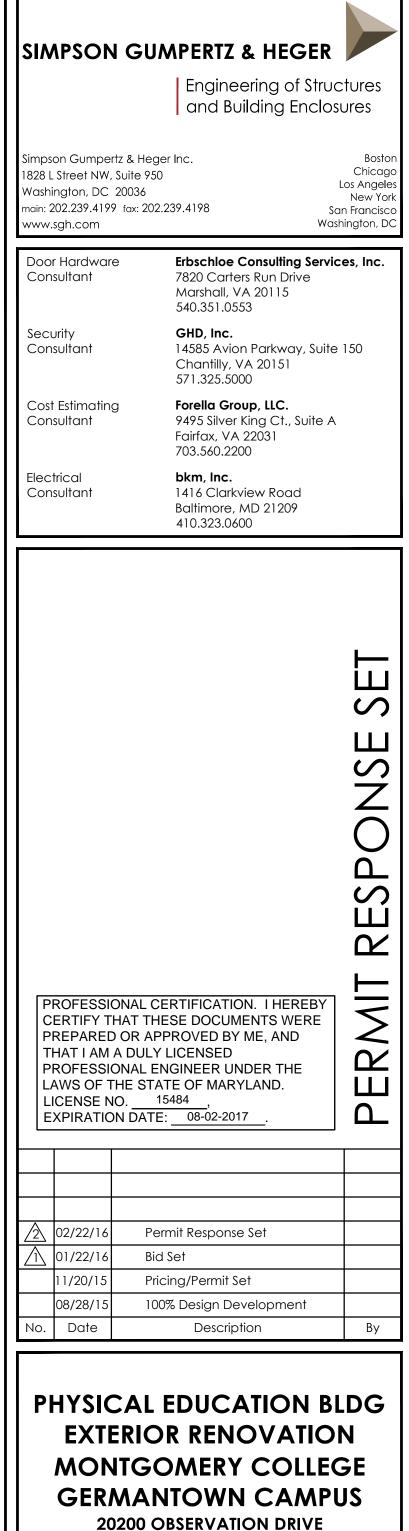
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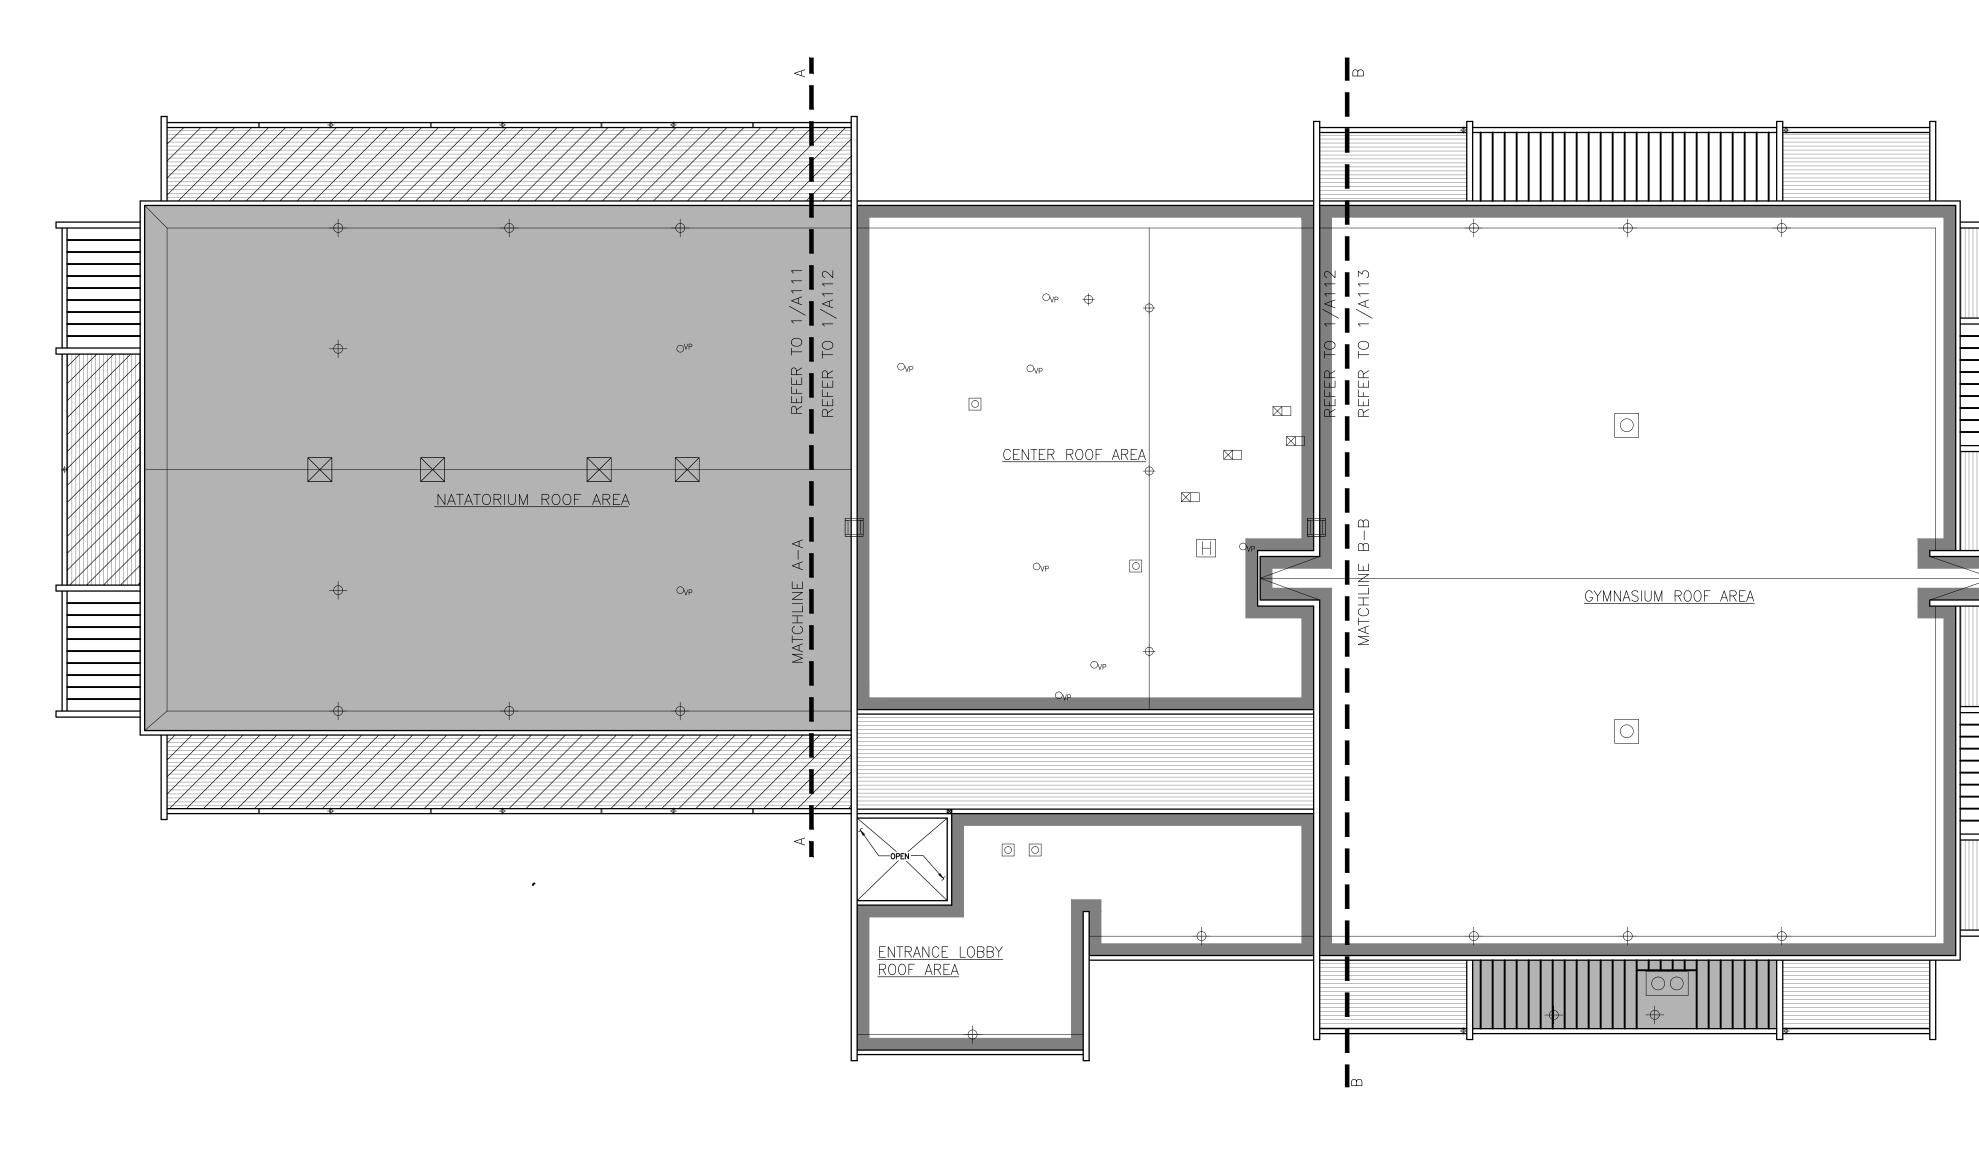
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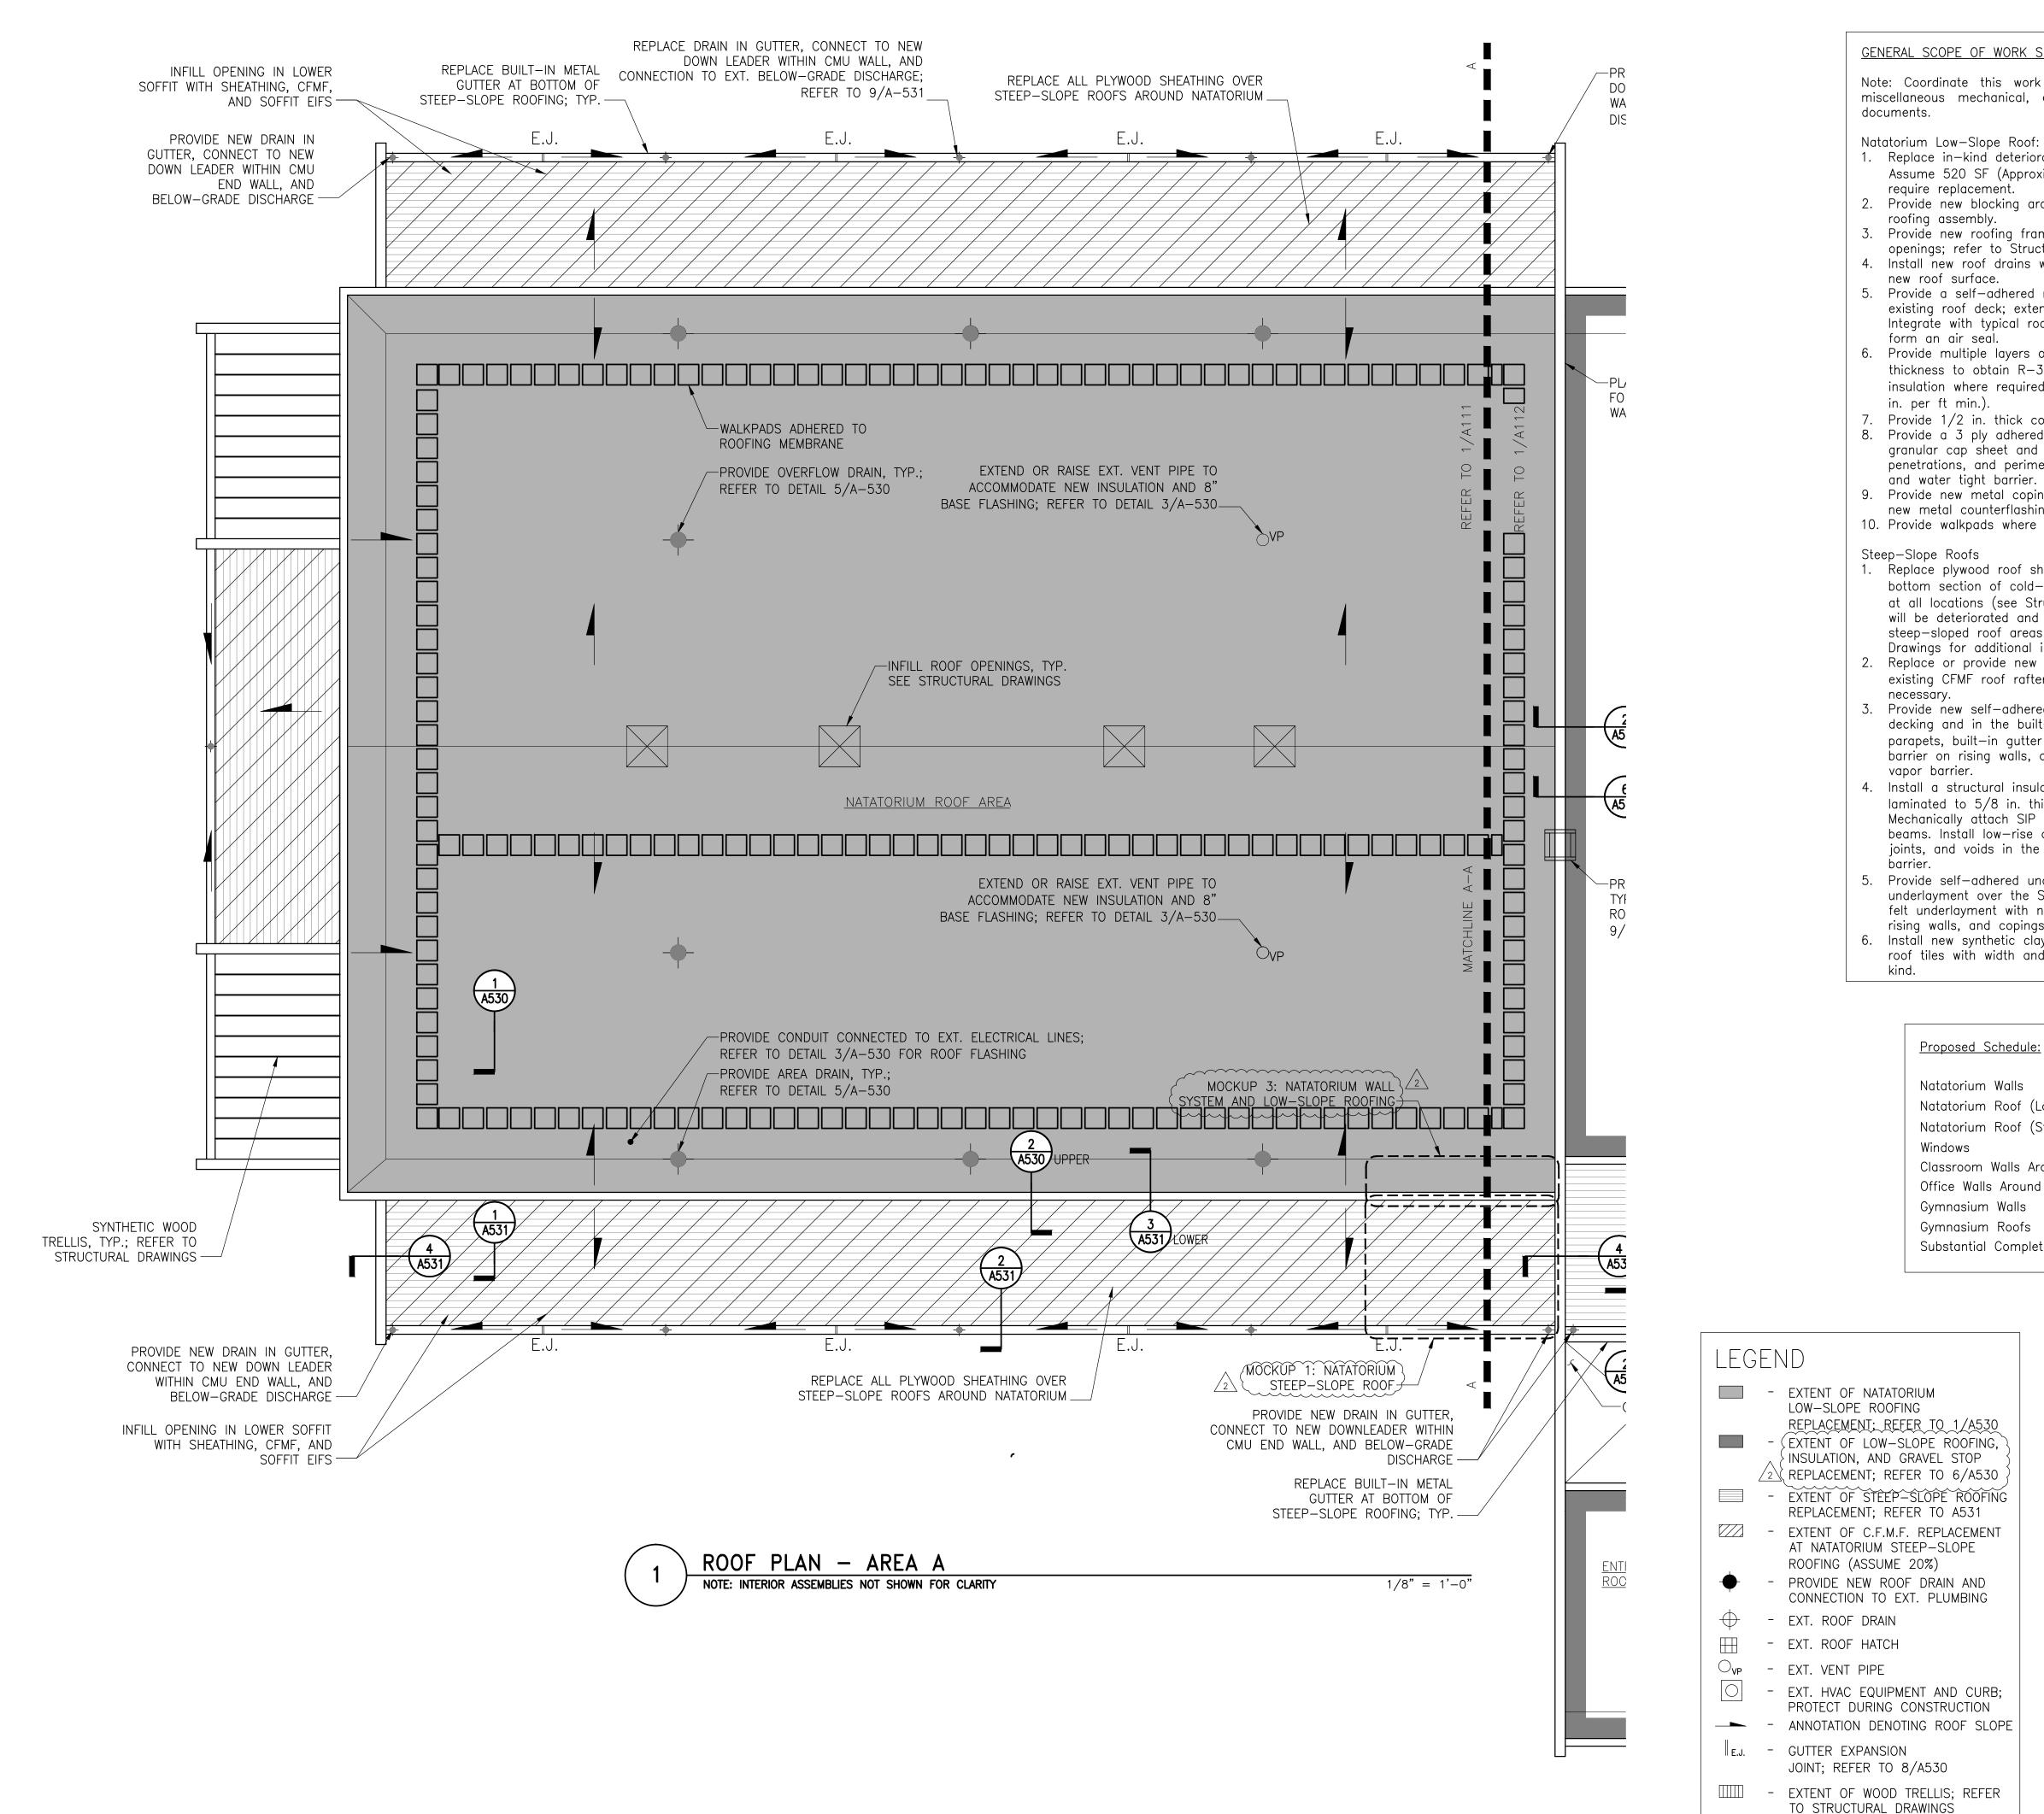
ROOF PLAN - OVERALL NOTE: INTERIOR ASSEMBLIES NOT SHOWN FOR CLARITY

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1/16" = 1'-0"



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PHYSICAL EDUCATION BL EXTERIOR RENOVATION MONTGOMERY COLLEC GERMANTOWN CAMPL 20200 OBSERVATION DRIVE GERMANTOWN, MD 20876	N FE	RENOVATION AERY COLLEGI OWN CAMPUS ERVATION DRIVE		
INSULATION, AND GRAVEL STOP Drawn Approved Scale Image: Construction of the state of the s	′16 ED	cked Date 02/22/1 oved Scale AS NOTEI	EXTENT OF NATATORIUM LOW-SLOPE ROOFING REPLACEMENT; REFER T EXTENT OF LOW-SLOPE INSULATION, AND GRAVE REPLACEMENT; REFER T EXTENT OF STEEP-SLO REPLACEMENT; REFER T EXTENT OF CFMF. BEAN REPLACEMENT AT STEEF ROOFING; ASSUME 20%	



GENERAL SCOPE OF WORK SHOWN ON THIS DRAWING:

Note: Coordinate this work with the surrounding work, related trades, and miscellaneous mechanical, electrical, and plumbing work required in these

1. Replace in-kind deteriorated portions of the existing wood decking. Assume 520 SF (Approximately 5%) of the Natatorium roof deck will

2. Provide new blocking around the roof perimeter to support the new roofing assembly.

3. Provide new roofing framing and sheathing over existing HVAC curbs and openings; refer to Structural Drawings. 4. Install new roof drains with extension flange to elevate drain bowl with

new roof surface. 5. Provide a self-adhered membrane vapor retarder continuously over the existing roof deck; extend up parapets, penetrations and other curbs. Integrate with typical roof drains, penetrations, and perimeter conditions to form an air seal.

6. Provide multiple layers of adhered rigid insulation; build up insulation thickness to obtain R-30 (6 in. thick). Provide additional tapered insulation where required with slope to drain toward internal drains (1/4 in. per ft min.).

7. Provide 1/2 in. thick cover board, set in adhesive. 8. Provide a 3 ply adhered modified bitumen roofing assembly with a granular cap sheet and base flashings. Integrate with typical roof drains, penetrations, and perimeter conditions to form continuous roofing system and water tight barrier. 9. Provide new metal coping and gravel stop around roof perimeter. Provide

new metal counterflashings and penetration flashings. 10. Provide walkpads where shown on the drawings.

Steep-Slope Roofs

1. Replace plywood roof sheathing. Around the Natatorium, replace the bottom section of cold-formed metal framing (CFMF) over the lower soffit at all locations (see Structural Drawings). Assume additional ext. beams will be deteriorated and require complete replacement at 20% of the steep-sloped roof areas in addition to the lower soffits. See Structural Drawings for additional information.

2. Replace or provide new unfaced fiberglass batt insulation between the existing CFMF roof rafters (min R-19) where structural repairs are

Provide new self-adhered membrane underlayment over the plywood decking and in the built—in gutter. Integrate with the surrounding parapets, built—in gutter drain and downleader, backup wall air/vapor barrier on rising walls, and perimeter coping to form a watertight air and vapor barrier.

4. Install a structural insulated panel (SIP) with 4 in. minimum insulation laminated to 5/8 in. thick plywood sheathing (R-20 minimum). Mechanically attach SIP panels to the plywood decking over the CFMF beams. Install low-rise closed cell spray foam where required at edges, joints, and voids in the SIP panels to provide a continuous thermal

5. Provide self—adhered underlayment and one layer of 15# felt underlayment over the SIP panels; integrate self-adhered membrane and felt underlayment with new perimeter metal flashings at built-in gutter, rising walls, and copings to form a continuous watertight barrier. 6. Install new synthetic clay tiles with a minimum 3 in. head lap; provide roof tiles with width and exposure sized to match existing clay tiles in

Proposed Schedule:


Natatorium Walls Natatorium Roof (Low-Slope)

- Natatorium Roof (Steep-Slope)
- Windows Classroom Walls Around Windows - August 2016
- Office Walls Around Windows
- Gymnasium Walls
- Gymnasium Roofs
- Substantial Completion
- July 2016 – August 2016 – August 2016 - October/November 2016


– July 2016


– August 2016

– December 2016 – August 2017

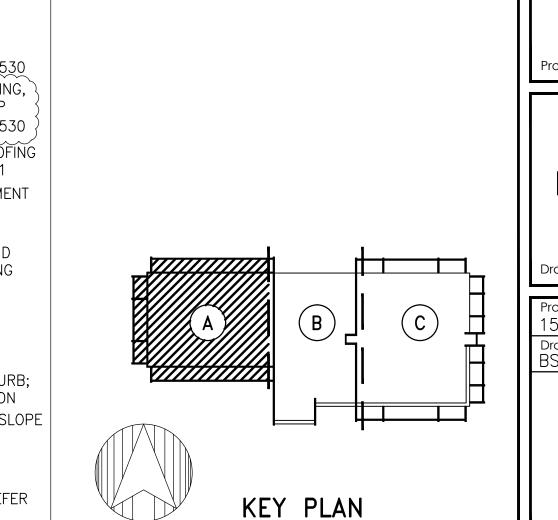

Seal

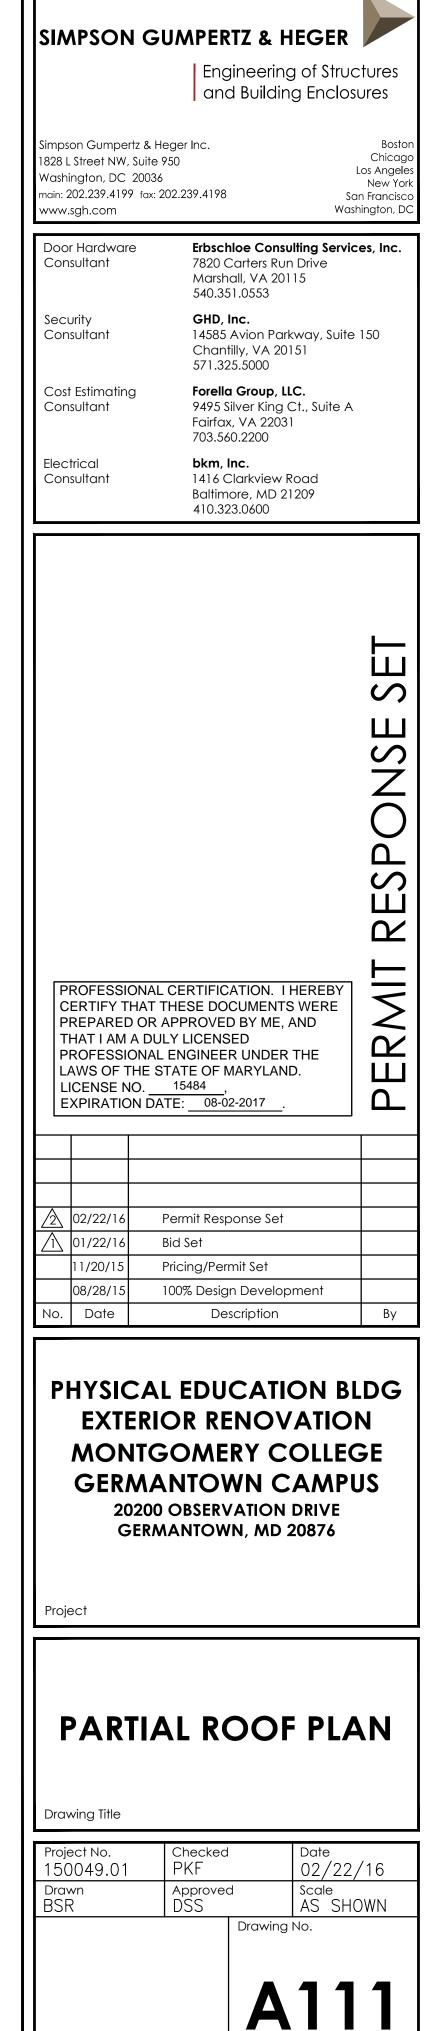

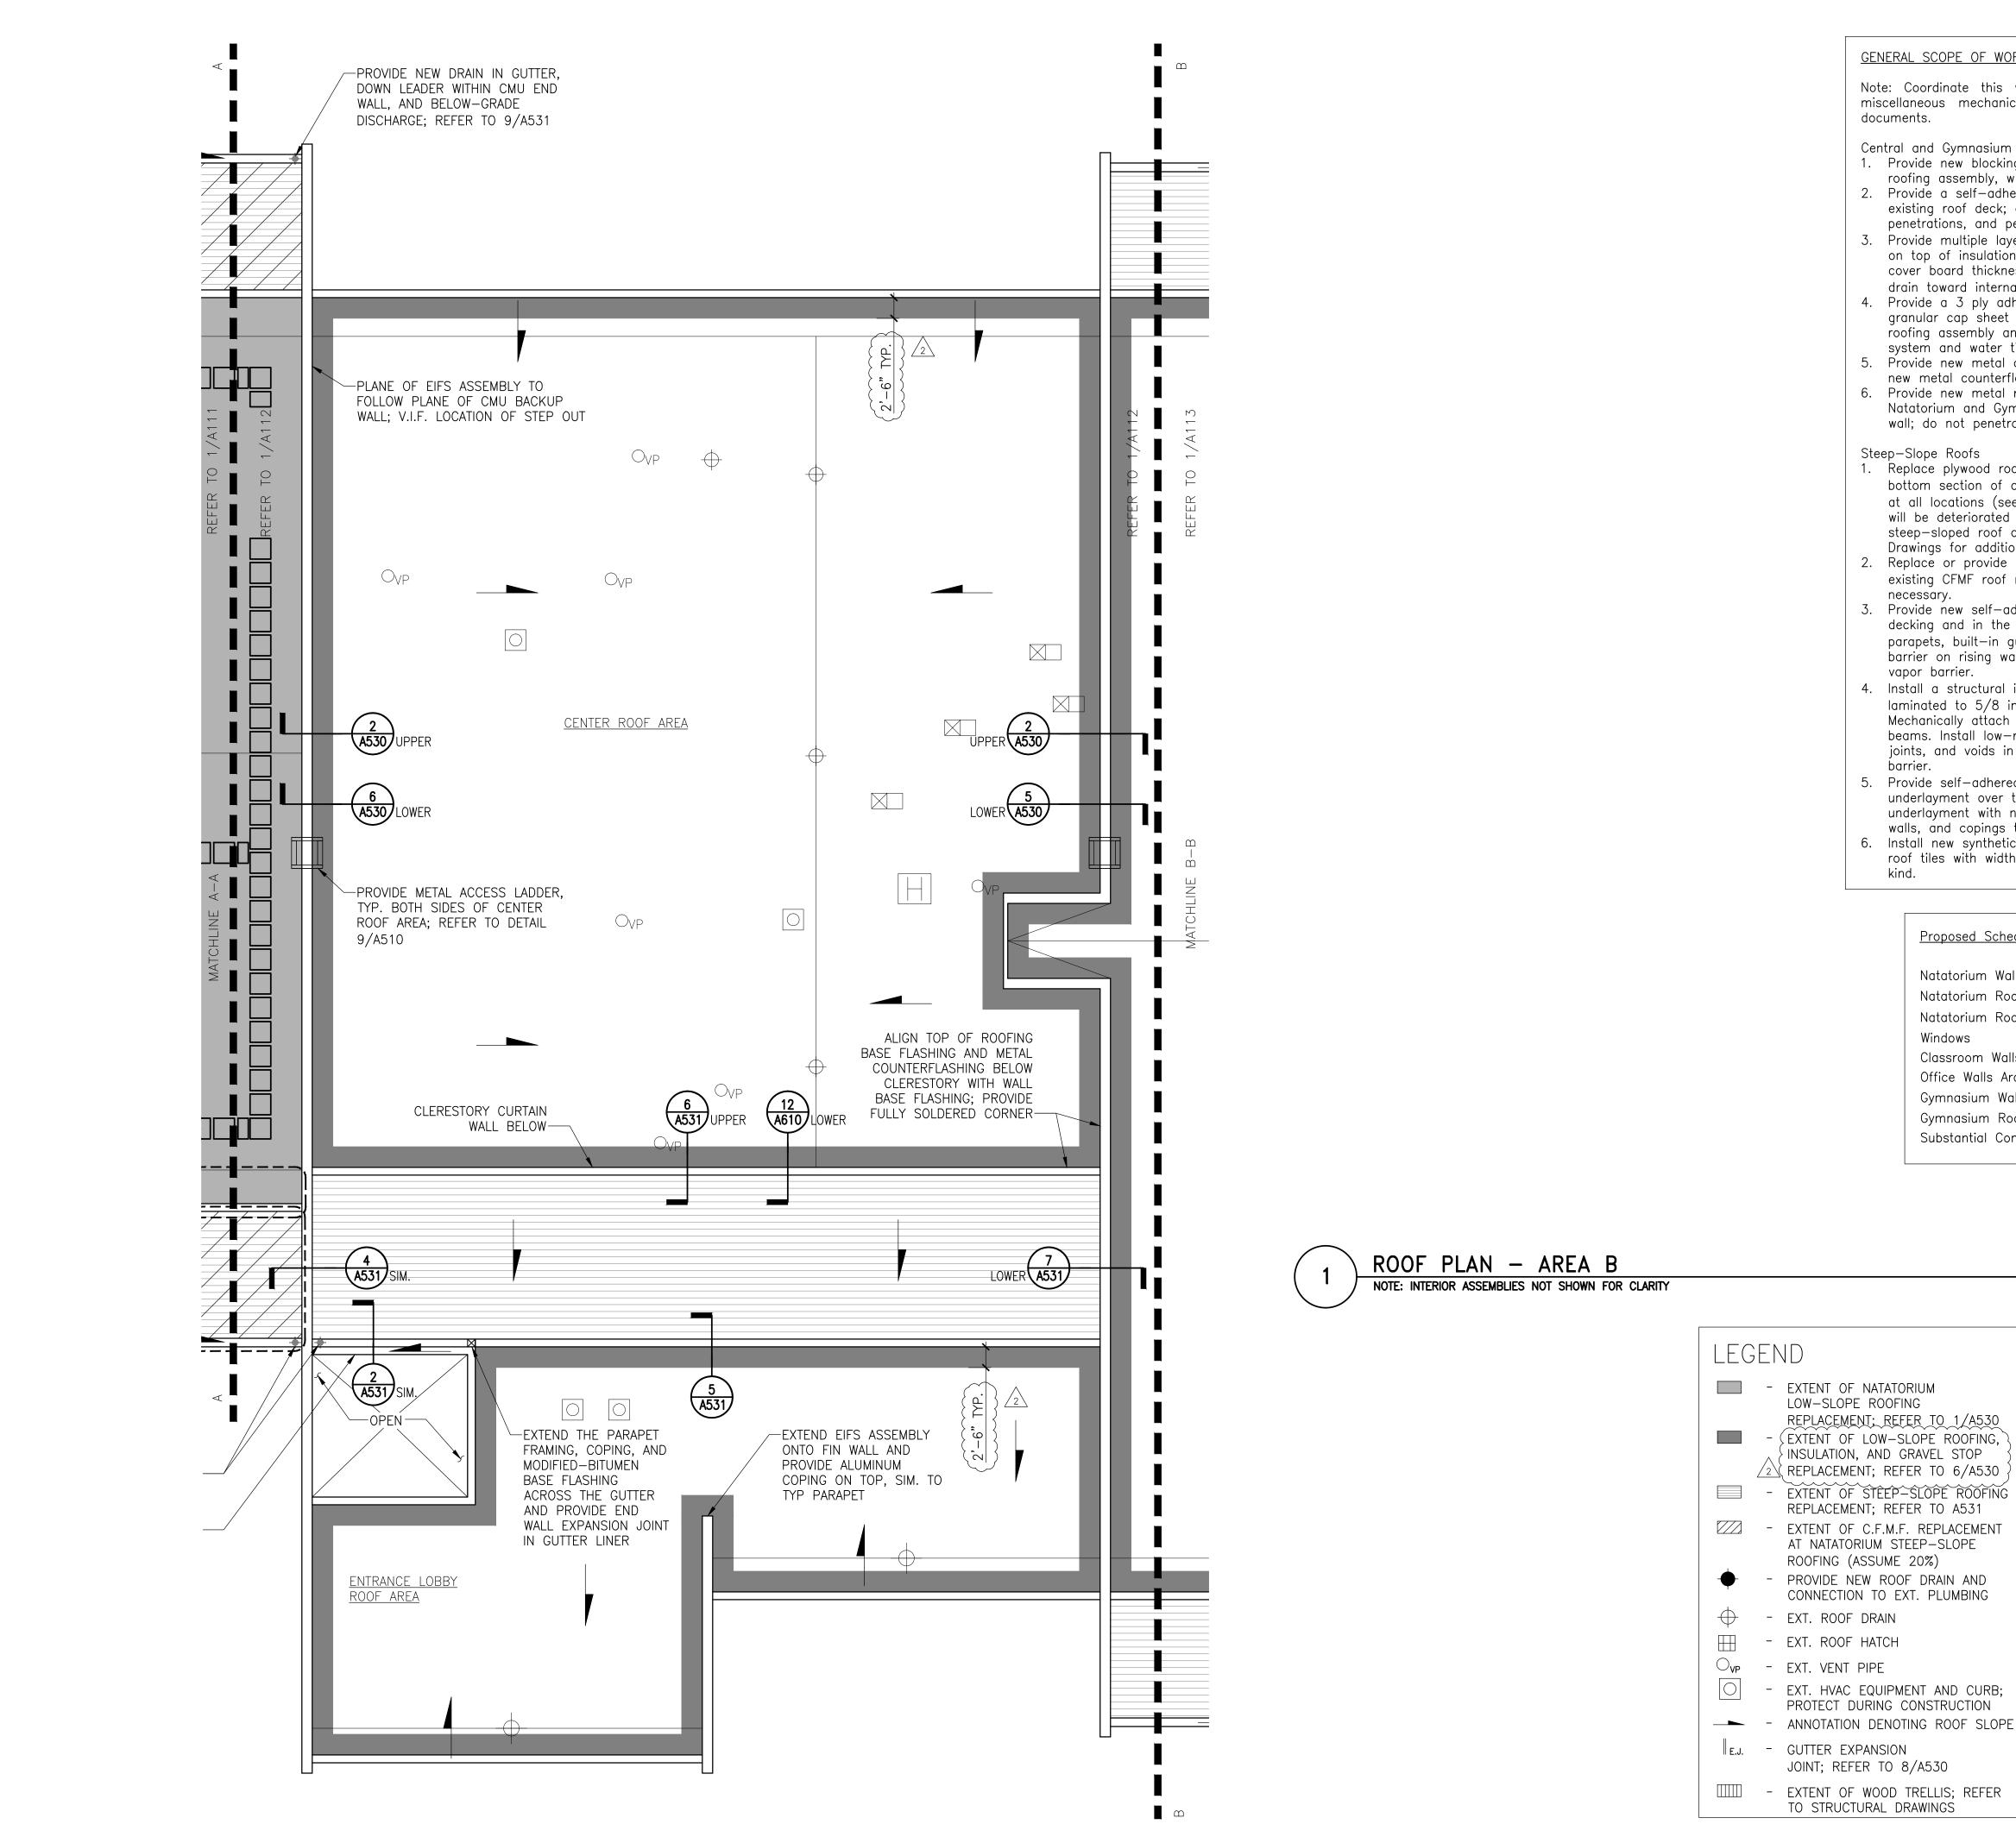

GENERAL SCOPE OF WORK SHOWN ON THIS DRAWING:

Note: Coordinate this work with the surrounding work, related trades, and miscellaneous mechanical, electrical, and plumbing work required in these

Central and Gymnasium Roof Areas: 1. Provide new blocking around the roof perimeter to support the new roofing assembly, where necessary.

2. Provide a self-adhered membrane vapor retarder continuously over the existing roof deck; extend up parapets. Integrate with typical roof drains, penetrations, and perimeter conditions to form an air seal.

3. Provide multiple layers of rigid insulation with 1/2 in. thick cover board on top of insulation. Set all layers in adhesive; build up insulation and cover board thickness to match existing insulation thickness with slope to drain toward internal drains (1/4 in. per ft).

4. Provide a 3 ply adhered modified bitumen roofing assembly with a granular cap sheet and base flashings. Integrate with adjacent existing roofing assembly and perimeter conditions to form continuous roofing system and water tight barrier as shown on the Drawings. 5. Provide new metal coping and gravel stop around roof perimeter. Provide new metal counterflashings.

6. Provide new metal roof access ladders from the low roof up to the Natatorium and Gymnasium roofs. Anchor access ladders to the exterior wall; do not penetrate roofing membrane.

1. Replace plywood roof sheathing. Around the Natatorium, replace the bottom section of cold-formed metal framing (CFMF) over the lower soffit at all locations (see Structural Drawings). Assume additional ext. beams will be deteriorated and require complete replacement at 20% of the steep-sloped roof areas in addition to the lower soffits. See Structural Drawings for additional information.

2. Replace or provide new unfaced fiberglass batt insulation between the existing CFMF roof rafters (min R-19) where structural repairs are

Provide new self-adhered membrane underlayment over the plywood decking and in the built-in gutter. Integrate with the surrounding parapets, built—in gutter drain and downleader, backup wall air/vapor barrier on rising walls, and perimeter coping to form a watertight air and vapor barrier.


4. Install a structural insulated panel (SIP) with 4 in. minimum insulation laminated to 5/8 in. thick plywood sheathing (R-20 minimum). Mechanically attach SIP panels to the plywood decking over the CFMF beams. Install low-rise closed cell spray foam where required at edges, joints, and voids in the SIP panels to provide a continuous thermal

5. Provide self-adhered underlayment and one layer of 15# felt underlayment over the SIP panels; integrate self-adhered and felt underlayment with new perimeter metal flashings at built-in gutter, rising walls, and copings to form a continuous watertight barrier. Install new synthetic clay tiles with a minimum 3 in. head lap; provide roof tiles with width and exposure sized to match existing clay tiles in

Proposed Schedule:


Natatorium Walls	– July 2016
Natatorium Roof (Low-Slope)	– August 2016
Natatorium Roof (Steep-Slope)	– July 2016
Windows	– August 2016
Classroom Walls Around Windows	– August 2016
Office Walls Around Windows	– August 2016
Gymnasium Walls	- October/November 2016
Gymnasium Roofs	– December 2016
Substantial Completion	– August 2017

1/8" = 1'-0"(C) KEY PLAN

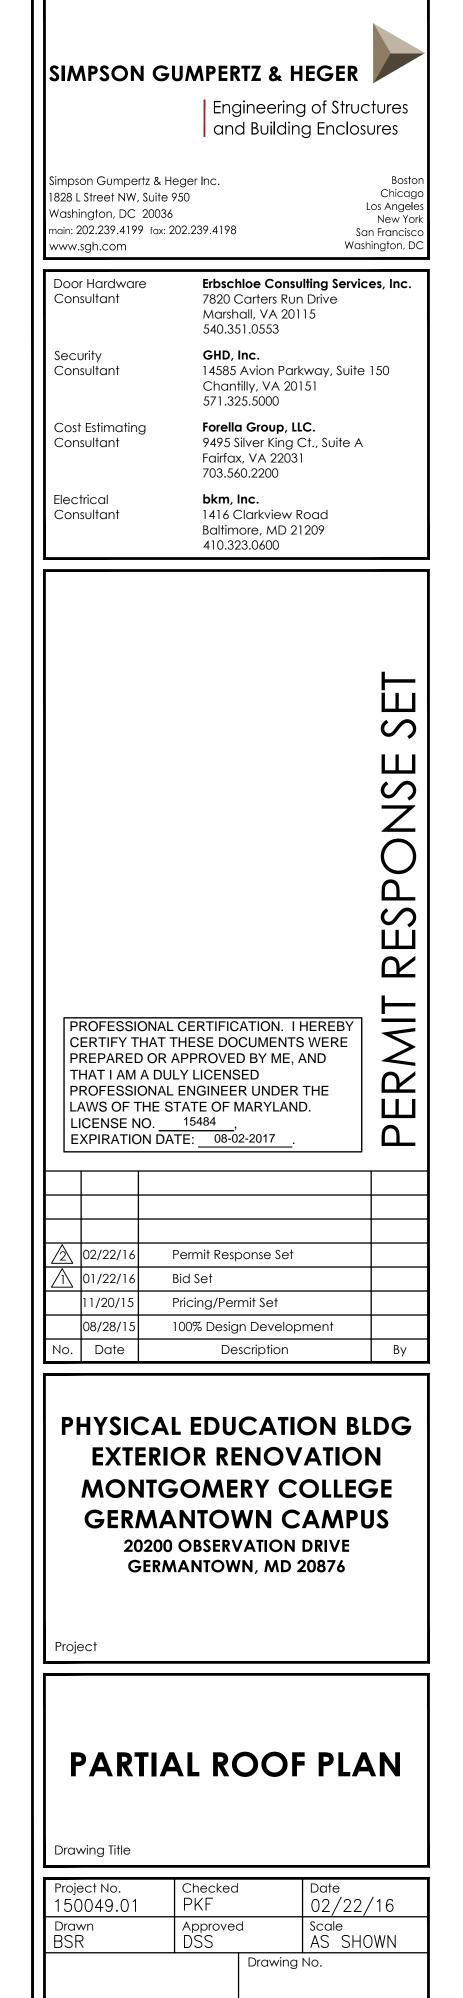

A112

Seal

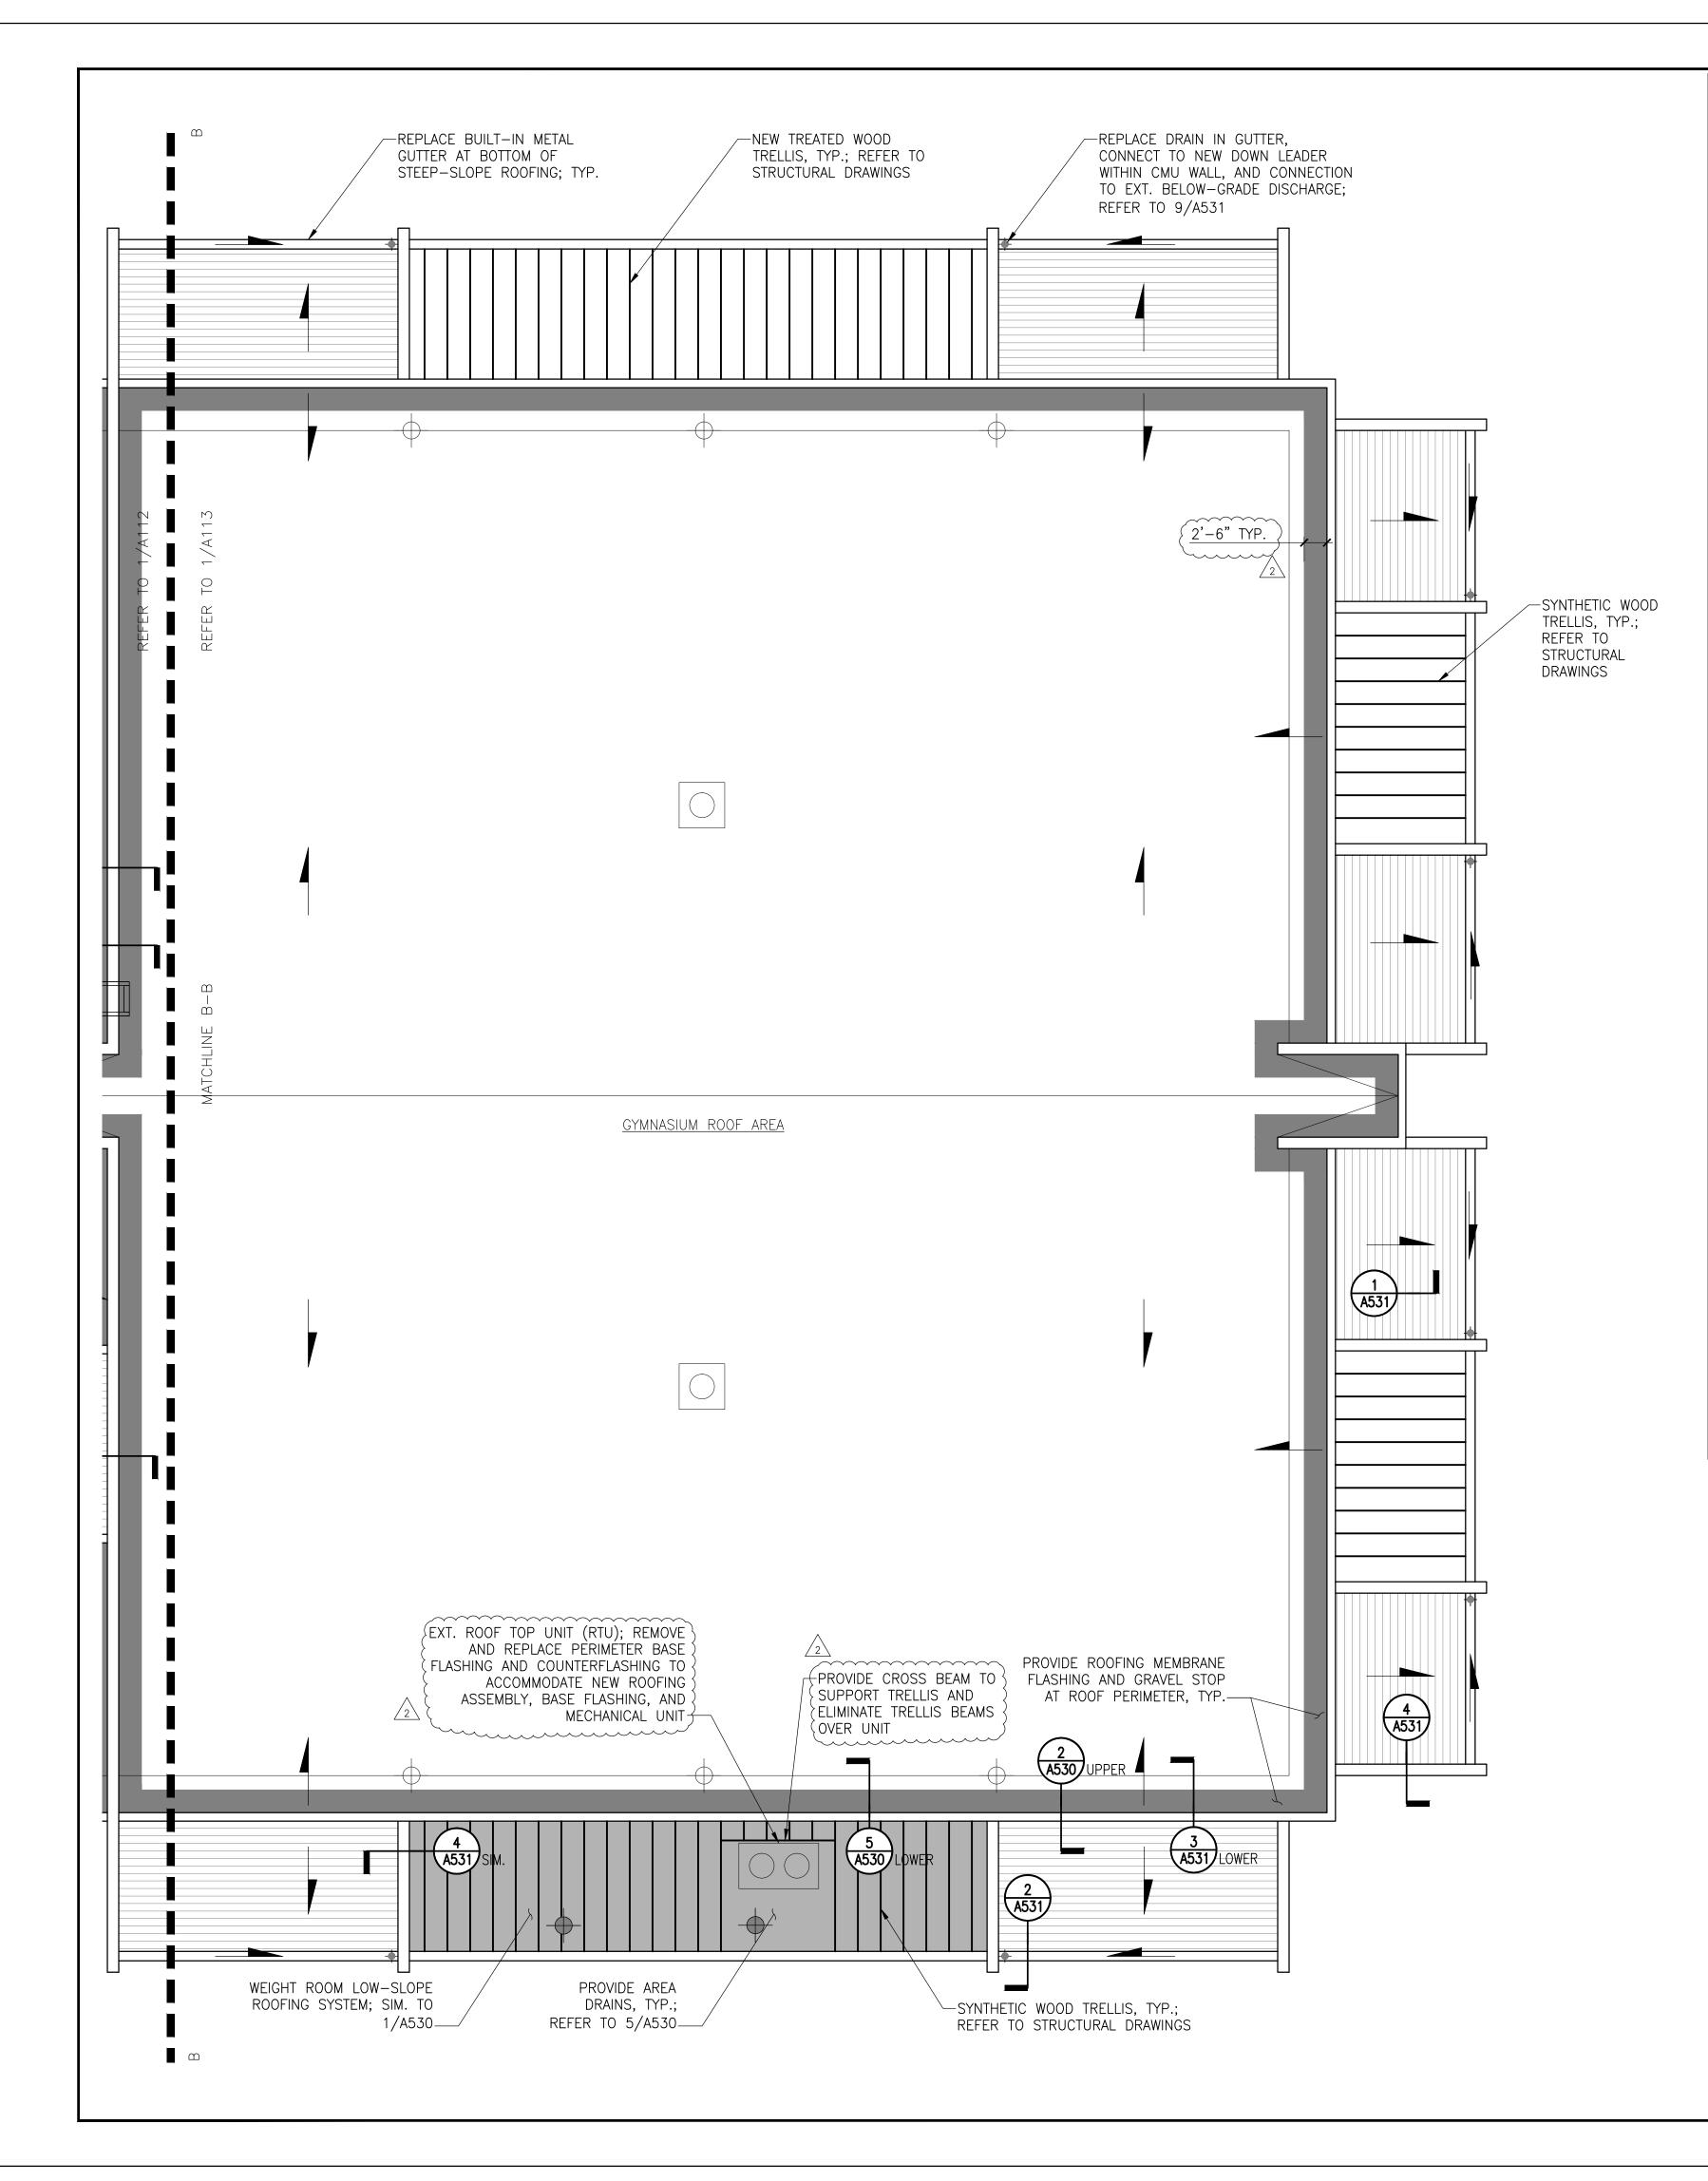

GENERAL SCOPE OF WORK SHOWN ON THIS DRAWING:

Note: Coordinate this work with the surrounding work, related tramiscellaneous mechanical, electrical, and plumbing work required documents.

Central and Gymnasium Roof Areas:

- Provide new blocking around the roof perimeter to support the new roofing assembly, where necessary.
 Provide a self-adhered membrane vapor retarder continuously over
- existing roof deck; extend up parapets. Integrate with typical roo penetrations, and perimeter conditions to form an air seal.
- 3. Provide multiple layers of rigid insulation with 1/2 in. thick cover on top of insulation. Set all layers in adhesive; build up insulatio cover board thickness to match existing insulation thickness with drain toward internal drains (1/4 in. per ft).
- 4. Provide a 3 ply adhered modified bitumen roofing assembly with granular cap sheet and base flashings. Integrate with adjacent ex roofing assembly and perimeter conditions to form continuous roo system and water tight barrier as shown on the Drawings.
- Provide new metal coping and gravel stop around roof perimeter. new metal counterflashings.
 Provide new metal roof access ladders from the low roof up to
- Natatorium and Gymnasium roofs. Anchor access ladders to the wall; do not penetrate roofing membrane.

Weight Room Roof:


- Replace in-kind deteriorated portions of the existing decking. As SF of the Weight Room roof deck will require replacement.
 Provide new blocking around the roof perimeter to support the n
- roofing assembly.
 Install new roof drains with extension flange to elevate drain bow
- new roof surface.
 Provide a self-adhered membrane vapor retarder continuously over
- existing roof deck; extend up parapets, penetrations and other cu Integrate with typical roof drains, penetrations, and perimeter con form an air seal.
- Provide multiple layers of adhered rigid insulation; build up insula thickness to obtain R-30 (6 in. thick). Provide additional tapered insulation where required with slope to drain toward internal drain in. per ft min.).
- 6. Provide 1/2 in thick cover board, set in adhesive.
- Provide a 3 ply adhered modified bitumen roofing assembly with granular cap sheet and base flashings. Integrate with typical roof penetrations, and perimeter conditions to form continuous roofing and water tight barrier.
 Provide new model coning and perimeter conditions to form continuous roofing and water tight barrier.
- 8. Provide new metal coping and gravel stop around roof perimeter. new metal counterflashings and penetration flashings.
- 9. Existing HVAC equipment and curb to remain in place; remove th metal counterflashing to accommodate new membrane base flash Provide new metal counterflashing over membrane base flashing.

Steep-Slope Roofs


- Replace plywood roof sheathing. Around the Natatorium, replace to bottom section of cold-formed metal framing (CFMF) over the locat at all locations (see Structural Drawings). Assume additional ext. will be deteriorated and require complete replacement at 20% of steep-sloped roof areas in addition to the lower soffits. See Structural Drawings for additional information.
- 2. Replace or provide new unfaced fiberglass batt insulation between existing CFMF roof rafters (min R-19) where structural repairs a necessary.
- 3. Provide new self-adhered membrane underlayment over the plywo decking and in the built-in gutter. Integrate with the surrounding parapets, built-in gutter drain and downleader, backup wall air/ve barrier on rising walls, and perimeter coping to form a watertight vapor barrier.
- 4. Install a structural insulated panel (SIP) with 4 in. minimum insul laminated to 5/8 in. thick plywood sheathing (R-20 minimum). Mechanically attach SIP panels to the plywood decking over the 0 beams. Install low-rise closed cell spray foam where required at joints, and voids in the SIP panels to provide a continuous therr barrier.
- 5. Provide self-adhered underlayment and one layer of 15# felt underlayment over the SIP panels; integrate self-adhered and felt underlayment with new perimeter metal flashings at built-in gutte walls, and copings to form a continuous watertight barrier.
- Install new synthetic clay tiles with a minimum 3 in. head lap; p roof tiles with width and exposure sized to match existing clay t kind.

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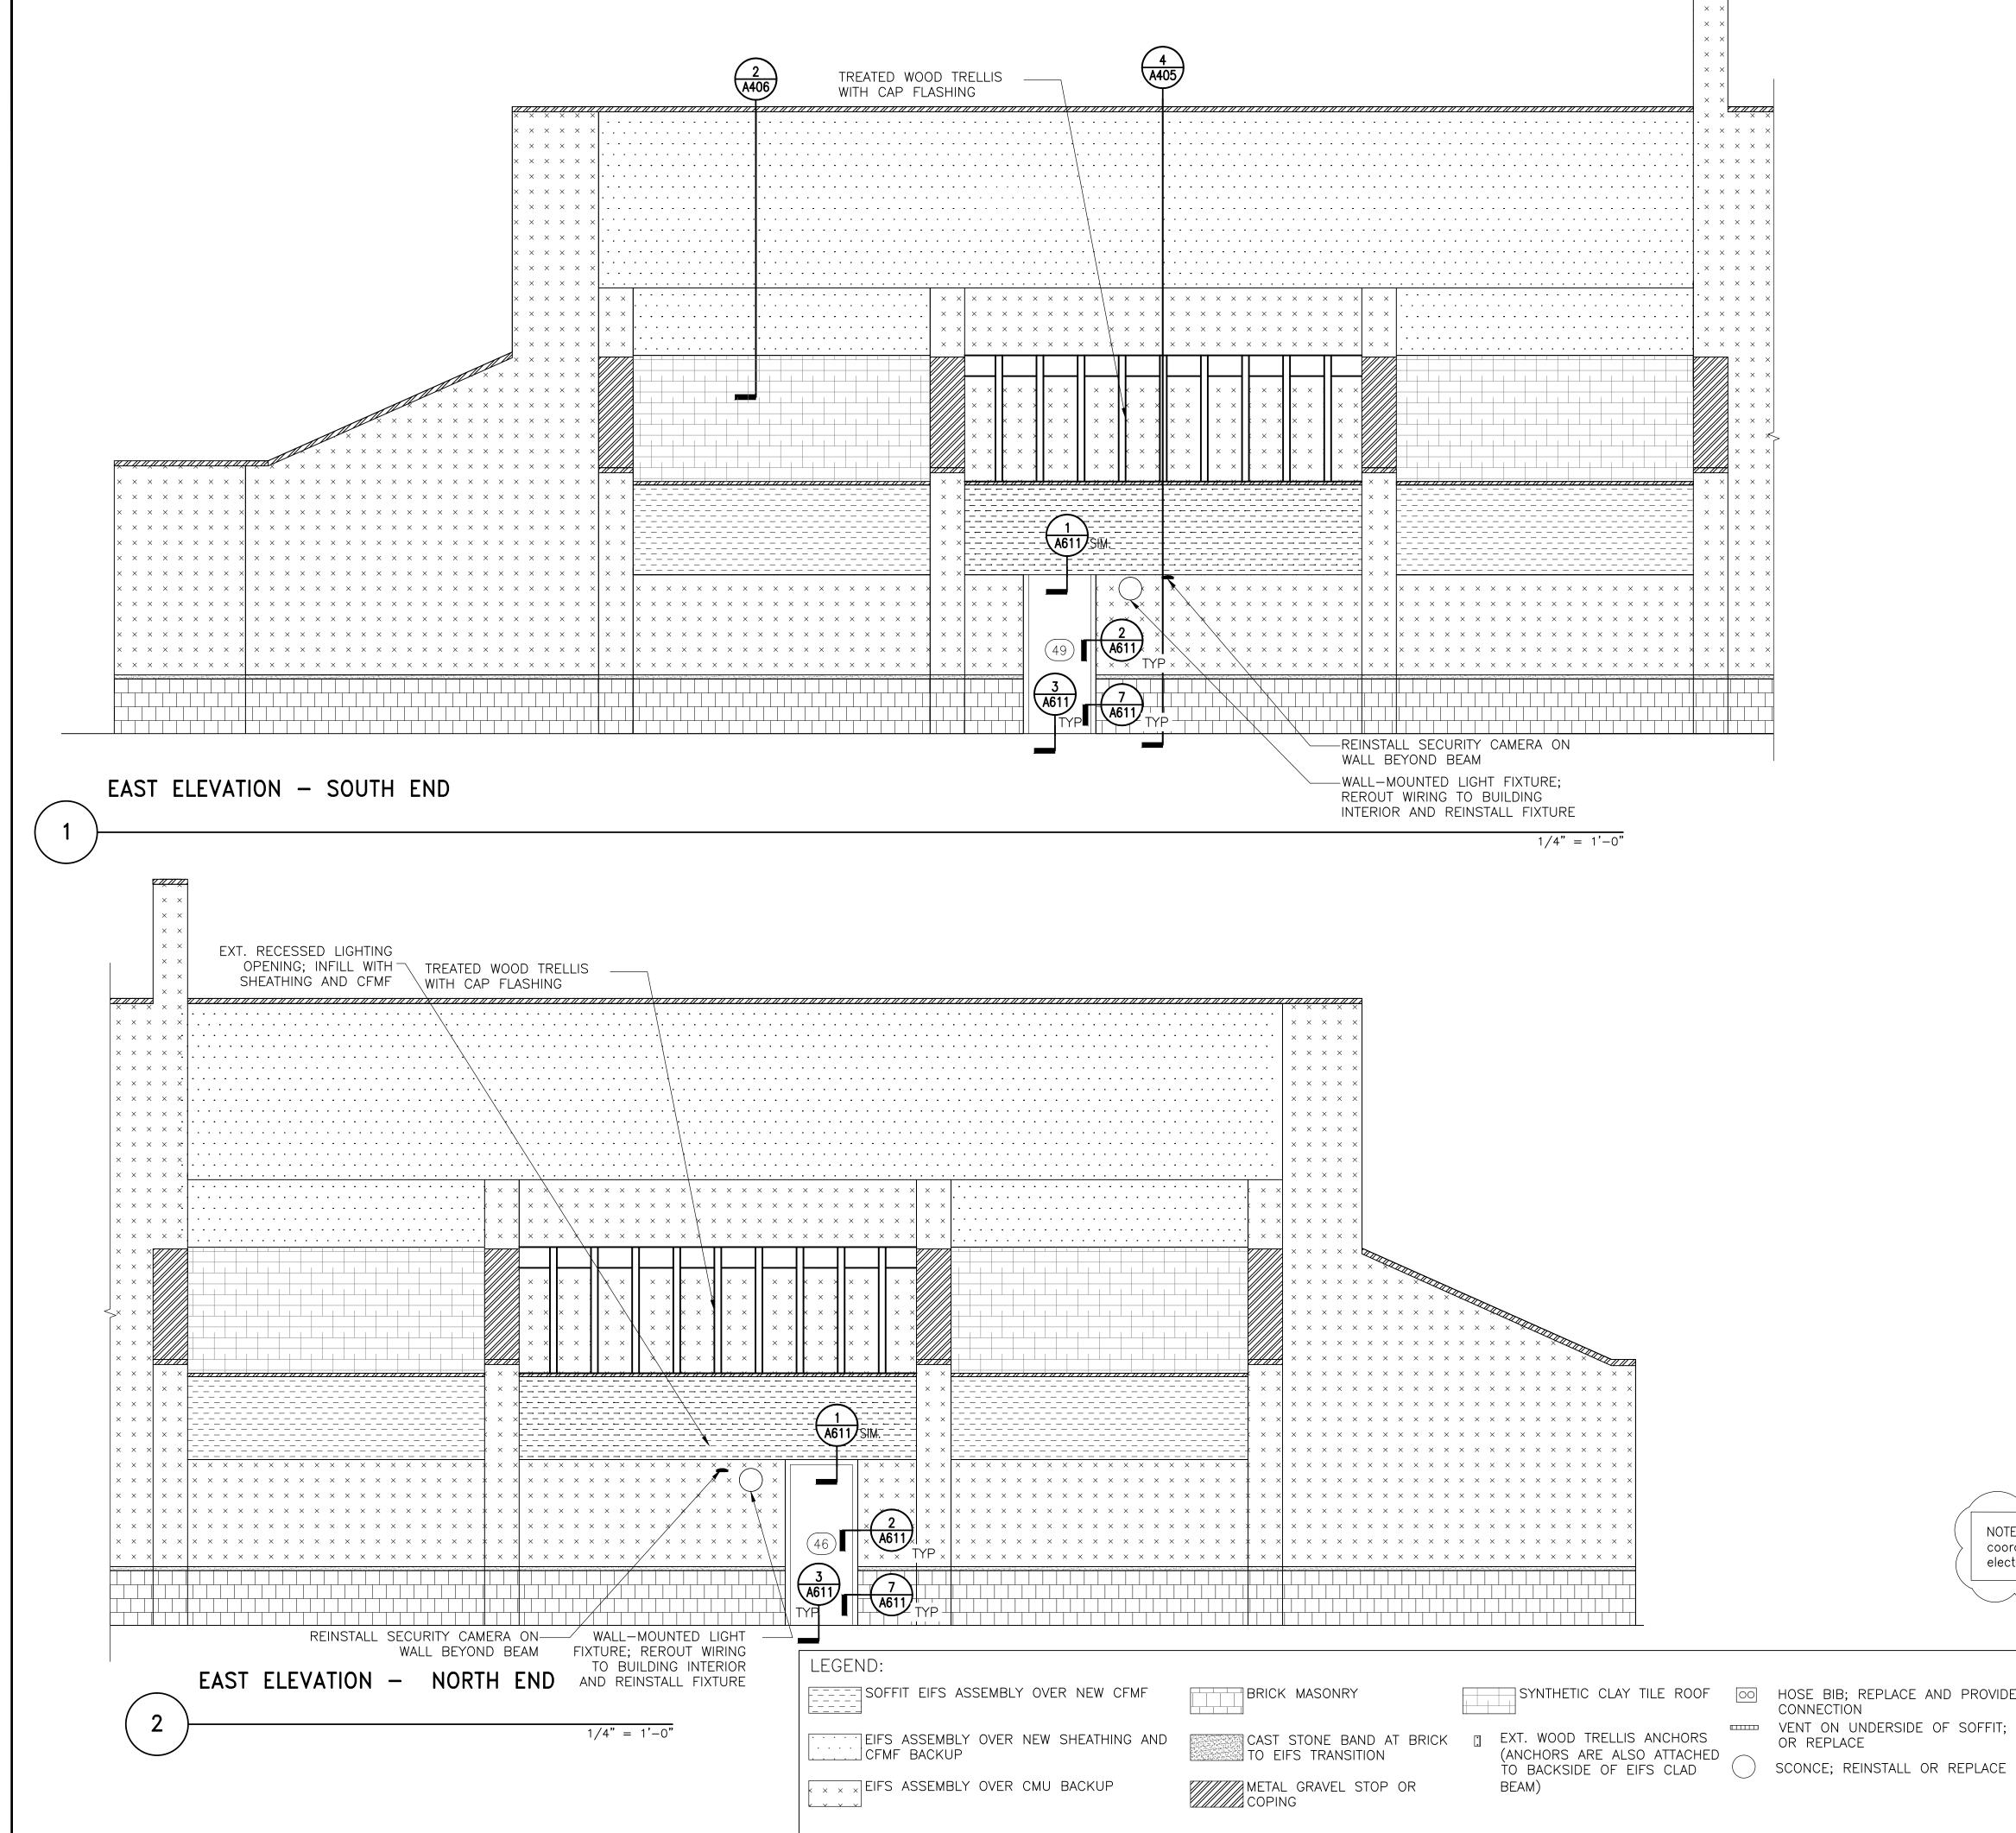
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the exterior		Consultant	14585 Avion Parkway, Suite 150 Chantilly, VA 20151 571.325.5000
ssume 50		Cost Estimating Consultant	Forella Group, LLC. 9495 Silver King Ct., Suite A Fairfax, VA 22031 703.560.2200
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Simpson Gumpertz & Hege 1828 L Street NW, Suite 950 Washington, DC 20036 main: 202.239.4199 fax: 202.1 www.sgh.com Door Hardware Consultant Security Consultant Cost Estimating Consultant Electrical Consultant	239.4198 Erbsch l 7820 C Marsho 540.35 GHD, li 14585 A Chanti 571.32 Forella 9495 Si Fairfax, 703.560 bkm, li 1416 C	arters Run all, VA 201 1.0553 nc. Avion Park Ily, VA 201 5.5000 Group, LL Iver King C , VA 22031 D.2200 nc. Iarkview R pre, MD 21	Sc Was Drive 15 way, Suite 51 C. Ct., Suite A	
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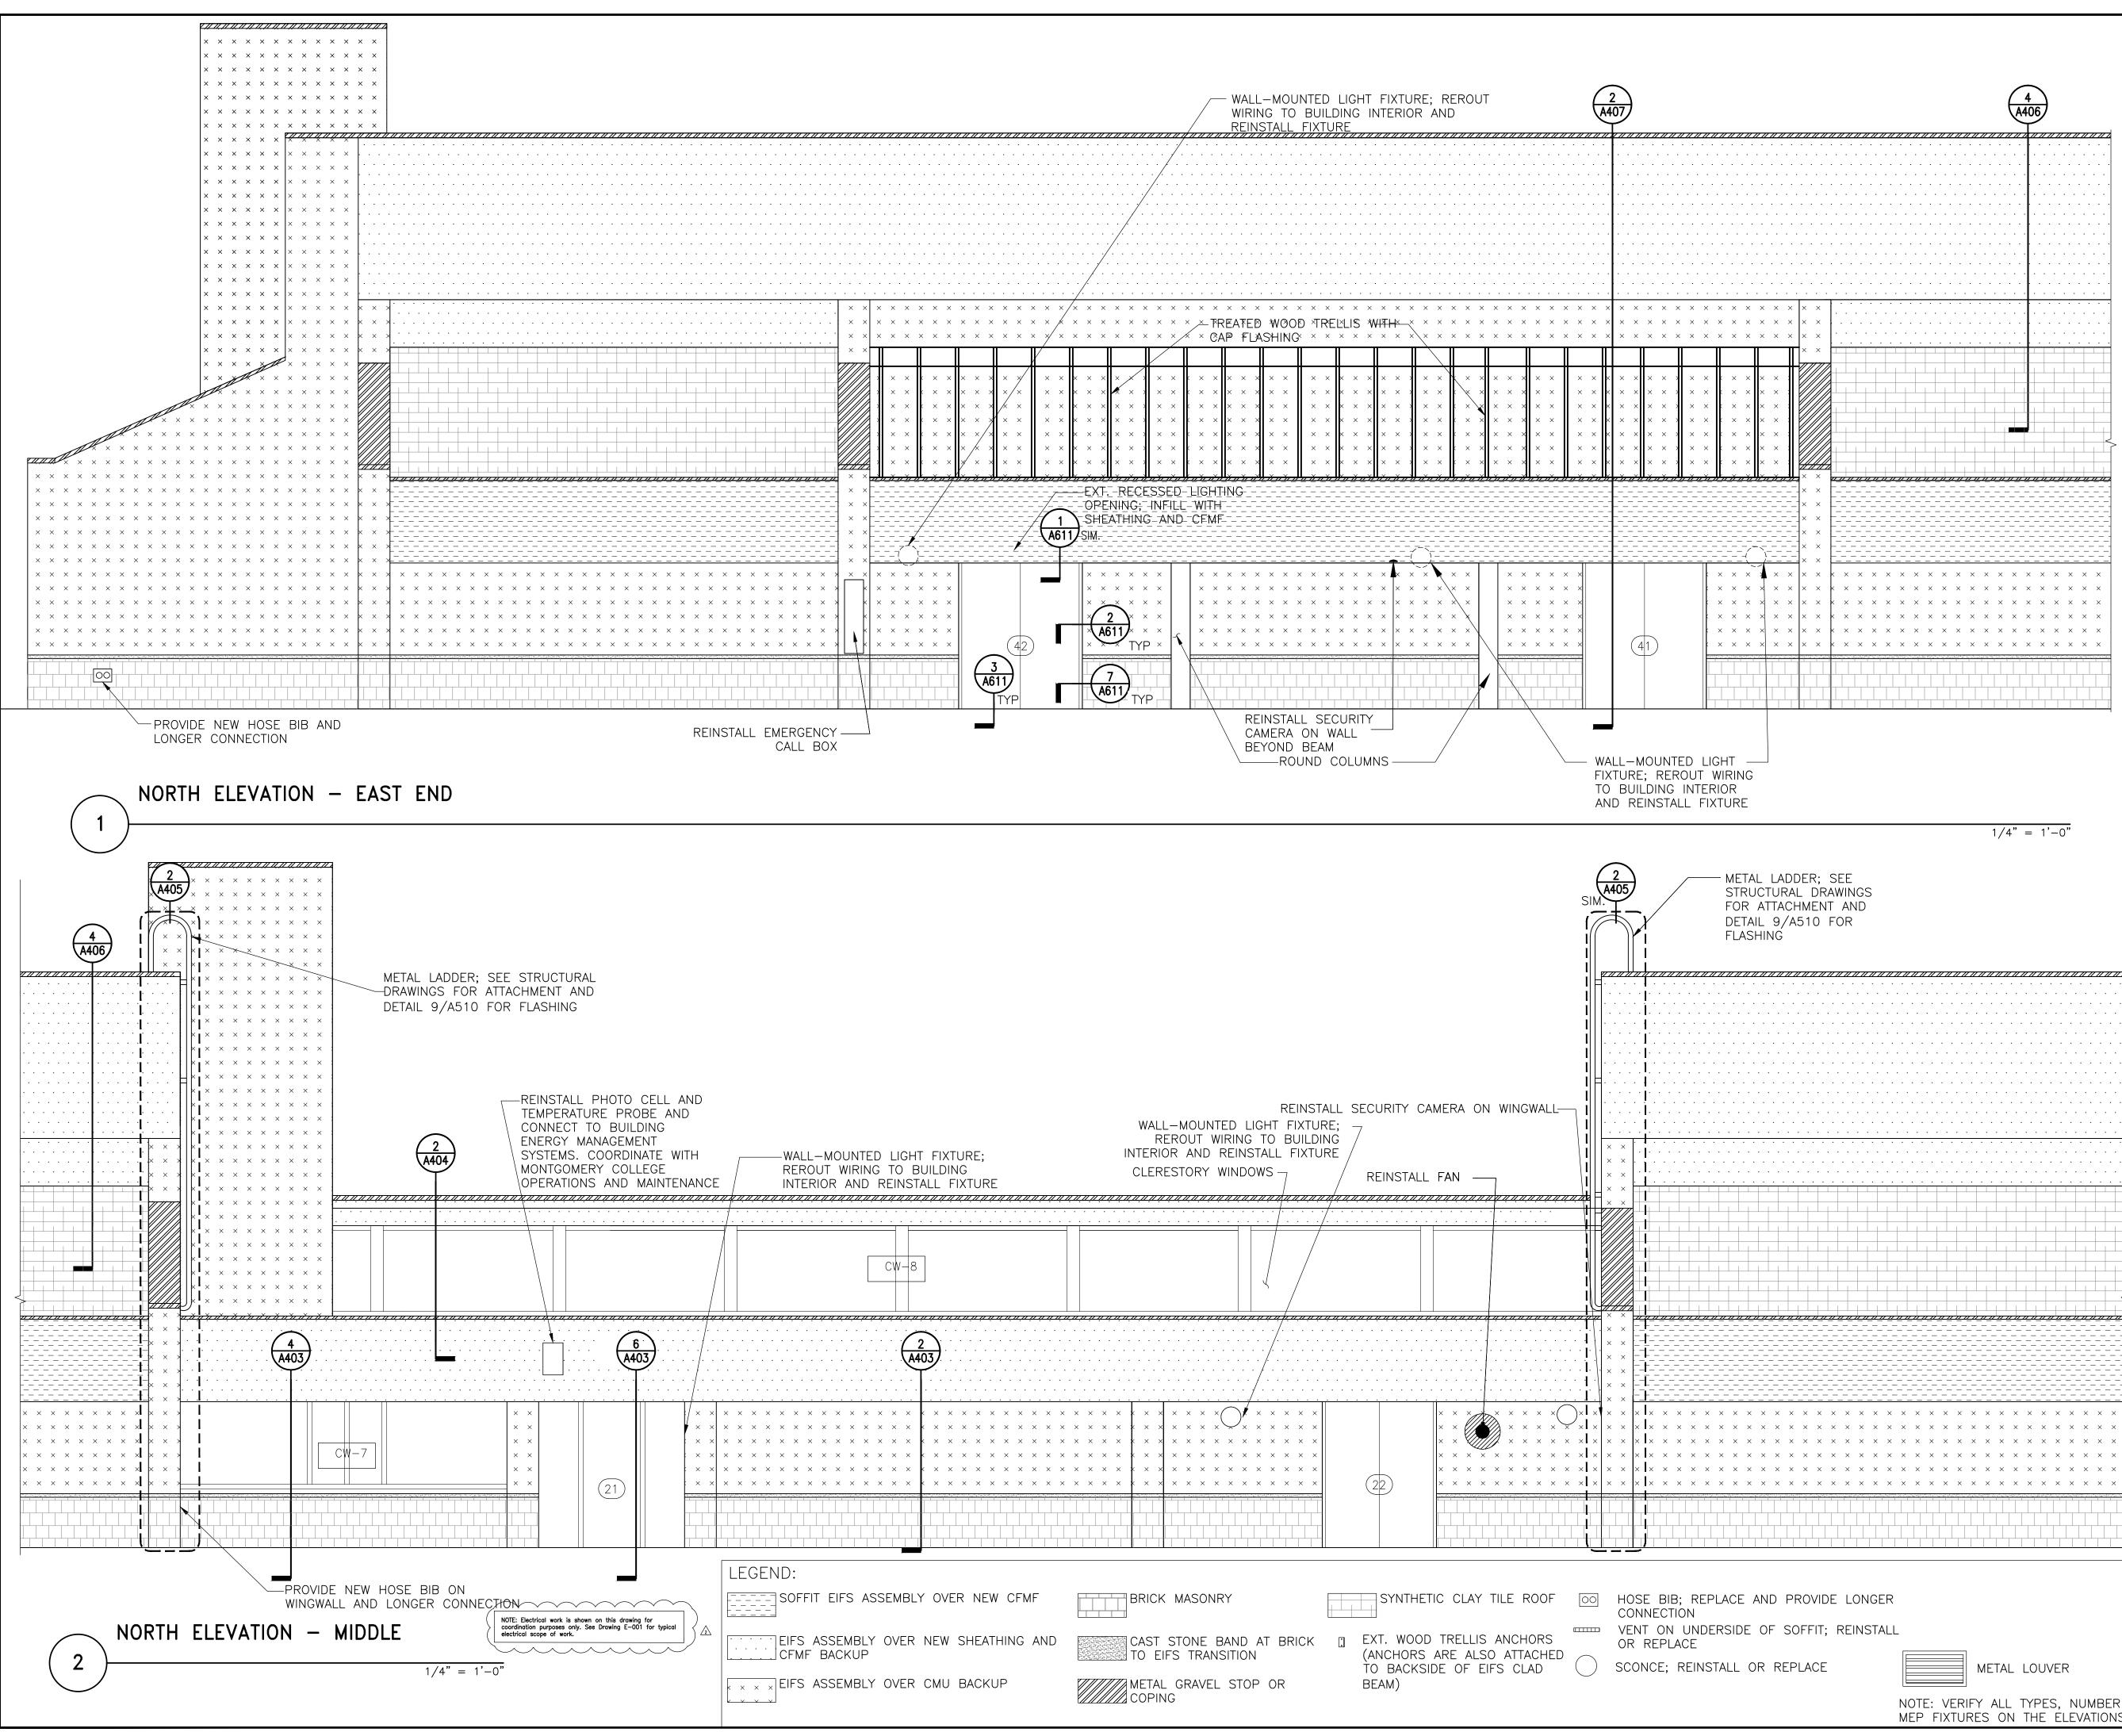


	SIMPSON GU	MPERTZ & HEGER Engineering of Structures and Building Enclosures
	Simpson Gumpertz & Heg 1828 L Street NW, Suite 950 Washington, DC 20036 main: 202.239.4199 fax: 202 www.sgh.com) Chicago Los Angeles New York
	Door Hardware Consultant	Erbschloe Consulting Services, Inc. 7820 Carters Run Drive Marshall, VA 20115 540.351.0553
	Security Consultant	GHD, Inc. 14585 Avion Parkway, Suite 150 Chantilly, VA 20151 571.325.5000
	Cost Estimating Consultant	Forella Group, LLC. 9495 Silver King Ct., Suite A Fairfax, VA 22031 703.560.2200
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	EXTERIOR RENOVATION MONTGOMERY COLLEGE GERMANTOWN CAMPUS 20200 OBSERVATION DRIVE GERMANTOWN, MD 20876
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SIMPSON GUMPERTZ & HEGER

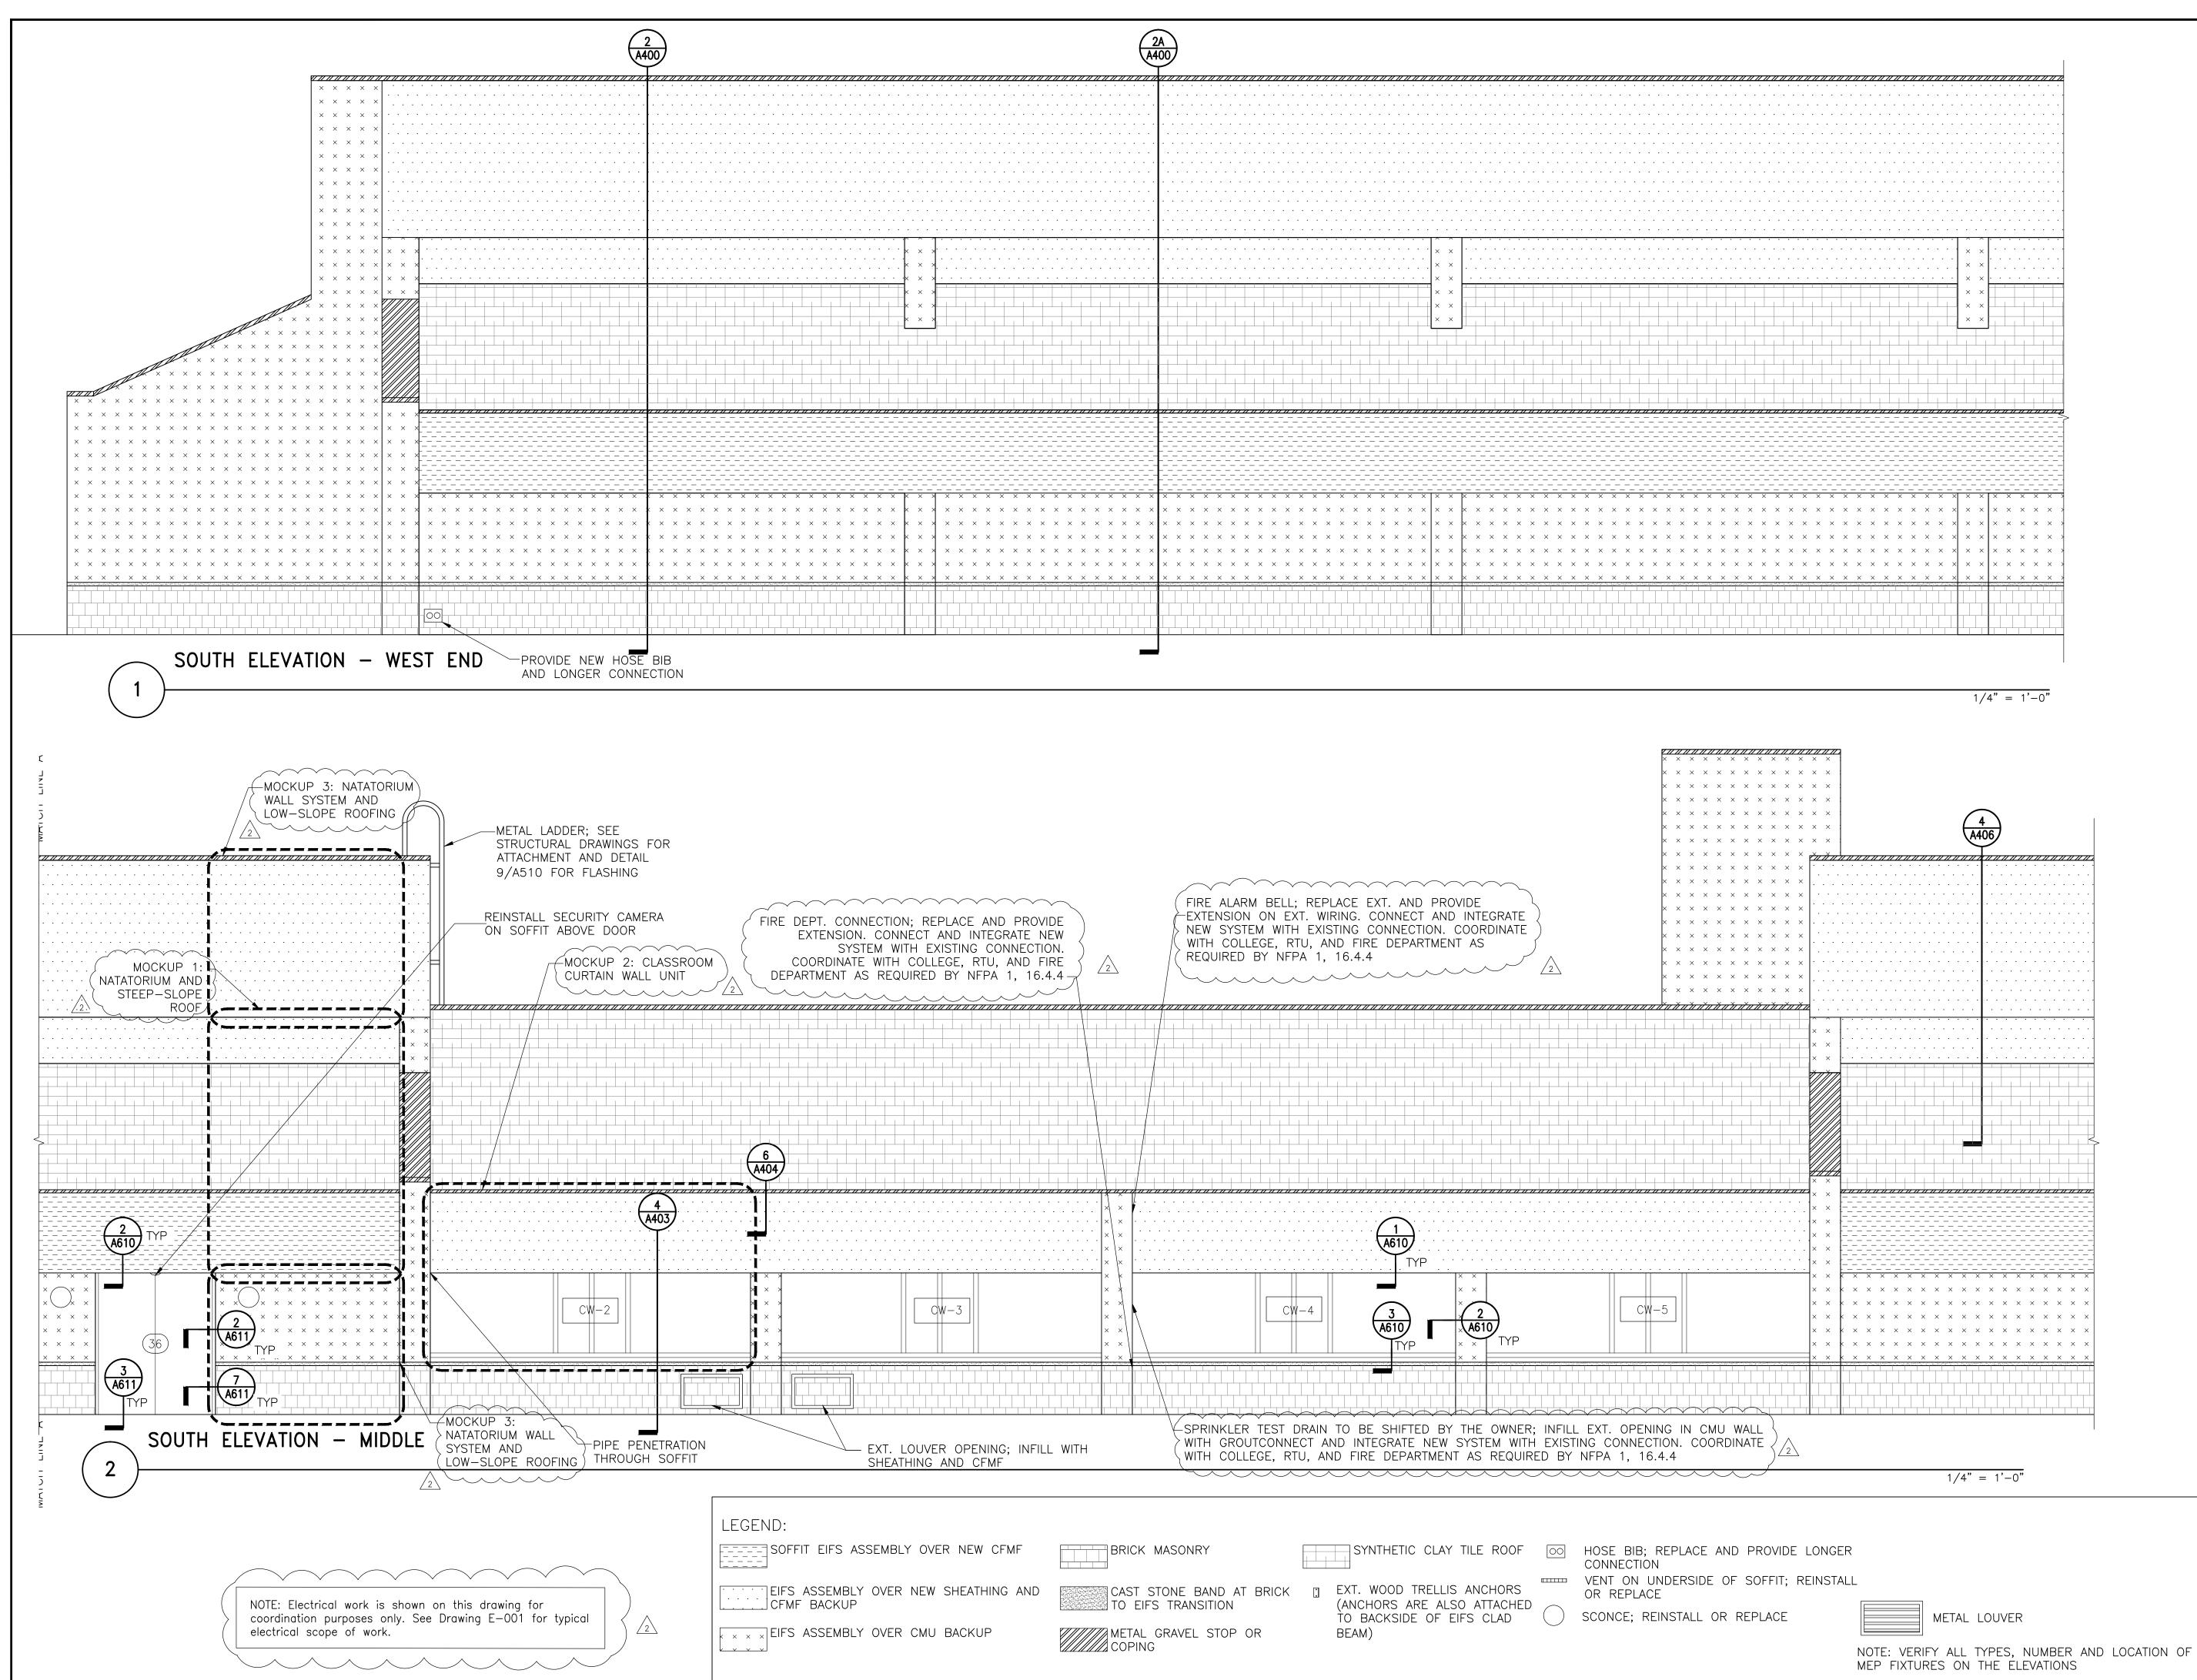Simpson Gumpertz & Heger Inc.

main: 202.239.4199 fax: 202.239.4198

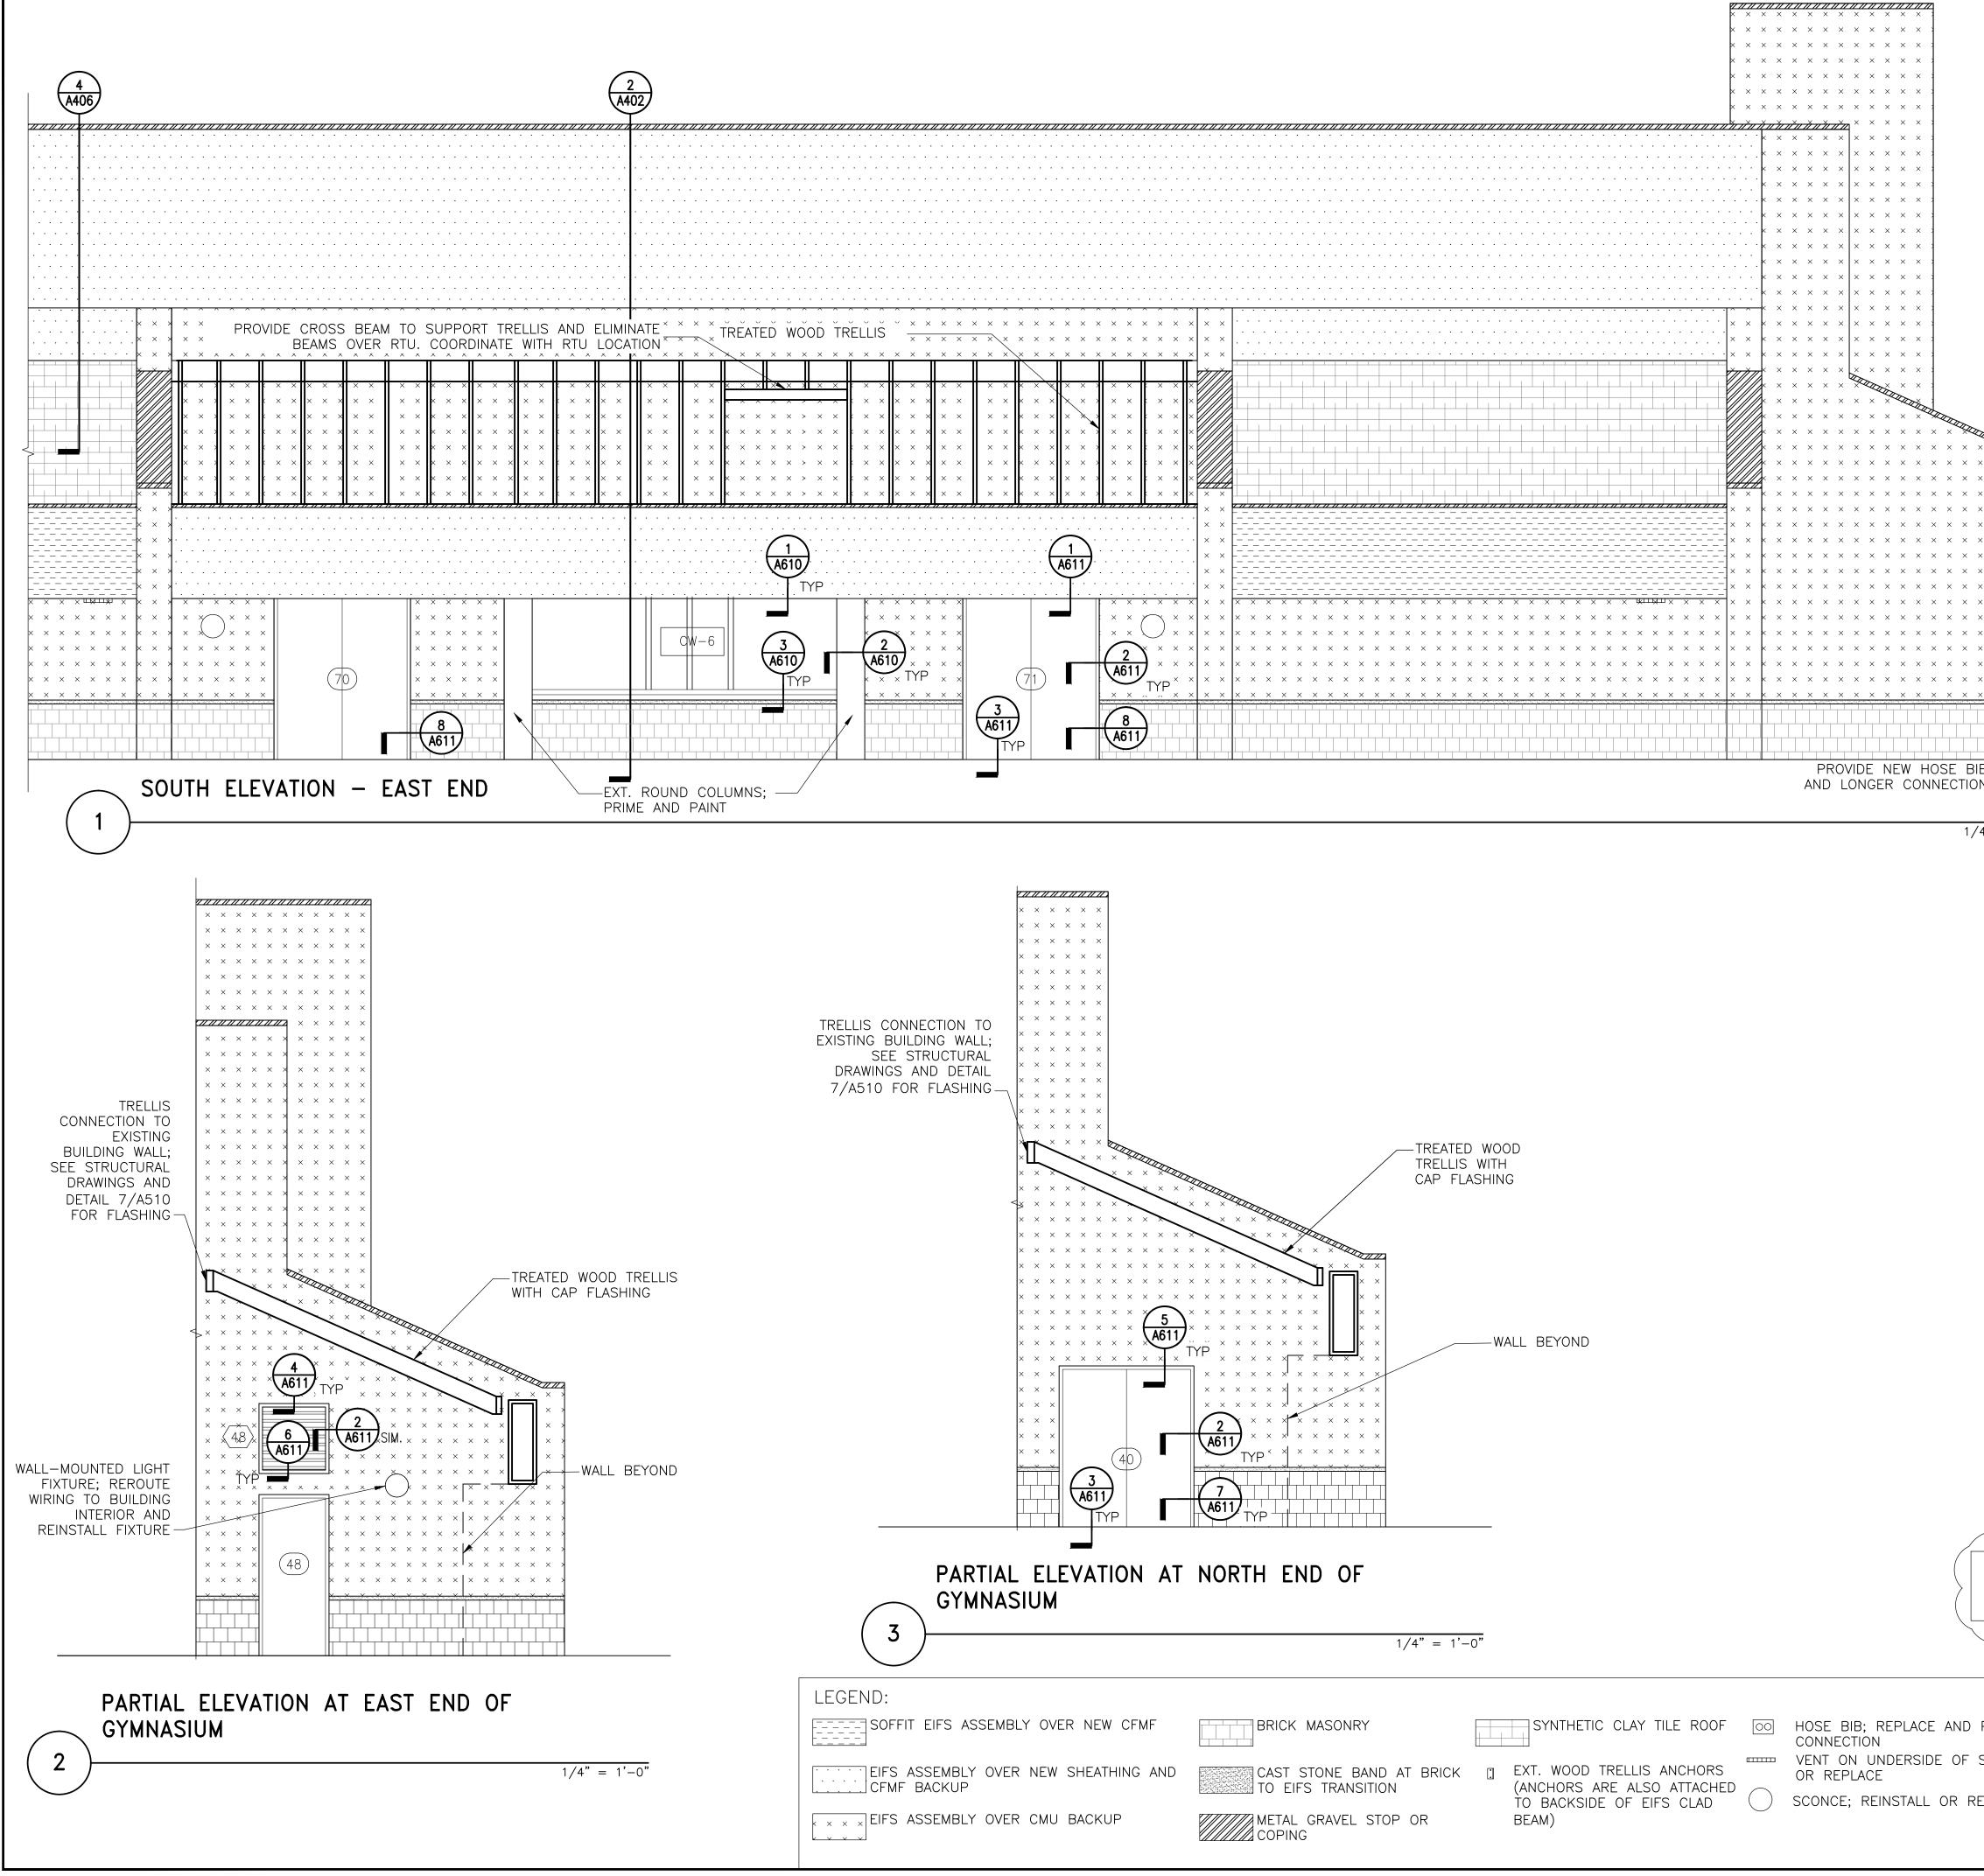1828 L Street NW, Suite 950

Washington, DC 20036

www.sgh.com

Consultant

Security

Consultant

Cost Estimating Consultant

Door Hardware

Engineering of Structures

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Forella Group, LLC.

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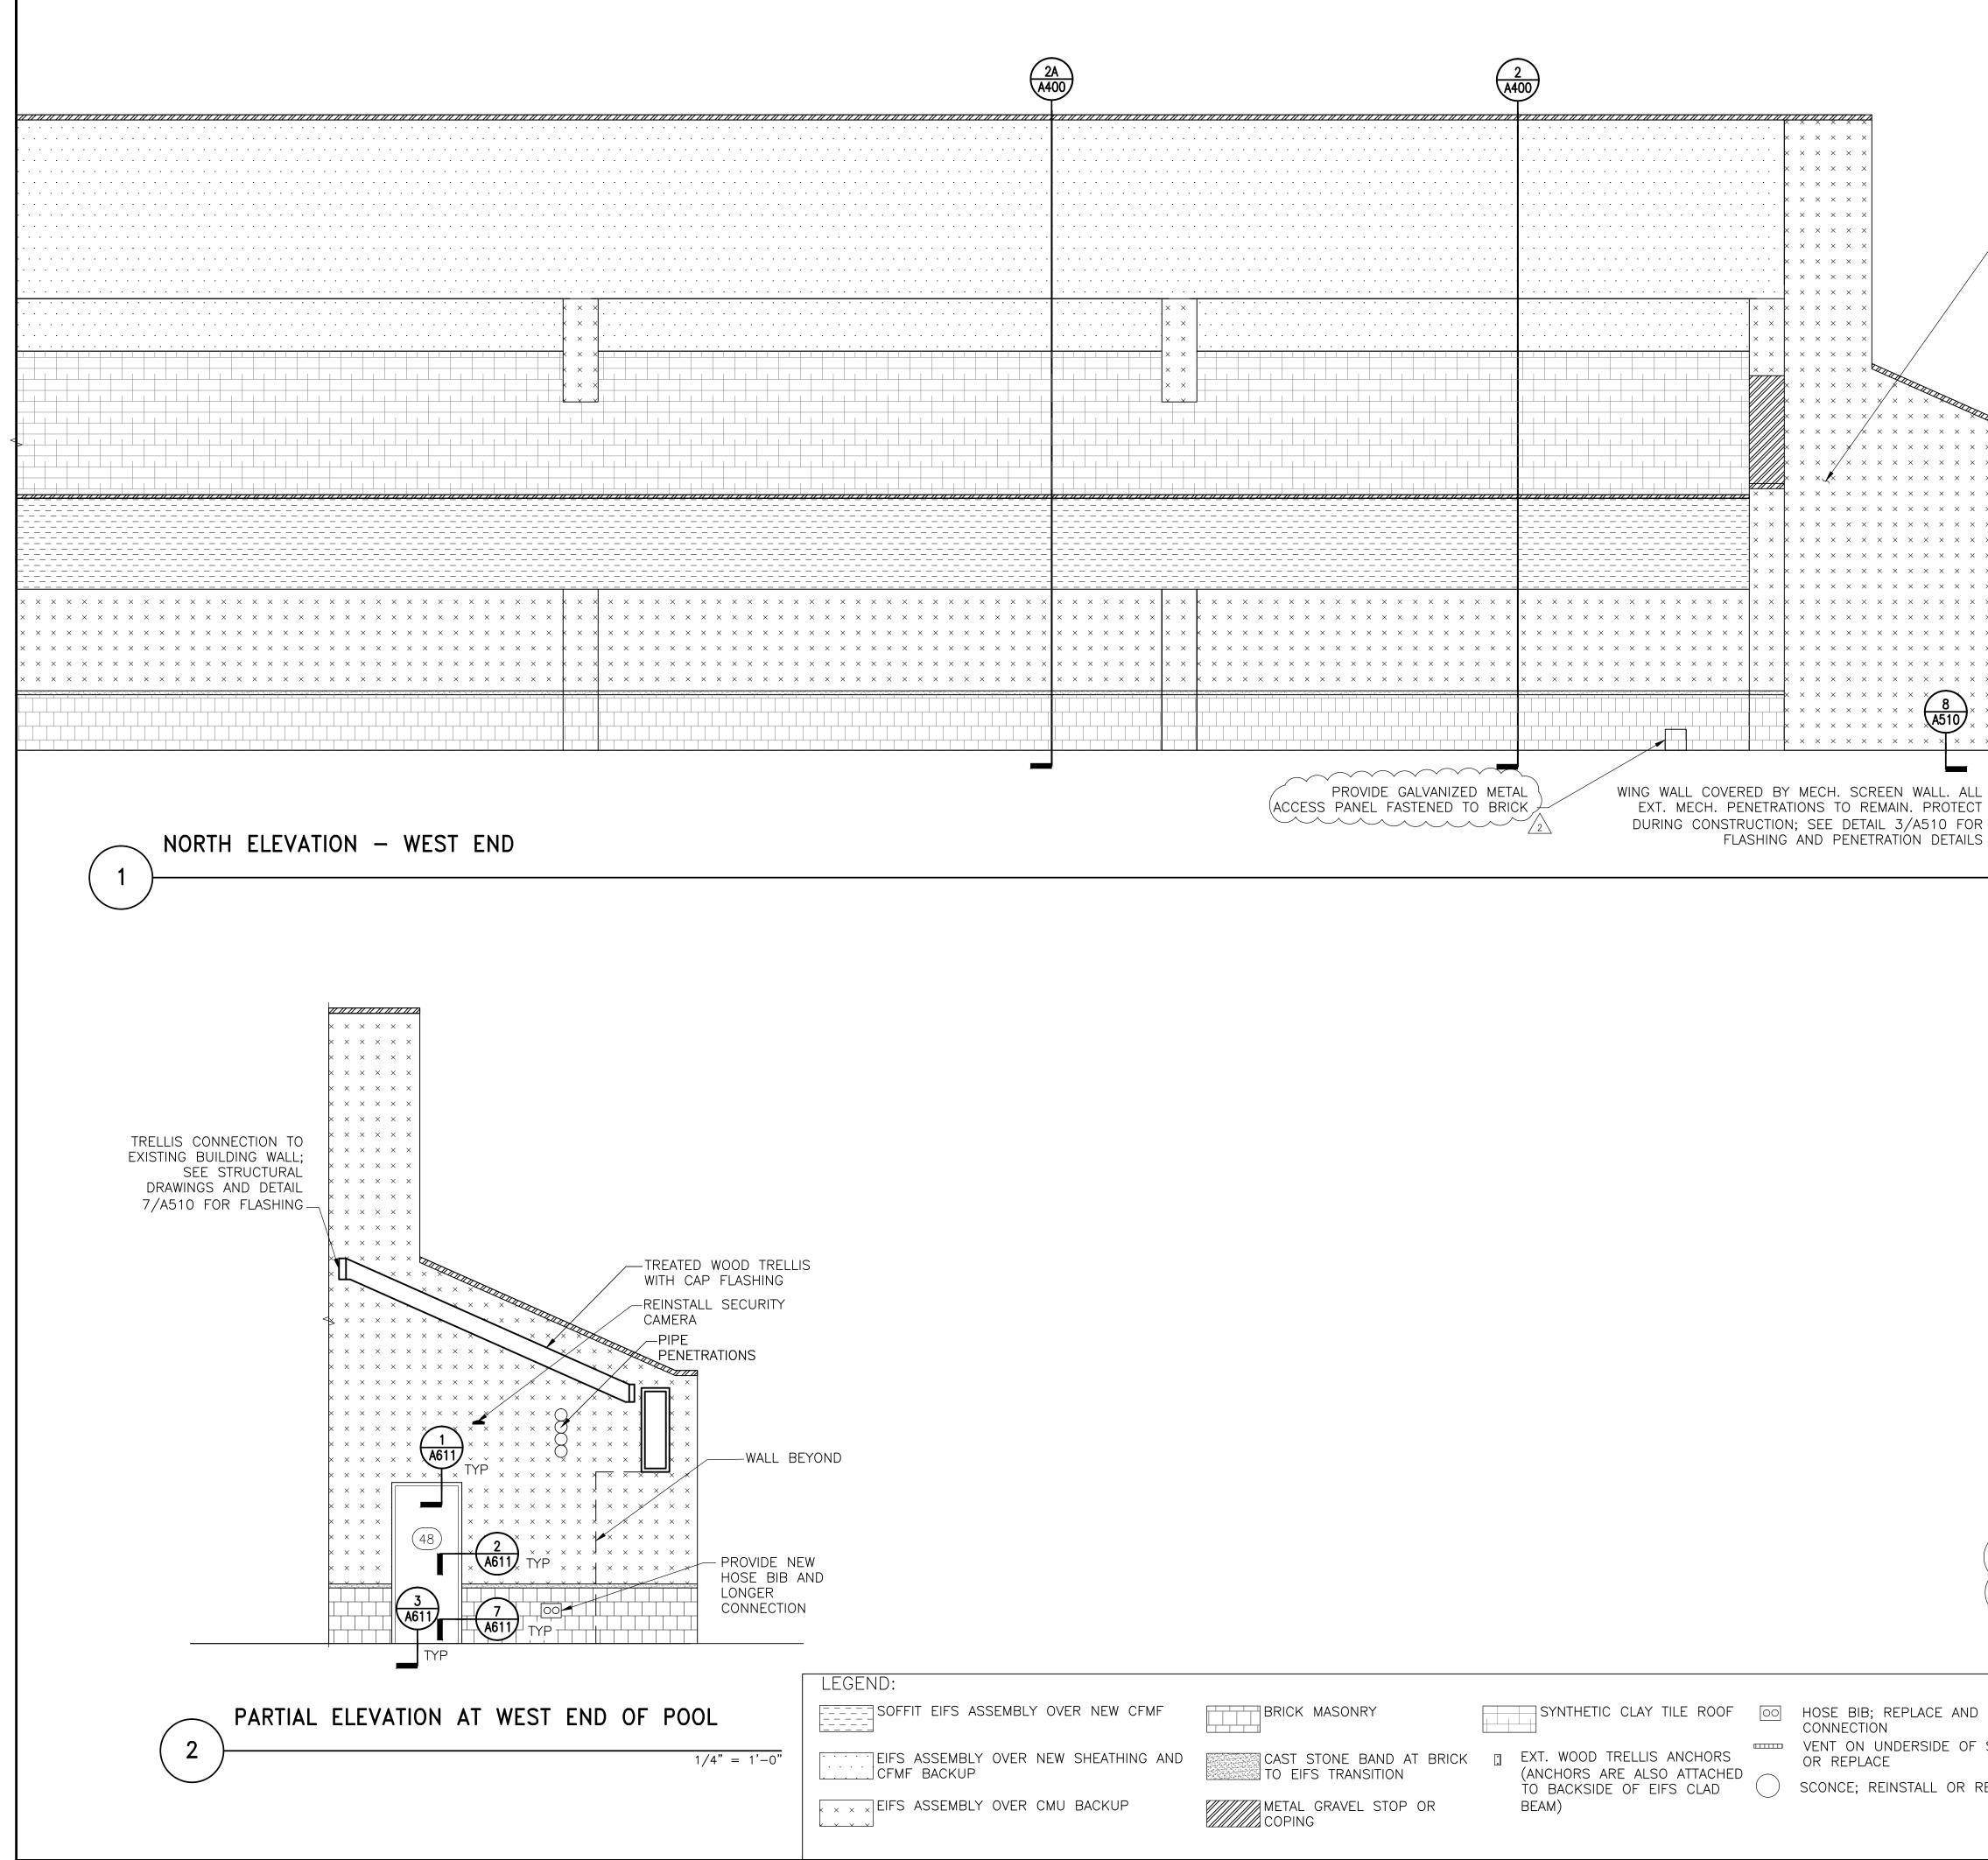
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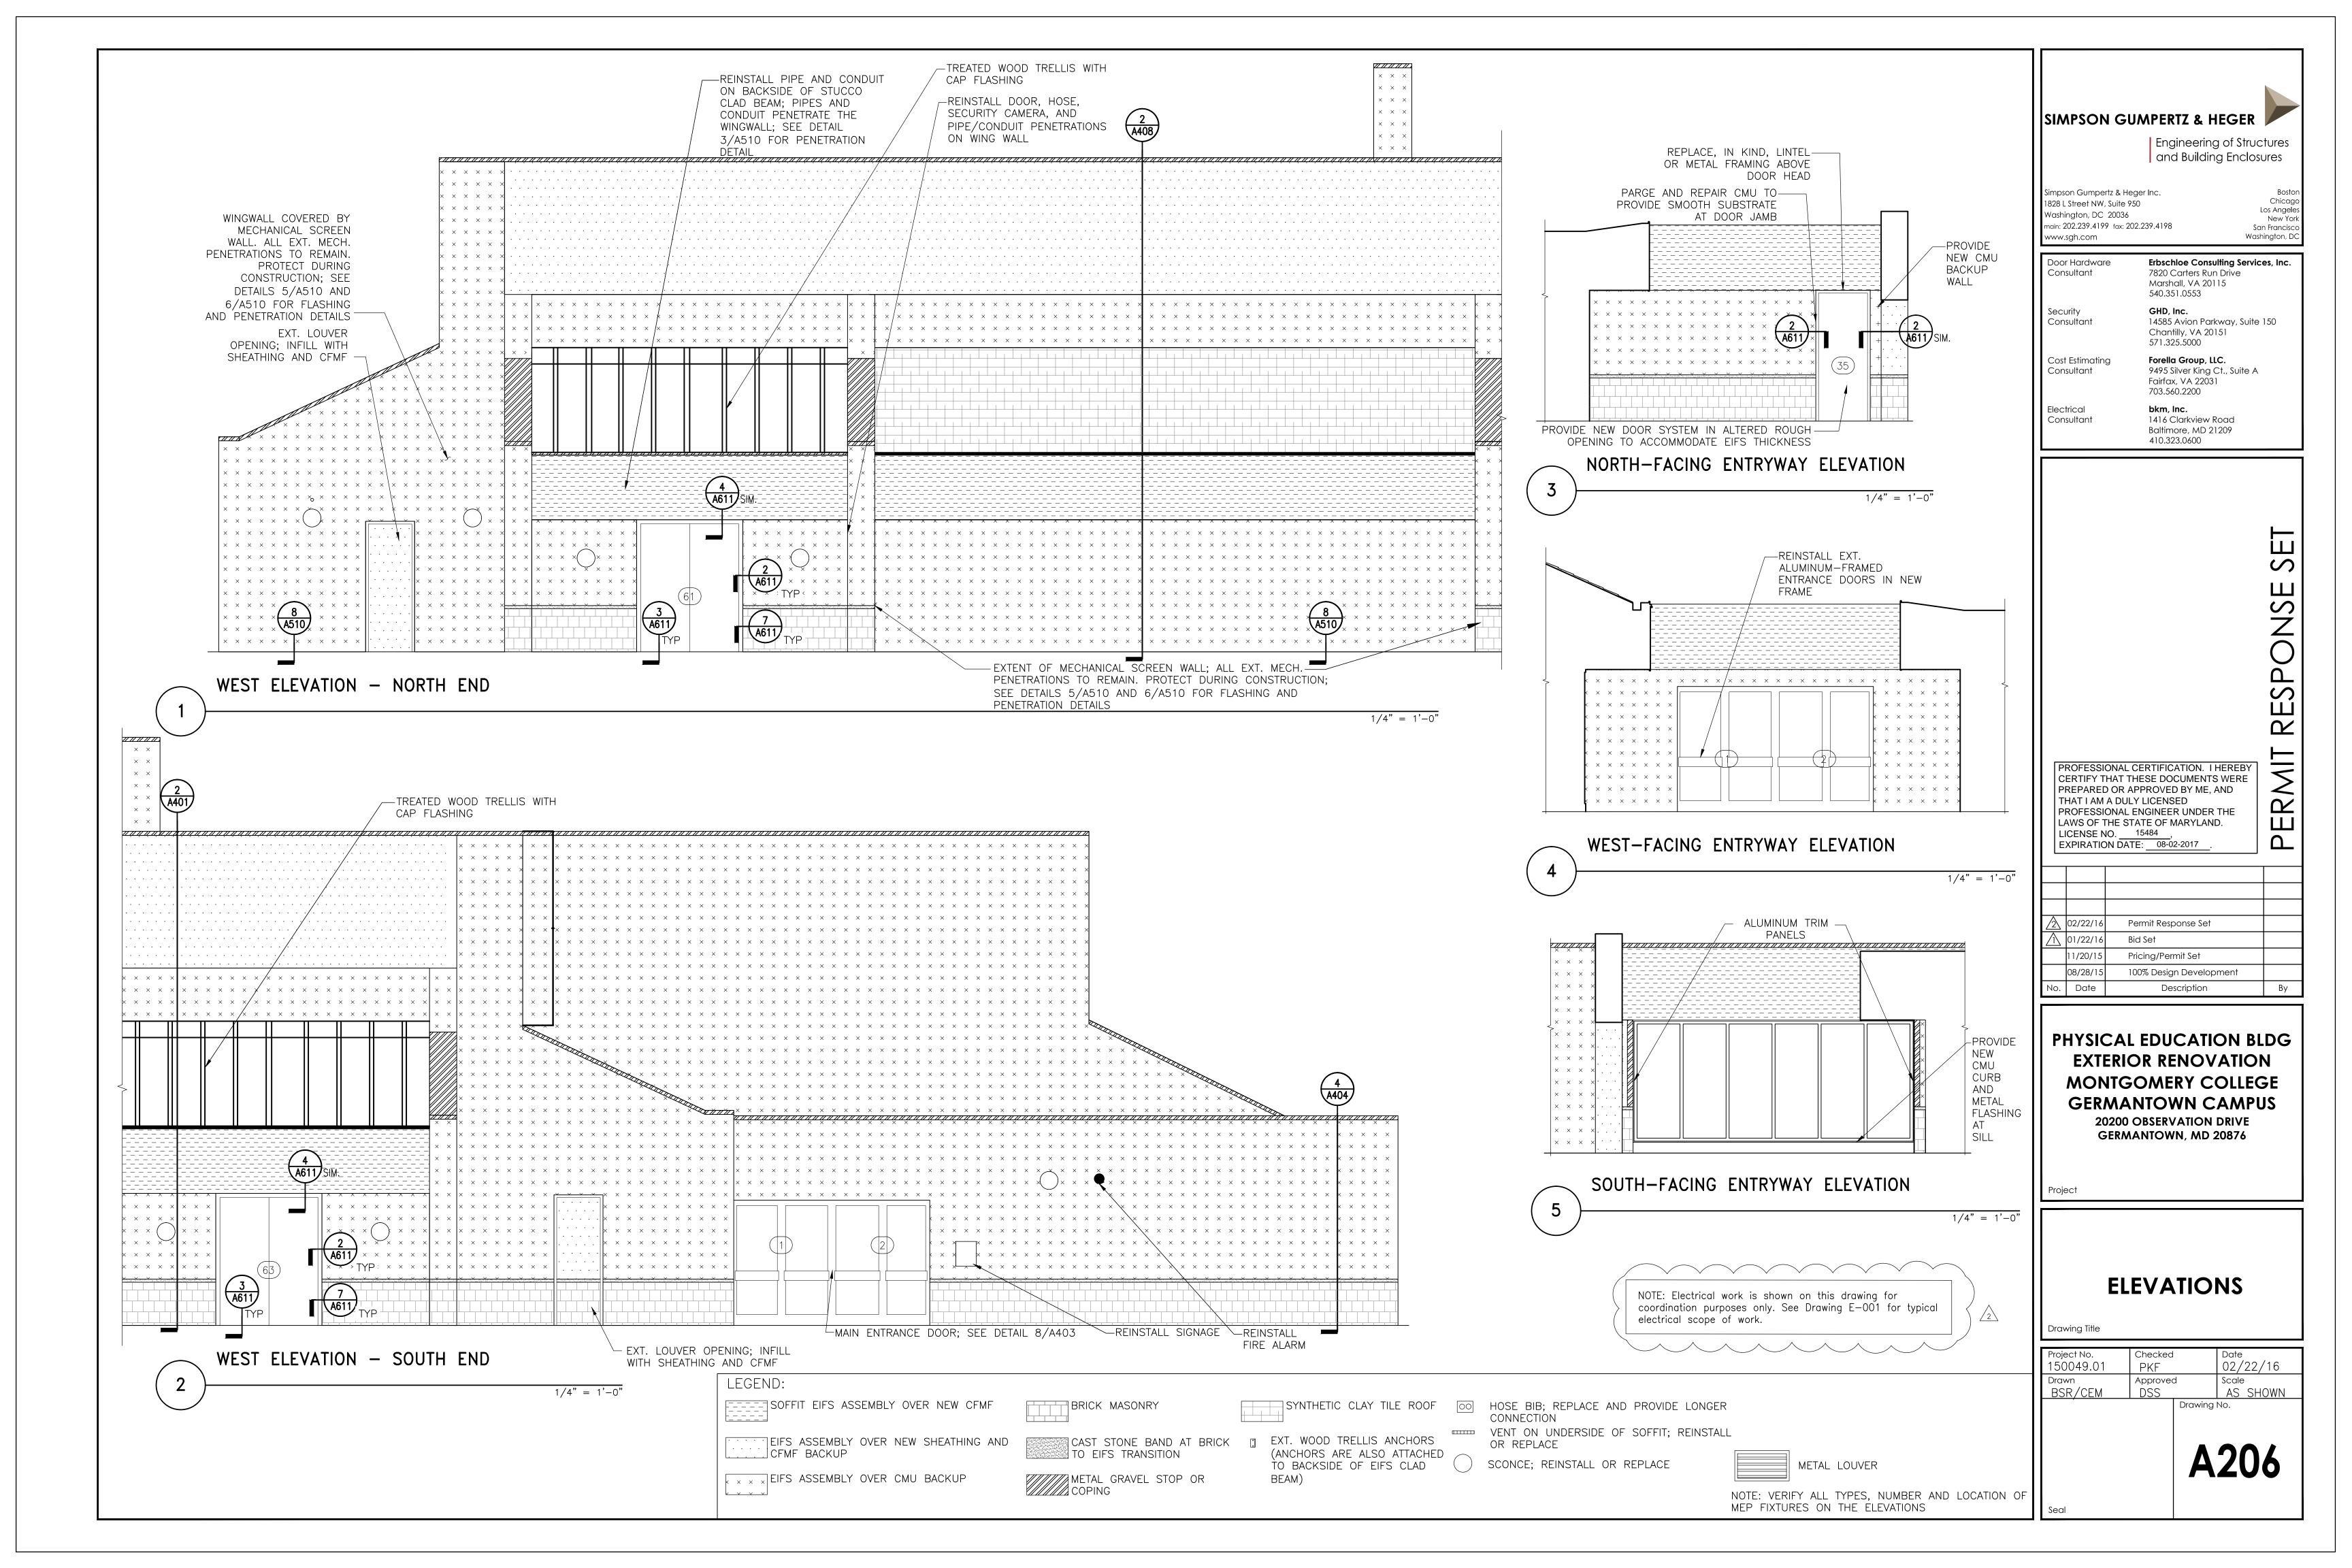
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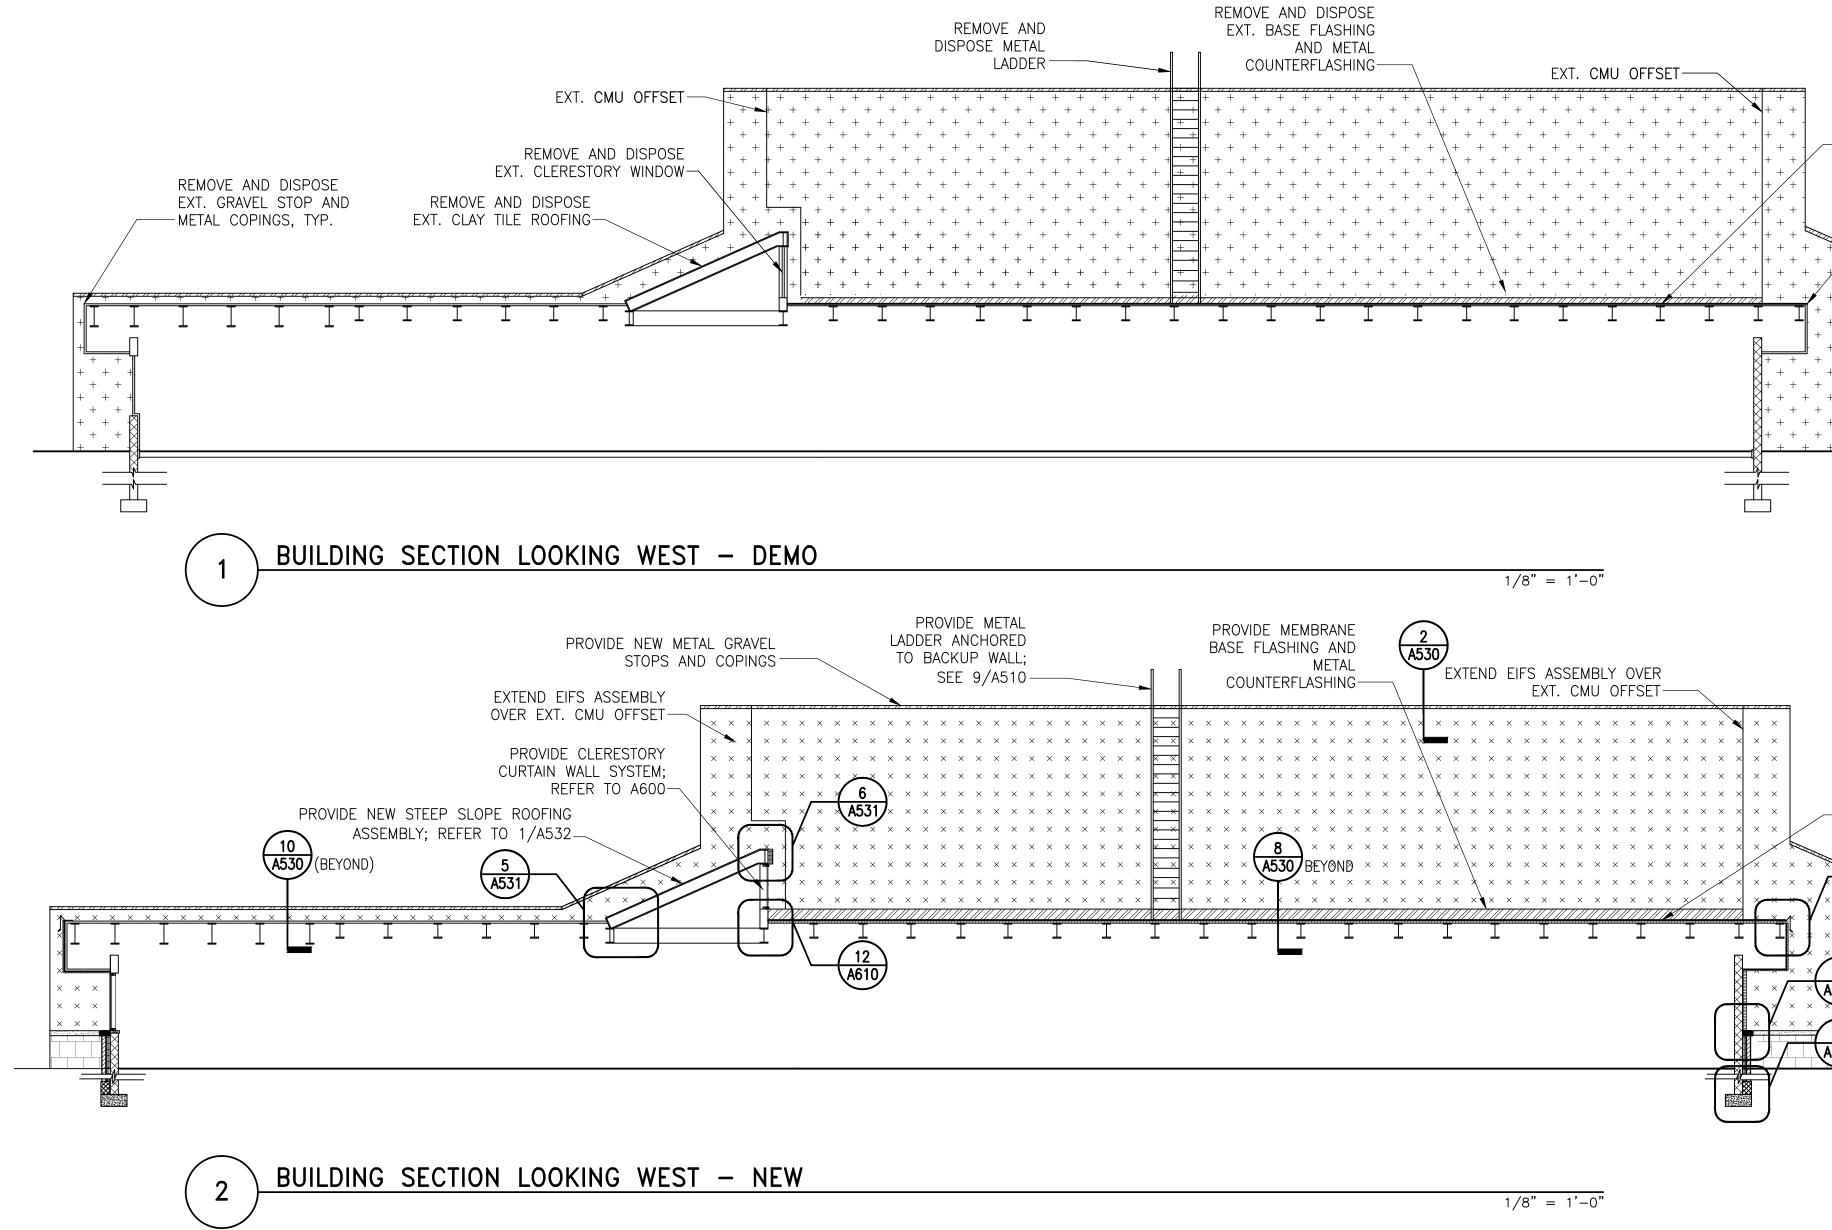
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NOTE: VERIFY ALL TYPES, NUMBER AND LOCATION OF MEP FIXTURES ON THE ELEVATIONS



WINGWALL COVERED BY MECHANICAL SCREEN WALL; SEVERAL CONDUIT PENETRATIONS, ANCHORS AND PIPES	SIMPSON C Simpson Gumpertz & 1828 L Street NW, Suit Washington, DC 200 main: 202.239.4199 fa www.sgh.com Door Hardware Consultant Security Consultant Security Consultant Cost Estimating Consultant Electrical Consultant	Eng and heger Inc. te 950 036 x: 202.239.4198 Erbsch 7820 C Marsha 540.35 GHD, I 14585 Chant 571.32 Forella 9495 Si Fairfax 703.56 bkm, Ii 1416 C	nc. Avion Parkway, Suite 150 Ily, VA 20151 5.5000 Group, LLC. Iver King Ct., Suite A , VA 22031 D.2200 nc. Iarkview Road pre, MD 21209
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	MONT GERM 2020	GOME ANTOV	NOVATION RY COLLEGE VN CAMPUS ATION DRIVE N, MD 20876
NOTE: Electrical work is shown on this drawing for coordination purposes only. See Drawing E-001 for typical electrical scope of work.	Drawing Title Project No. 150049.01 Drawn	Checked PKF Approvec	
CE AND PROVIDE LONGER DIDE OF SOFFIT; REINSTALL L OR REPLACE METAL LOUVER NOTE: VERIFY ALL TYPES, NUMBER AND LOCATION OF MEP FIXTURES ON THE ELEVATIONS	BSR/CEM	DSS	Drawing No.






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EIFS ASSEMBLY OVER NEW SHEATHI


 $\overline{x \times x \times x}$ EIFS ASSEMBLY OVER CMU BACKUP


	SIMPSON GUMPERTZ & HEGER Engineering of Structures and Building Enclosures
	Simpson Gumpertz & Heger Inc.Boston1828 L Street NW, Suite 950ChicagoWashington, DC 20036Los AngelesWain: 202.239.4199 fax: 202.239.4198San Franciscowww.sgh.comWashington, DC
	Door Hardware Consultant
	Security GHD, Inc. Consultant 14585 Avion Parkway, Suite 150 Chantilly, VA 20151 571.325.5000
	Cost Estimating Consultant Forella Group, LLC. 9495 Silver King Ct., Suite A Fairfax, VA 22031 703.560.2200
EXT. LOW–SLOPE ROOFING ASSEMBLY TO —REMAIN	Electrical bkm, Inc. Consultant 1416 Clarkview Road Baltimore, MD 21209 410.323.0600
REMOVE AND DISPOSE EXT. GRAVEL STOP AND — METAL COPINGS, TYP.	
	TABLE STATES AND
EXT. LOW-SLOPE	PROFESSIONAL CERTIFICATION. I HEREBY CERTIFY THAT THESE DOCUMENTS WERE PREPARED OR APPROVED BY ME, AND THAT I AM A DULY LICENSED PROFESSIONAL ENGINEER UNDER THE LAWS OF THE STATE OF MARYLAND. LICENSE NO
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	BUILDING SECTIONS
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BACKUP;	Project No.CheckedDate150049.01PKF02/22/16DrawnApprovedScaleCEM/BSRDSSAS SHOWNDrawing No.Drawing No.
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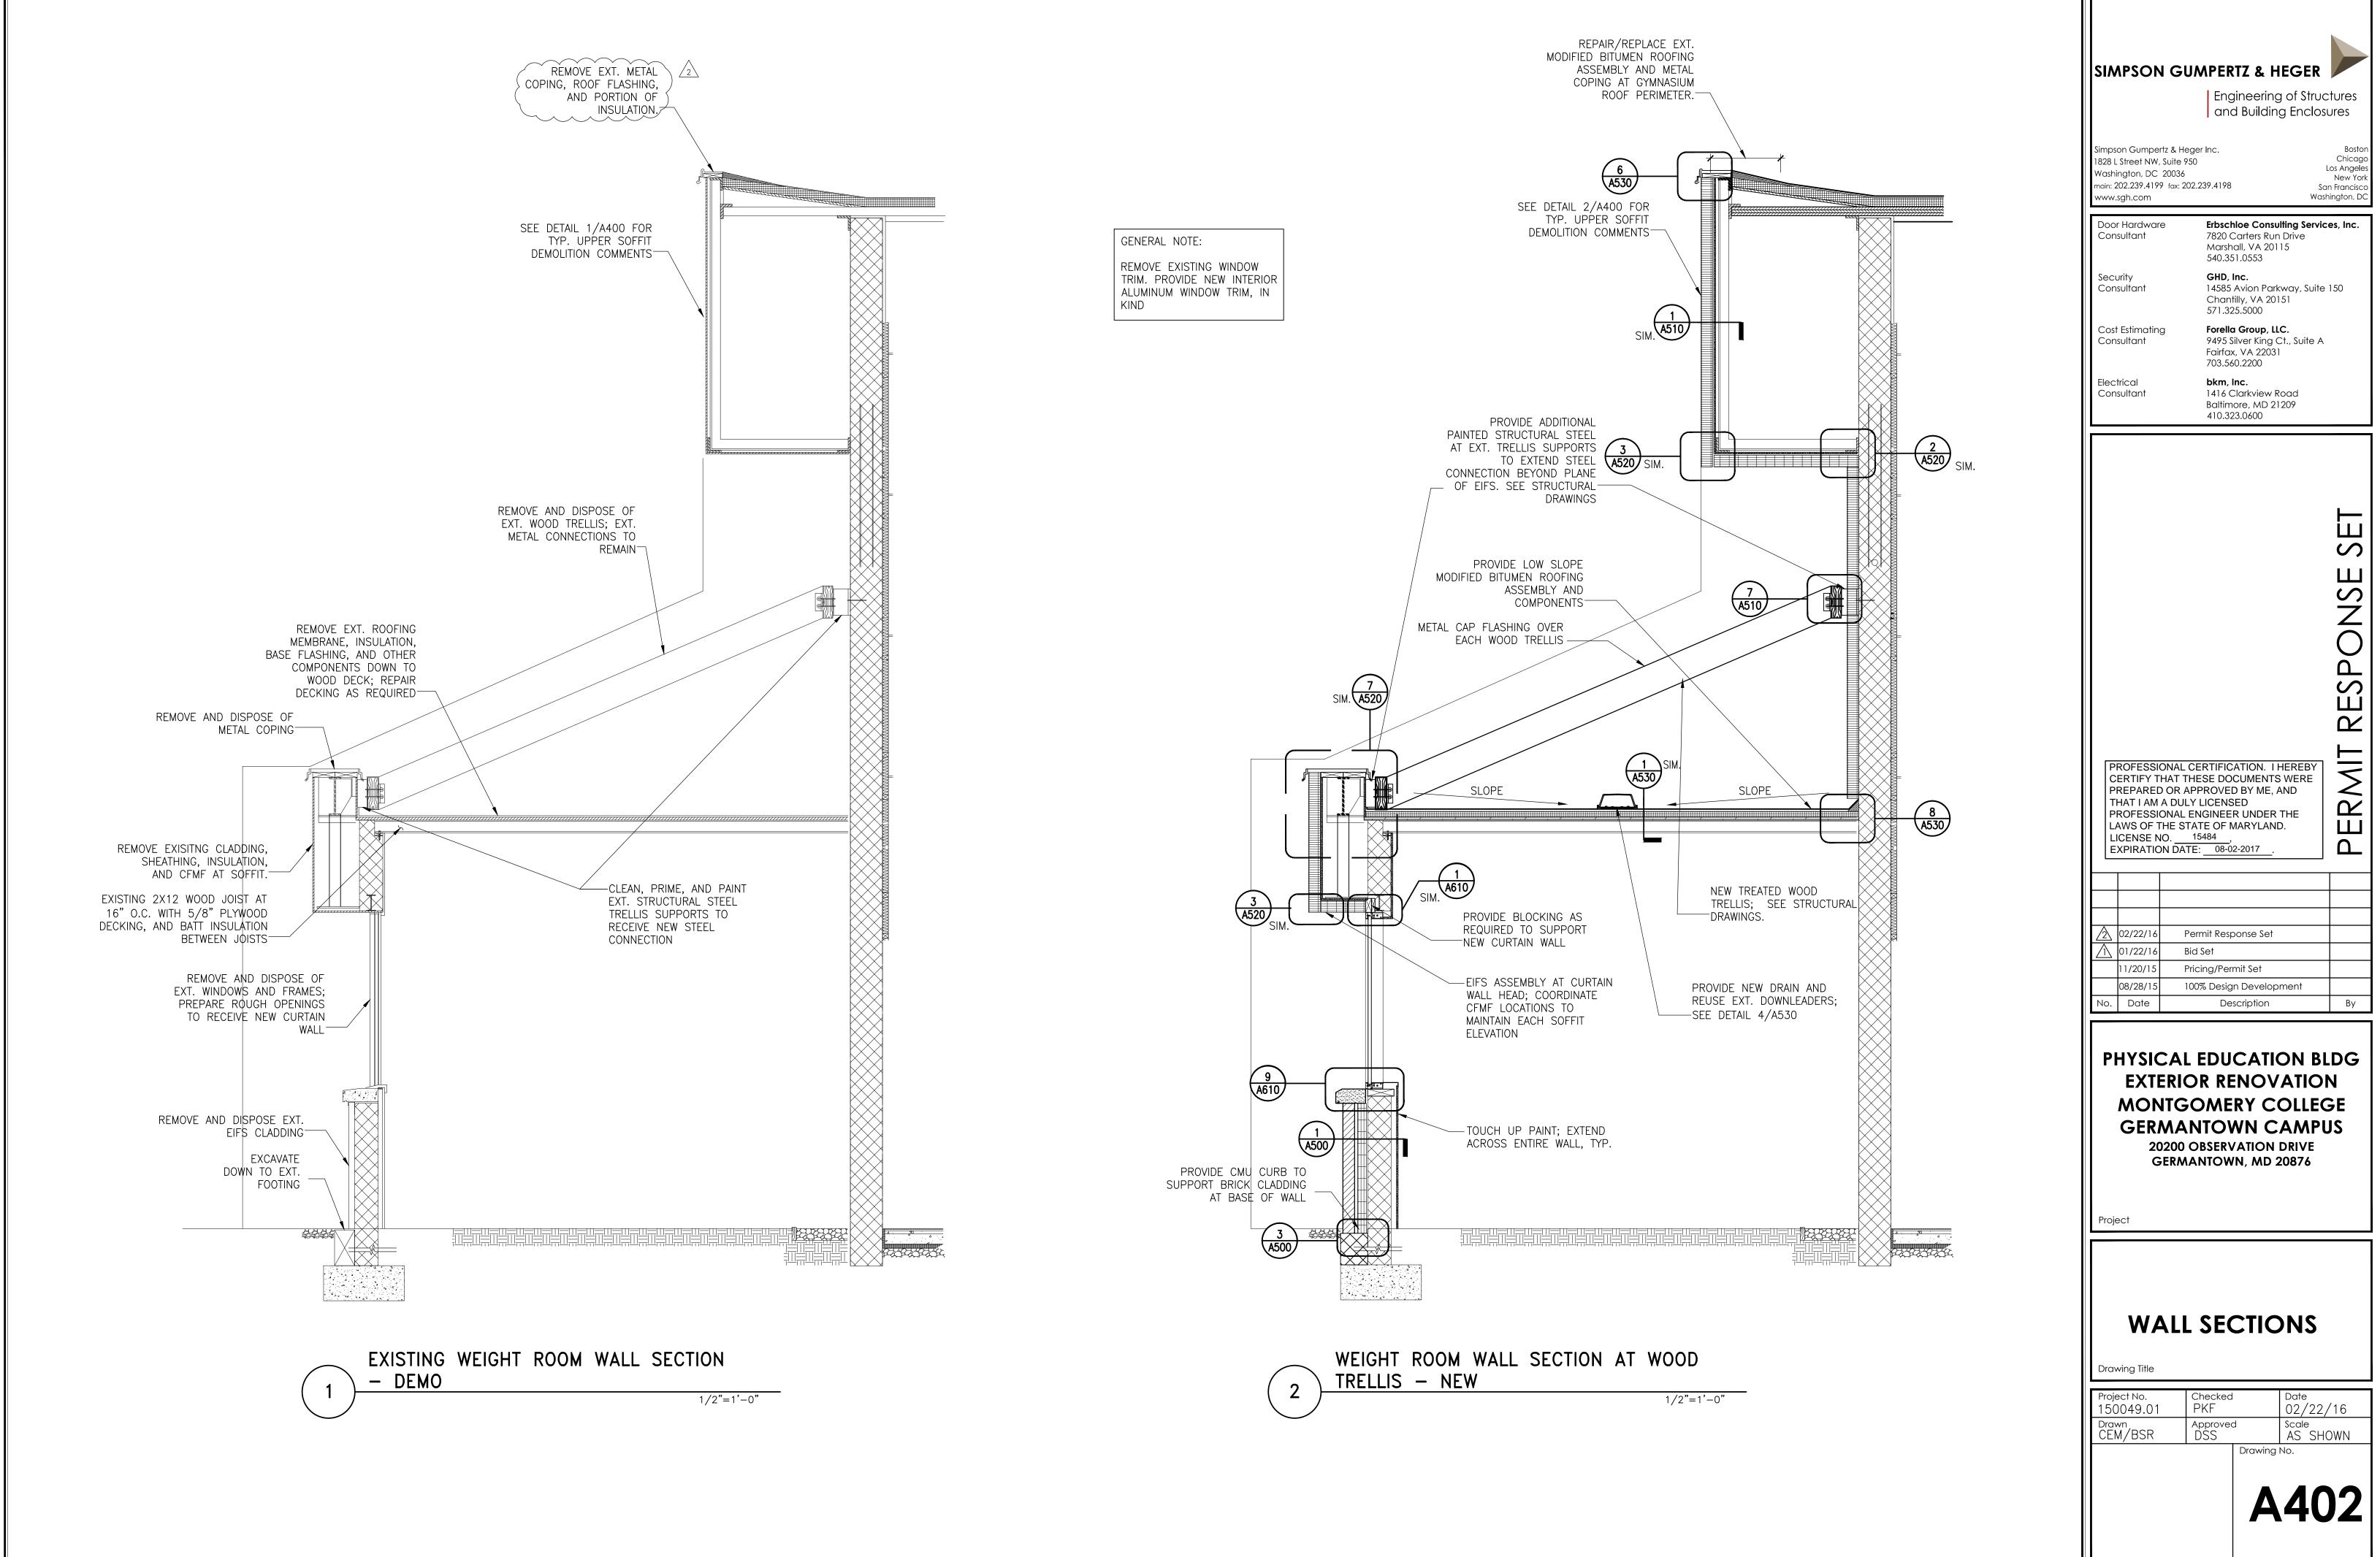
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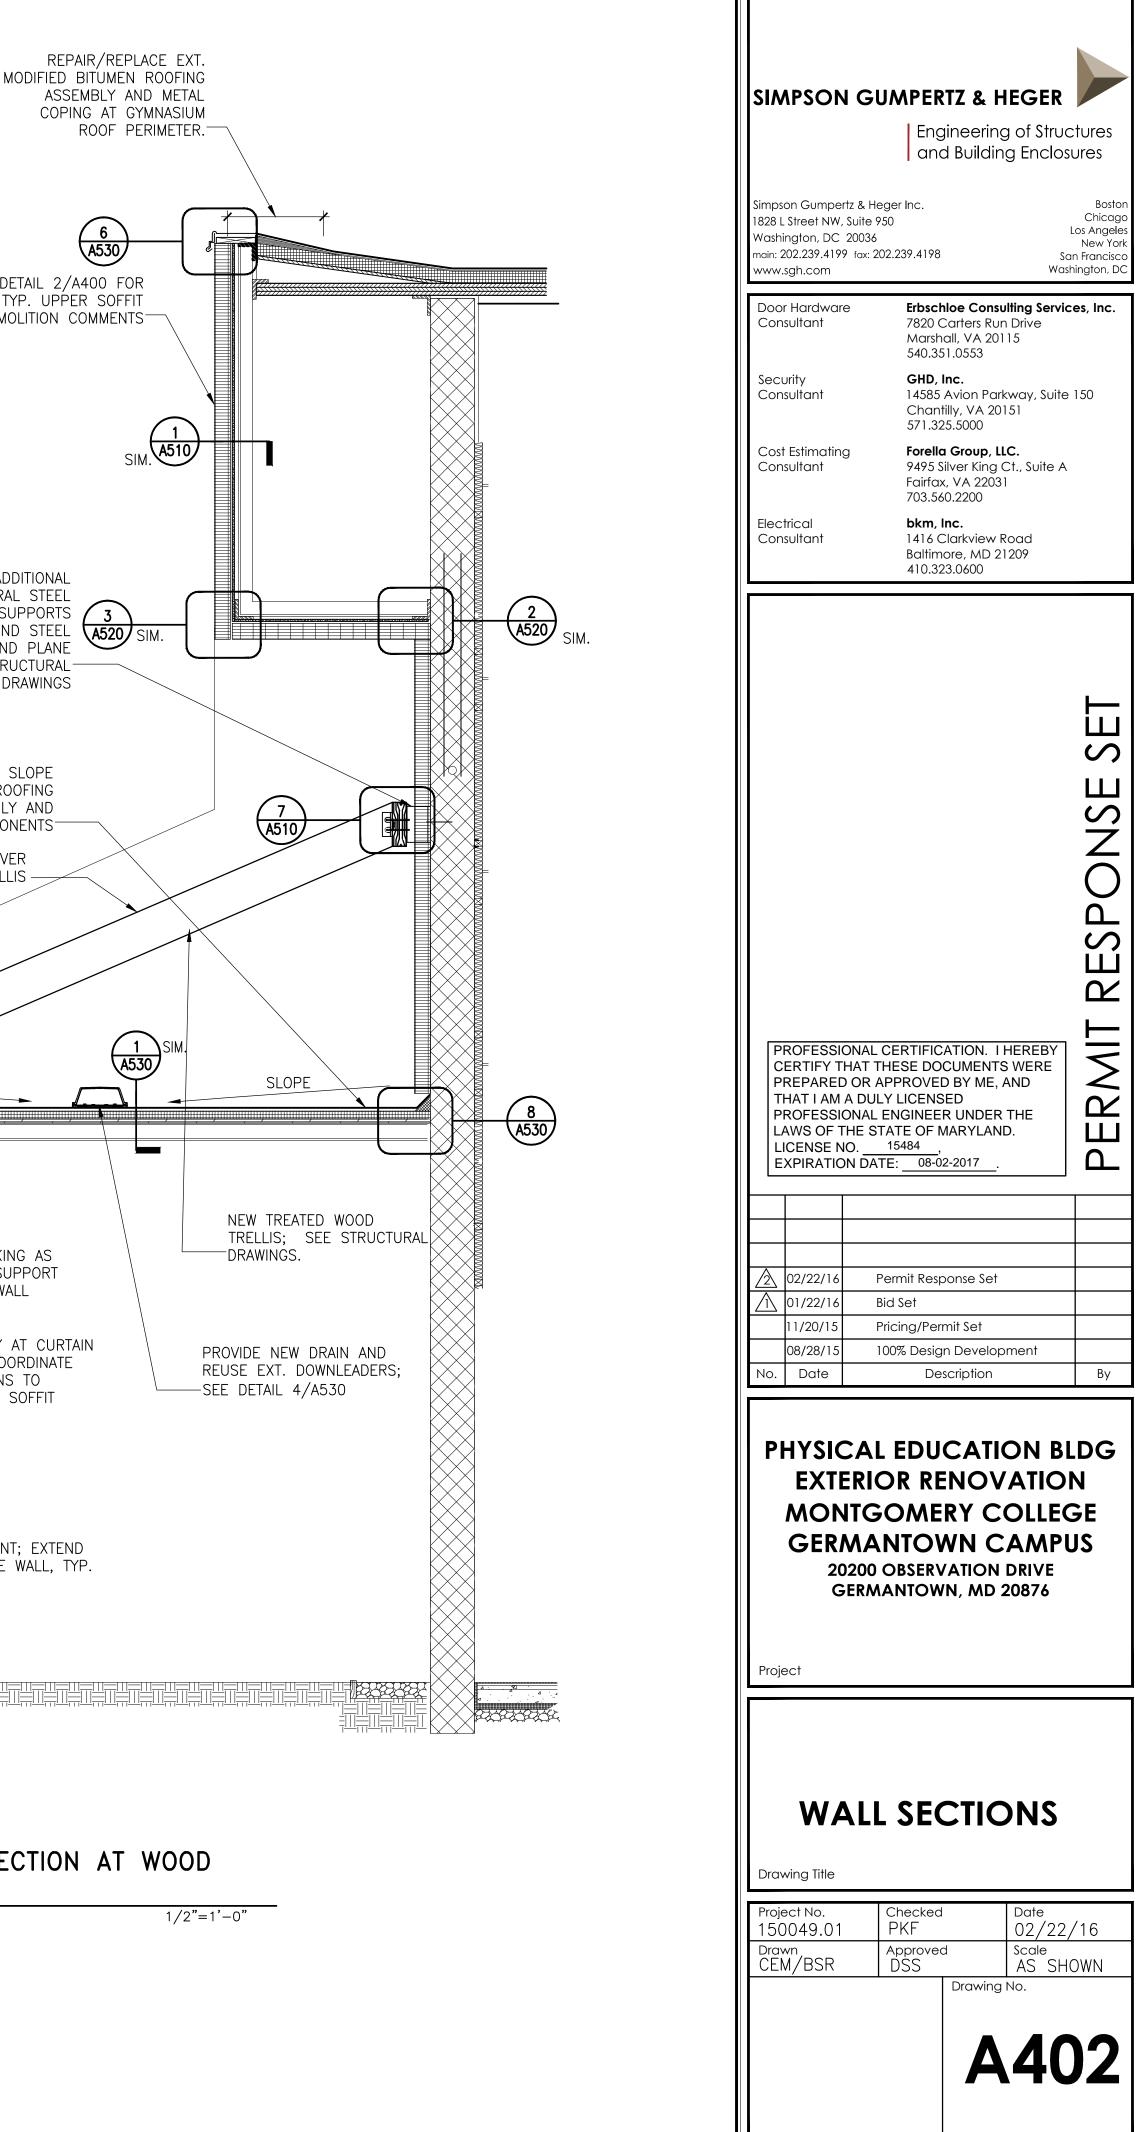
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		Engineering of	Engineering of Structures and Building Enclosures	
	Simpson Gumpertz & H 1828 L Street NW, Suite Washington, DC 2003 main: 202.239.4199 fax: www.sgh.com	950 6	Boston Chicago Los Angeles New York San Francisco Washington, DC	
	Door Hardware Consultant	Erbschloe Consultin 7820 Carters Run D Marshall, VA 20115 540.351.0553	rive	
	Security Consultant	GHD, Inc. 14585 Avion Parkw Chantilly, VA 20151 571.325.5000		
	Cost Estimating Consultant	Forella Group, LLC. 9495 Silver King Ct. Fairfax, VA 22031 703.560.2200		
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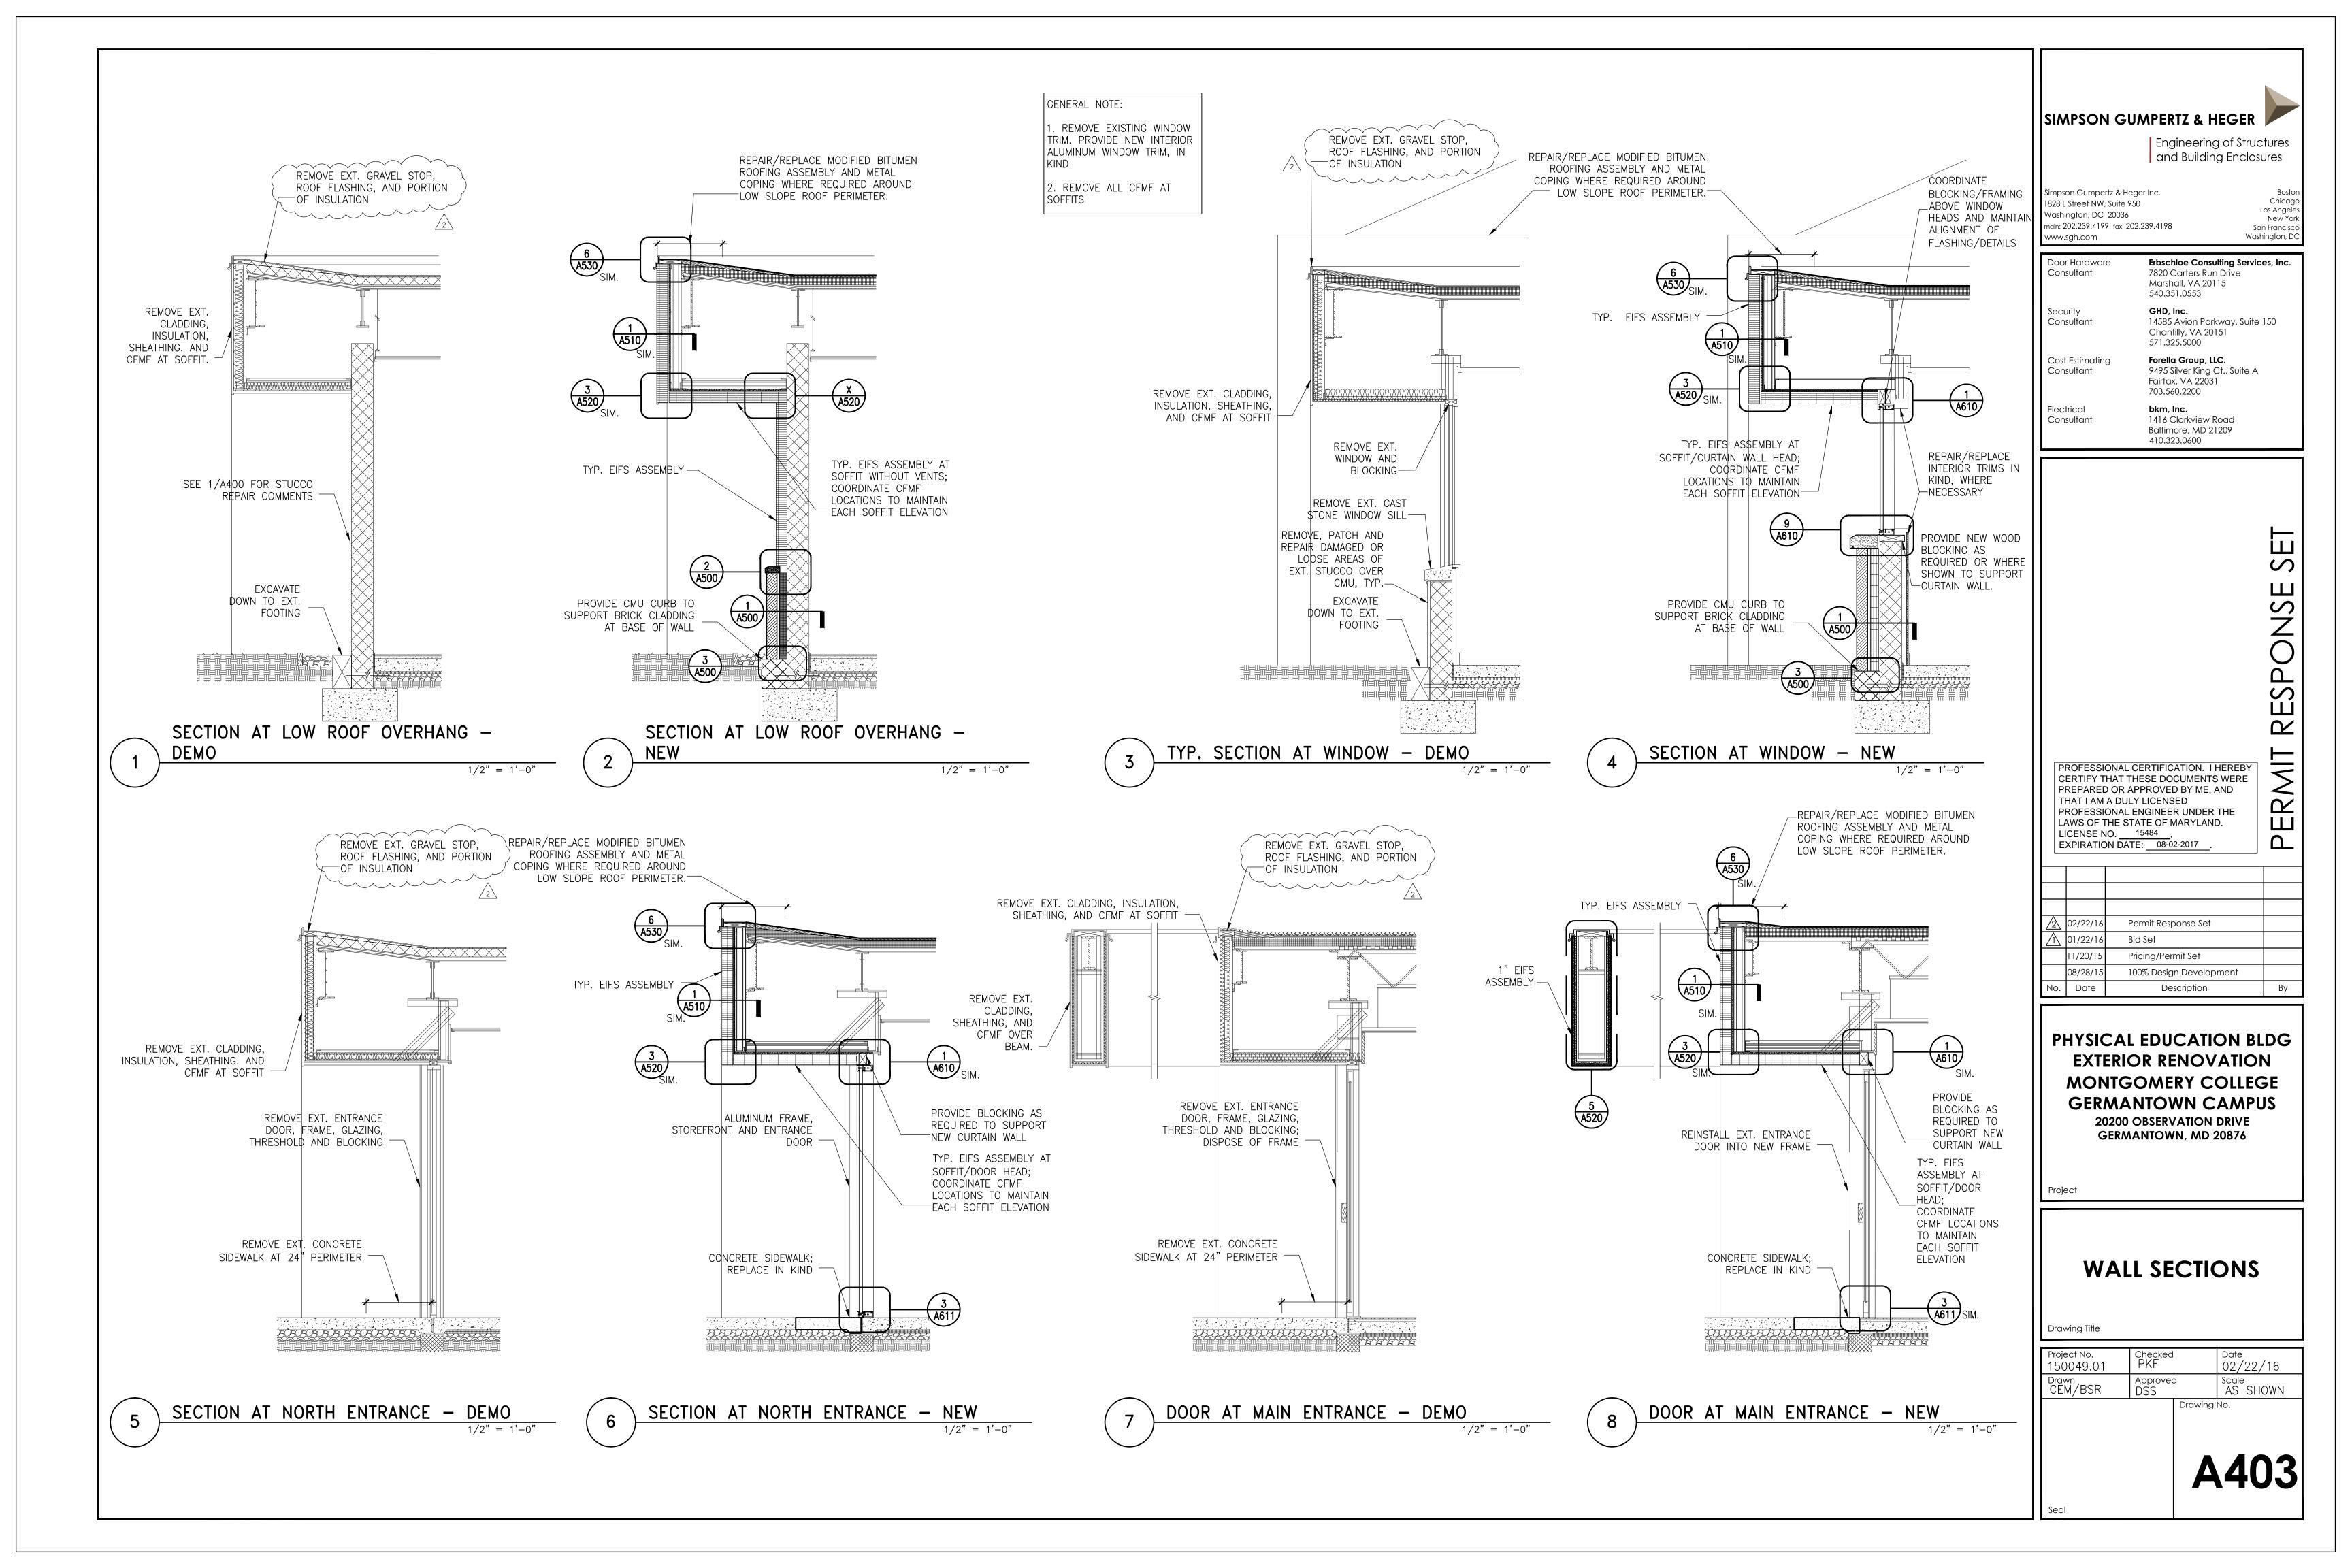



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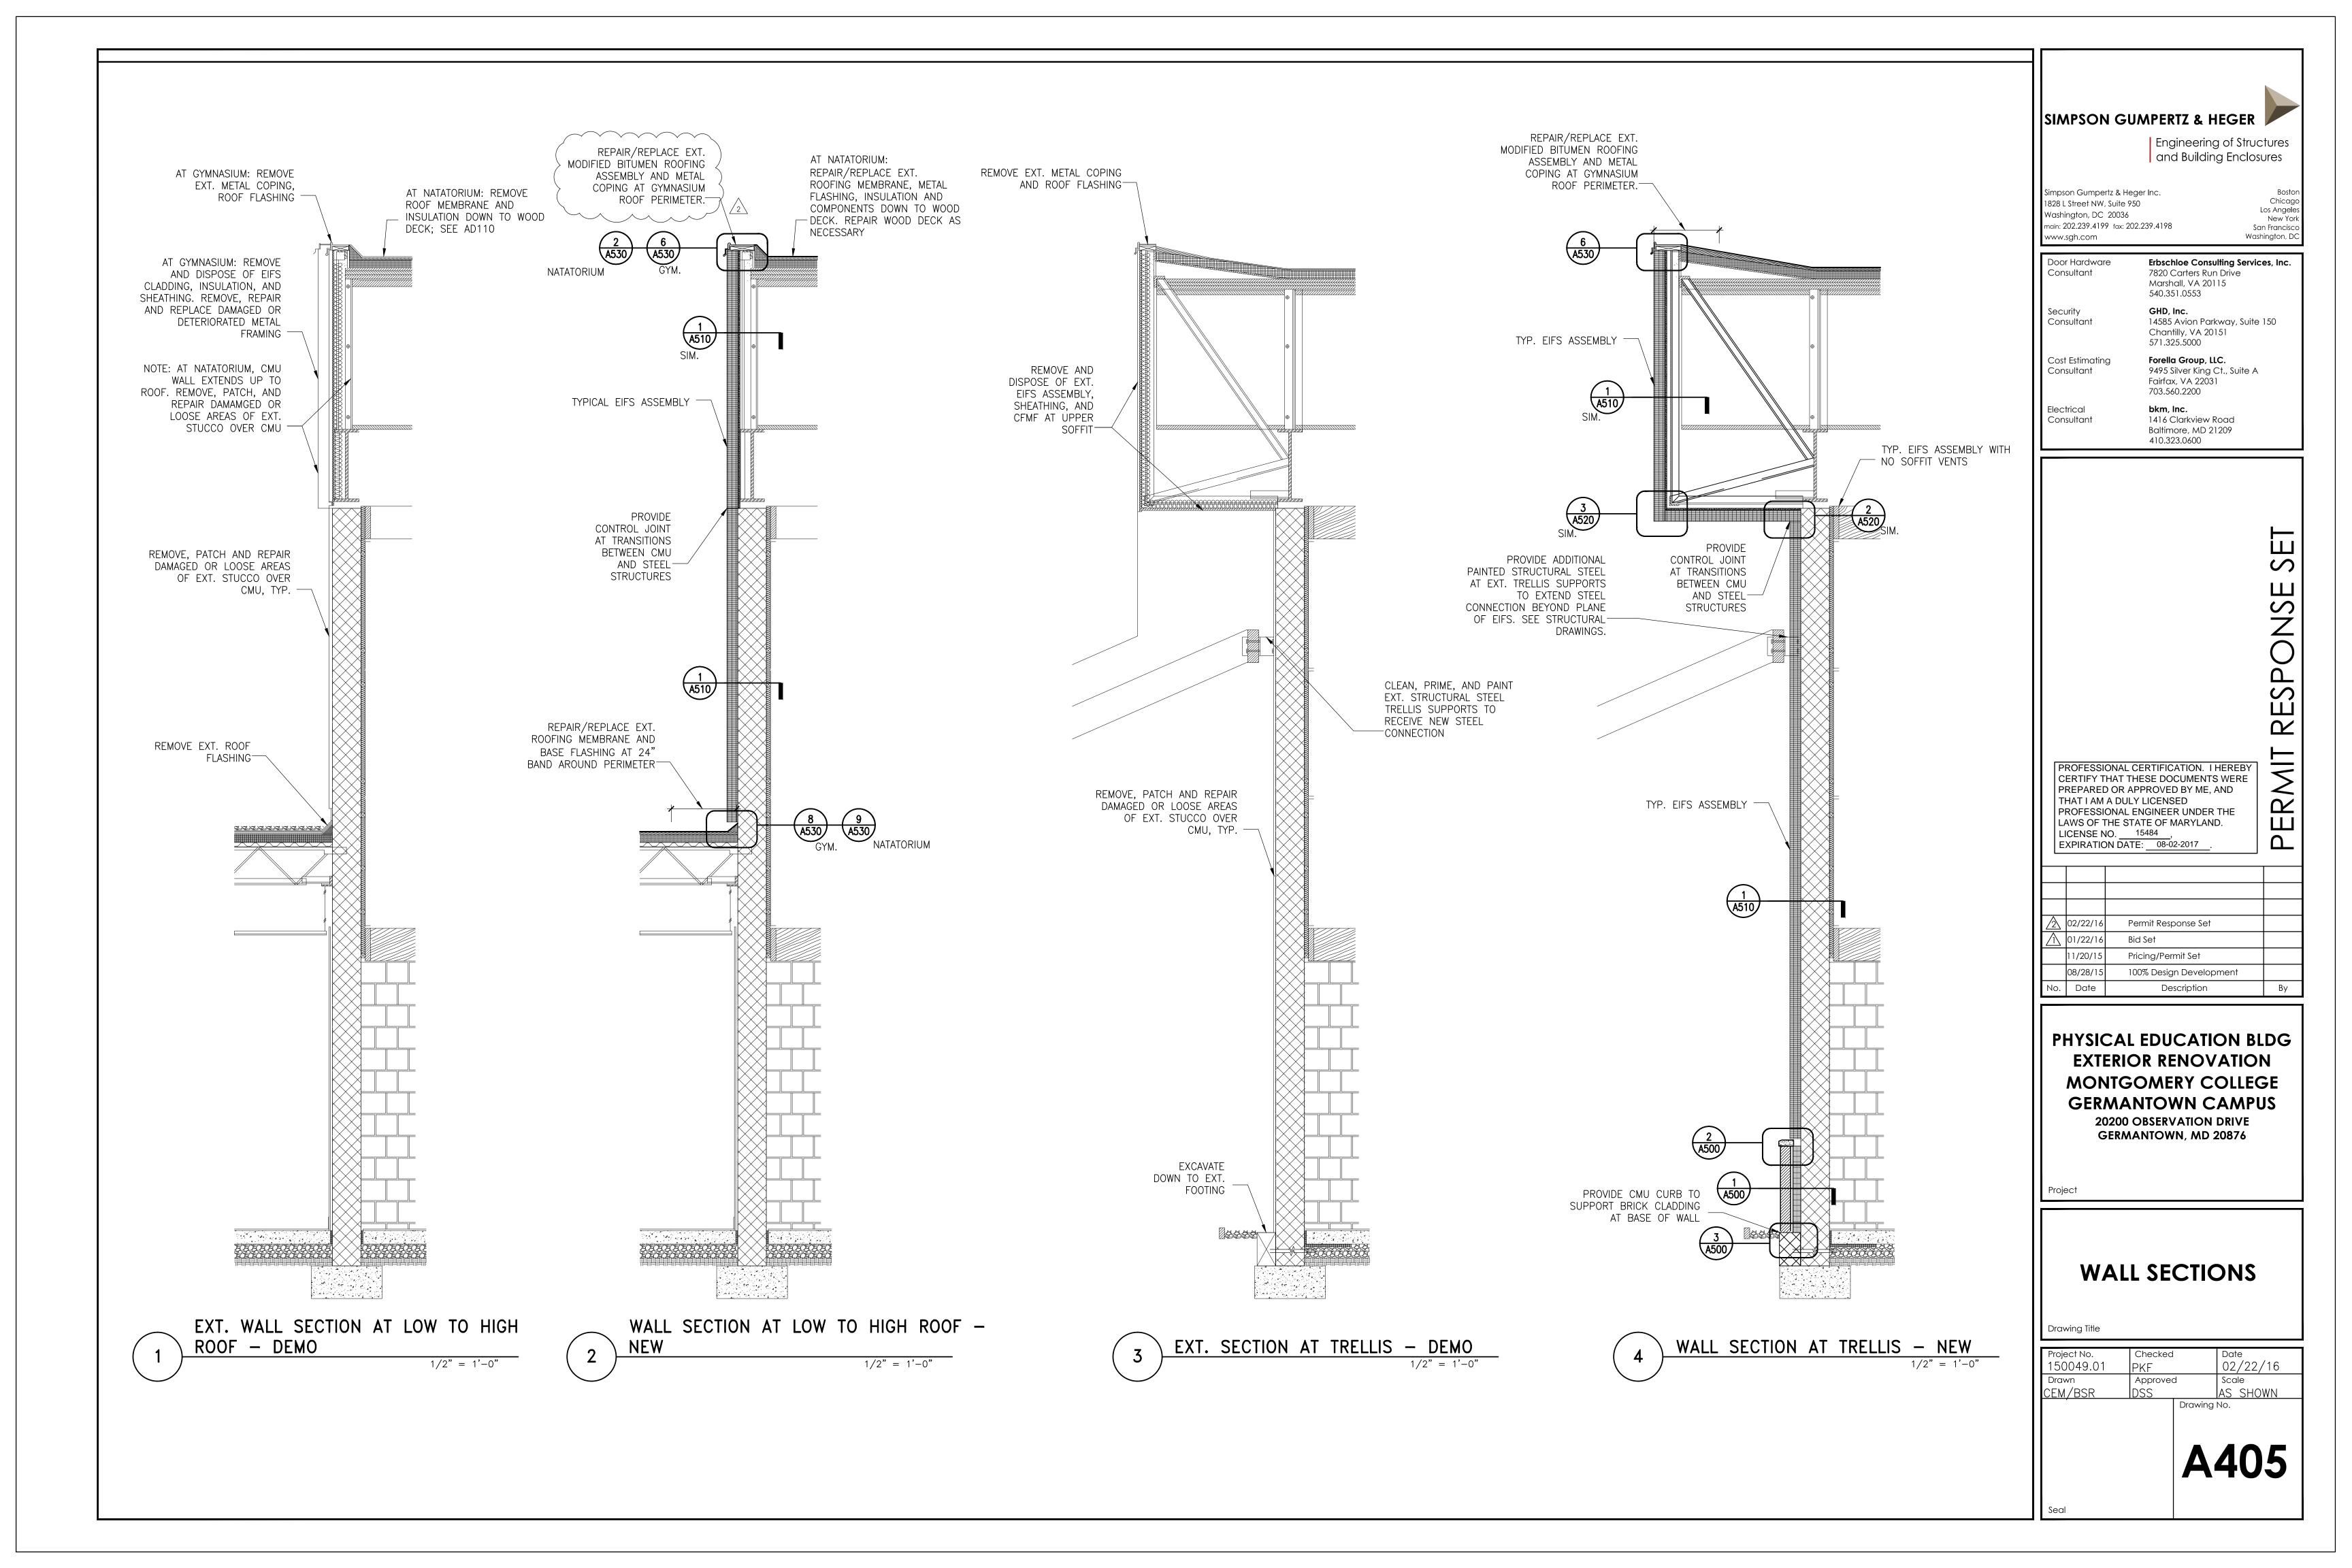


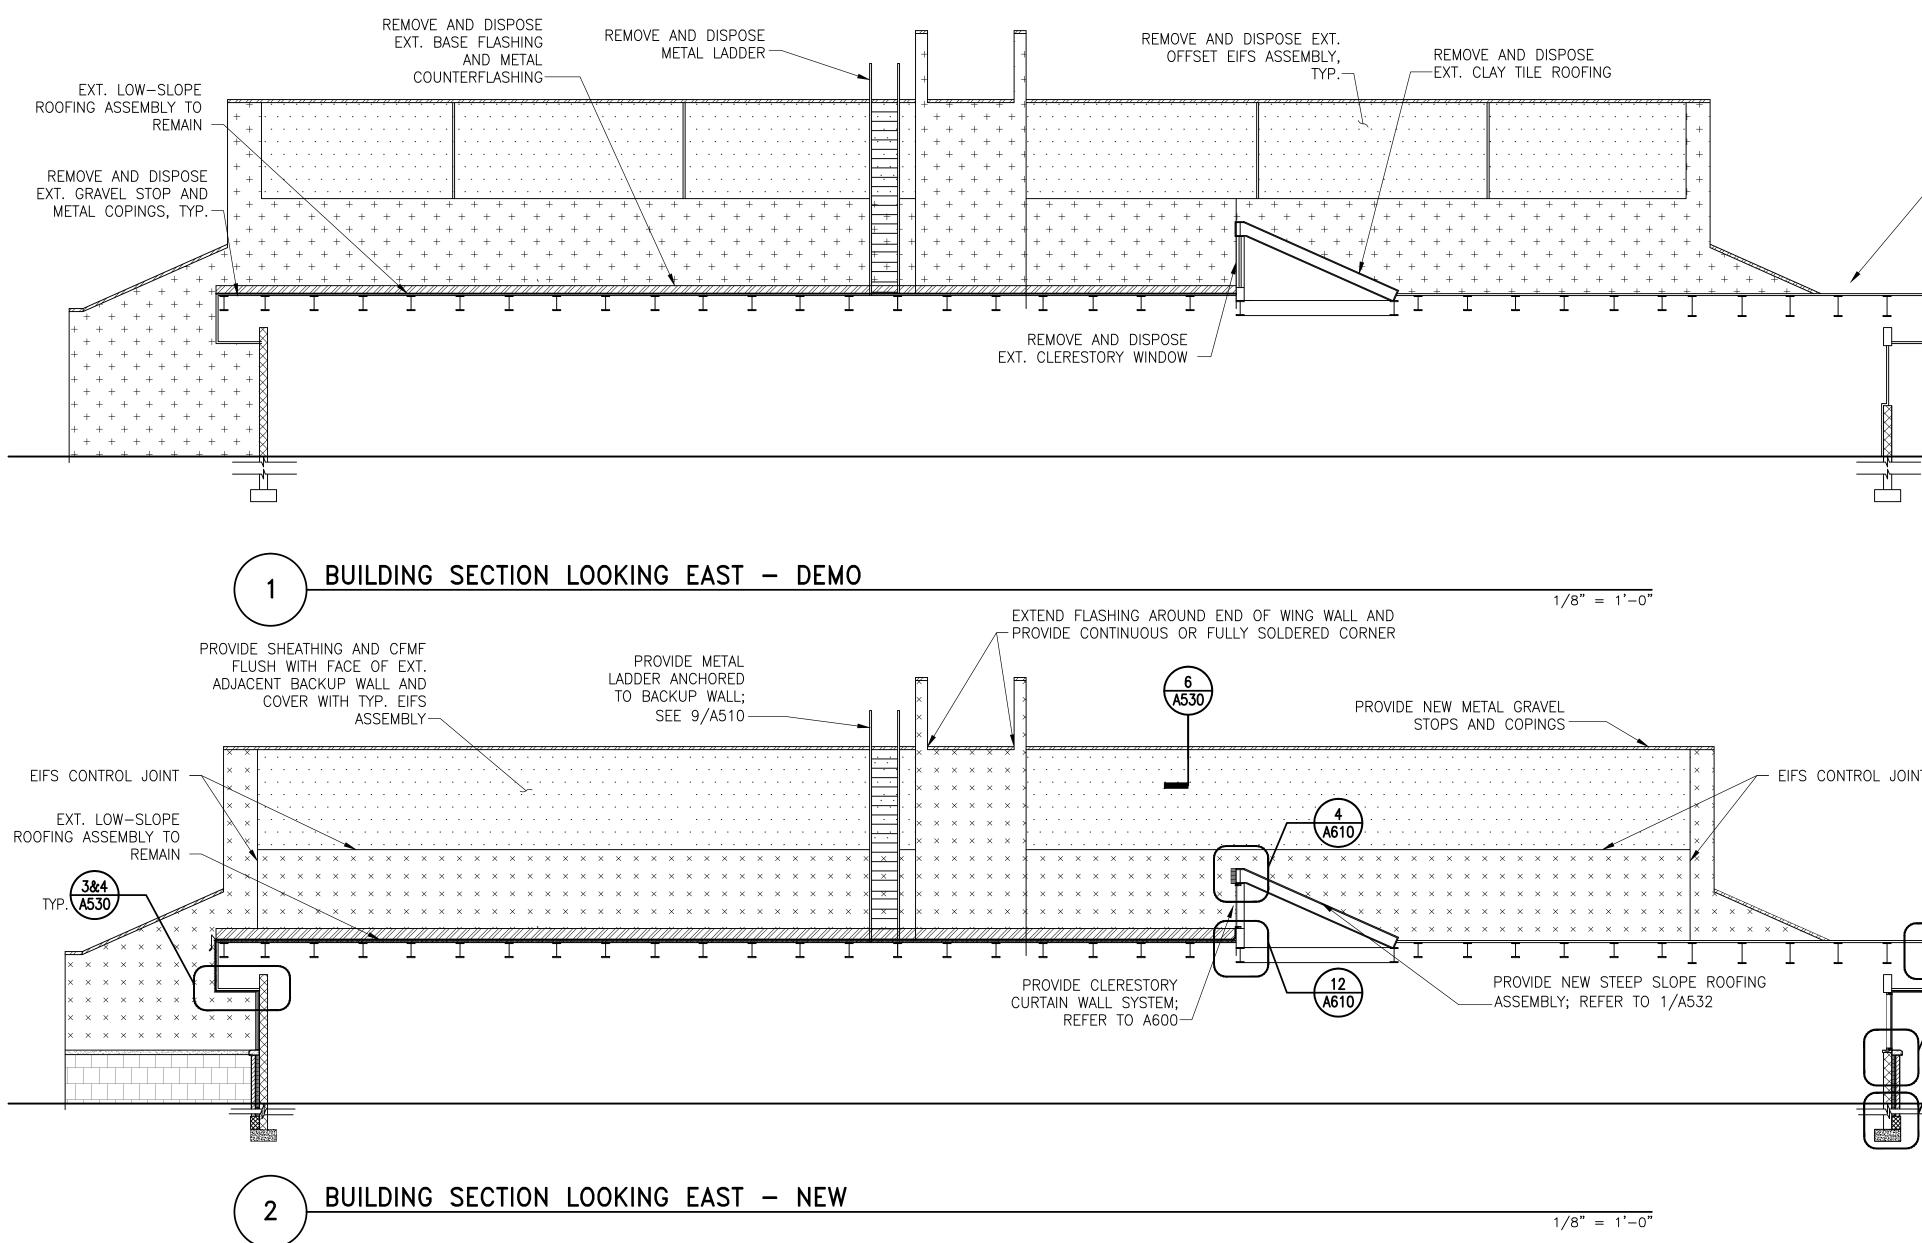


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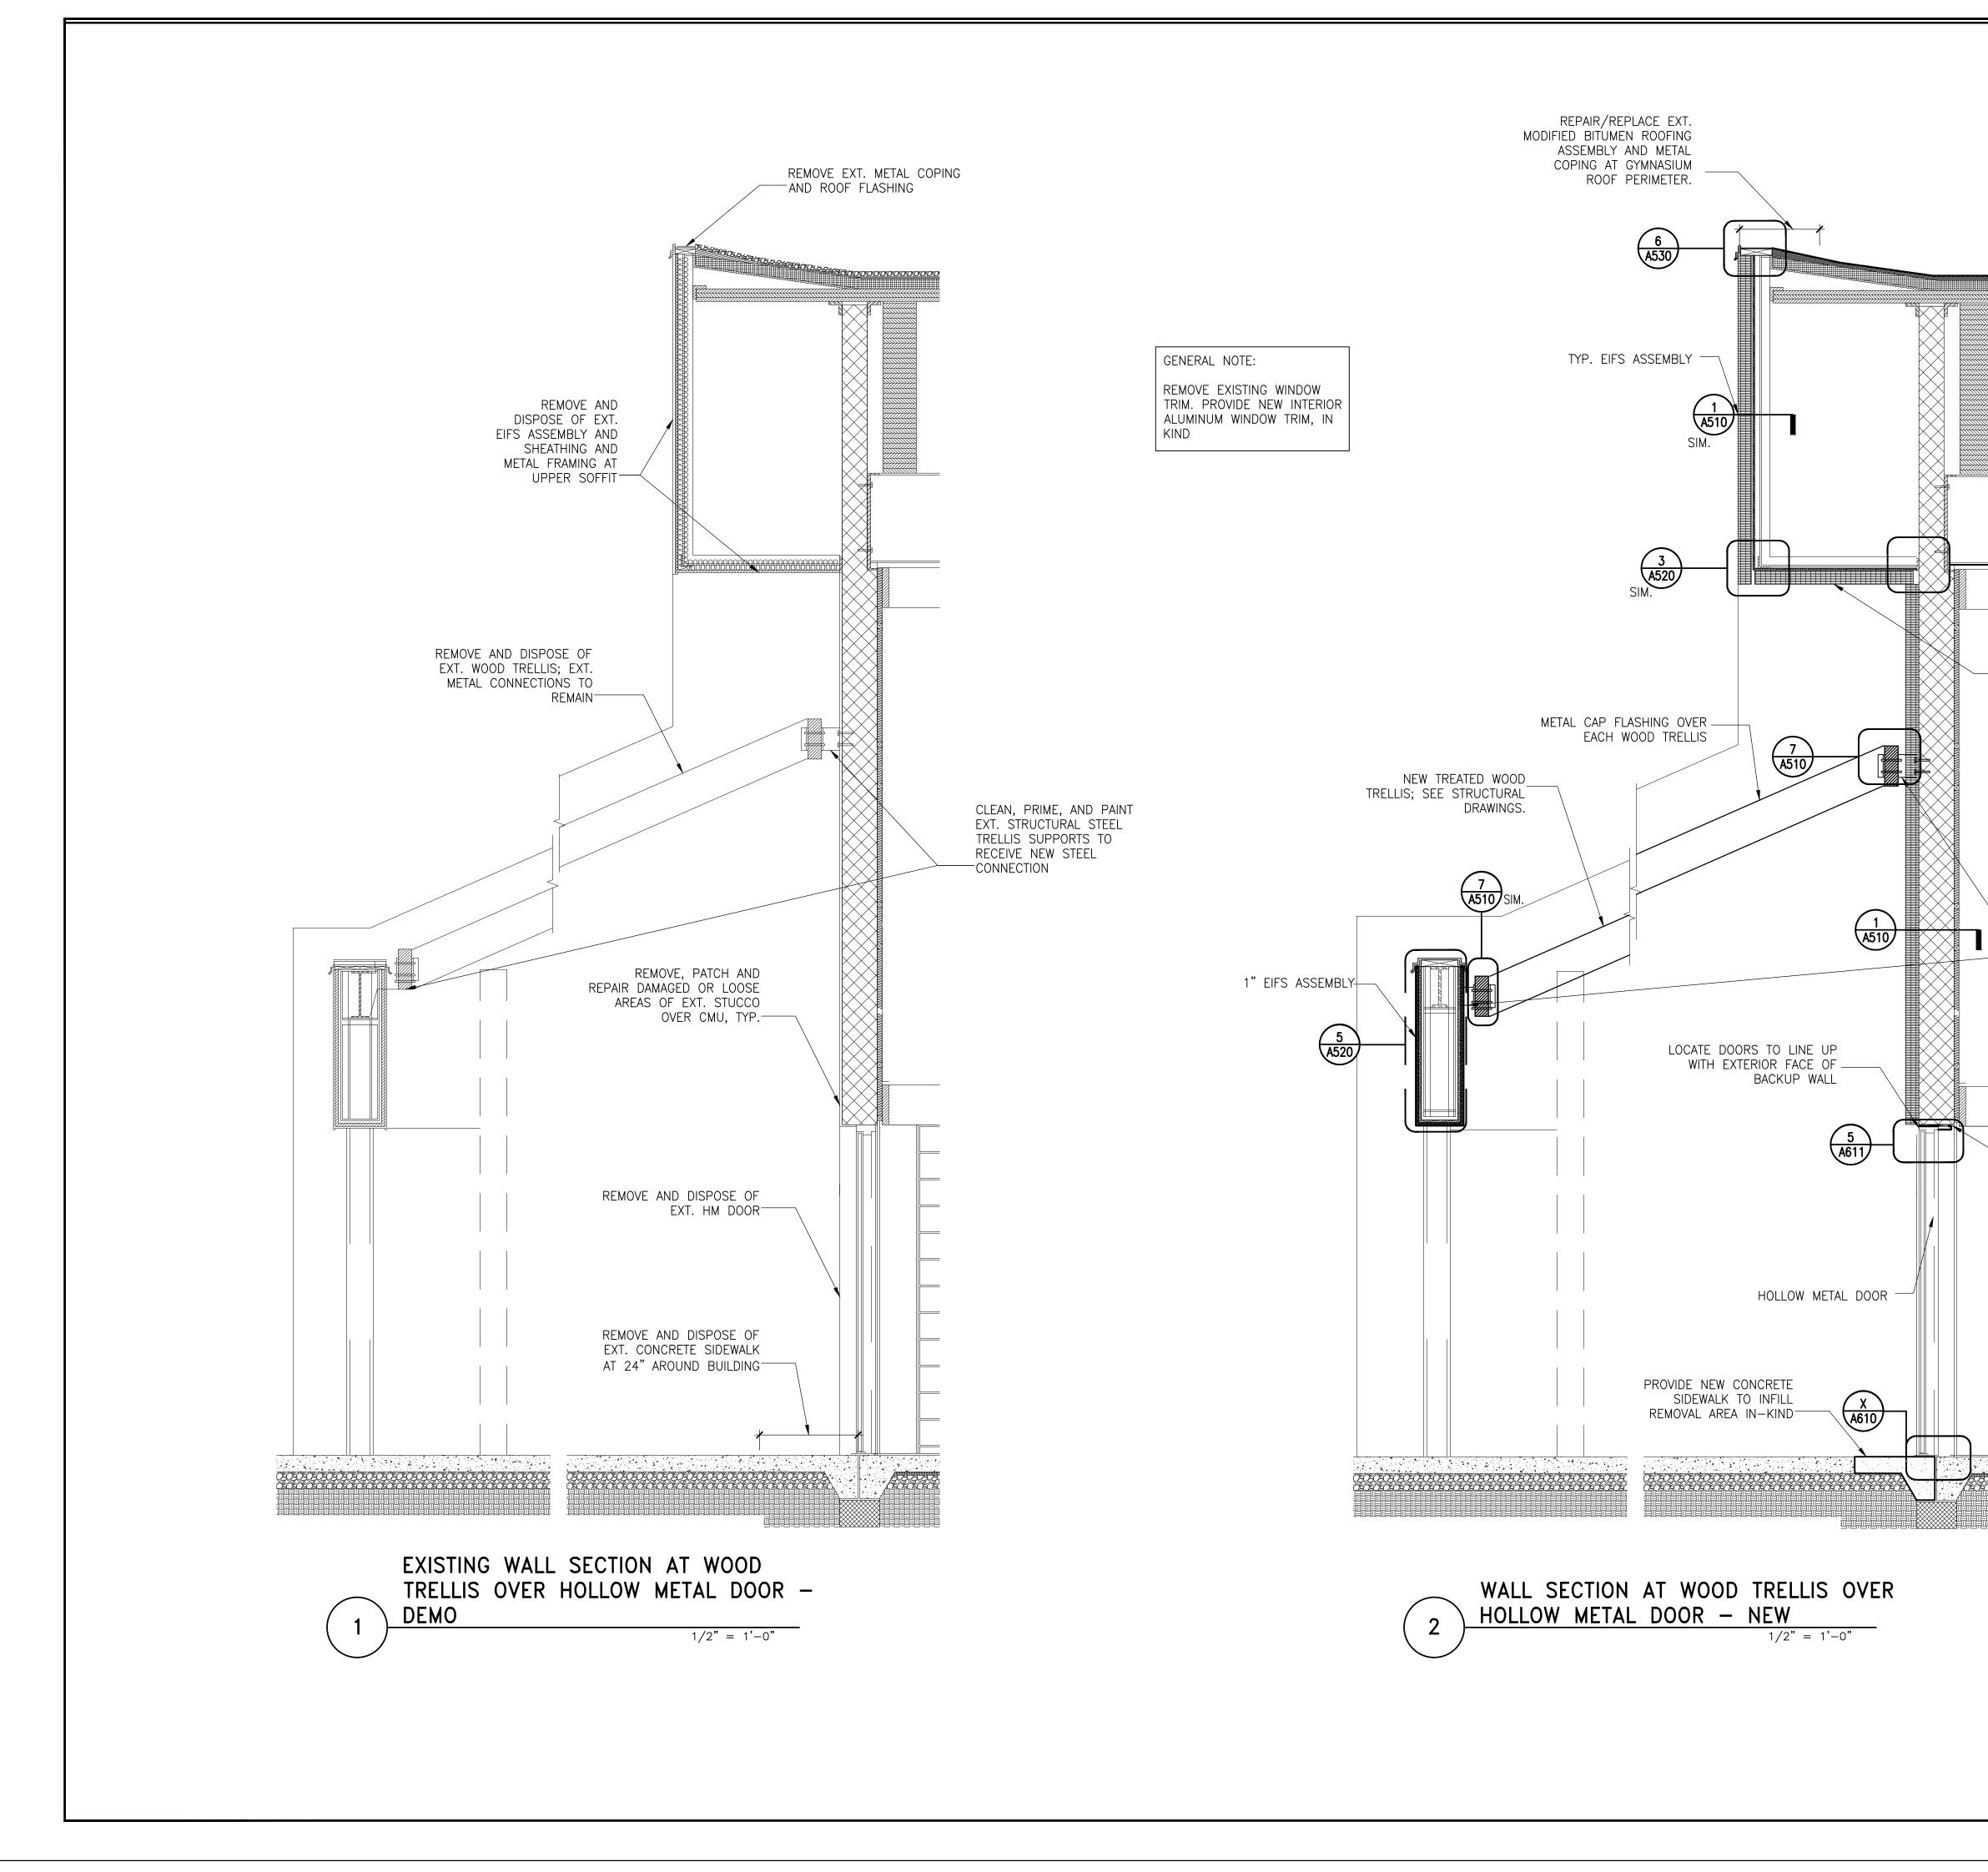
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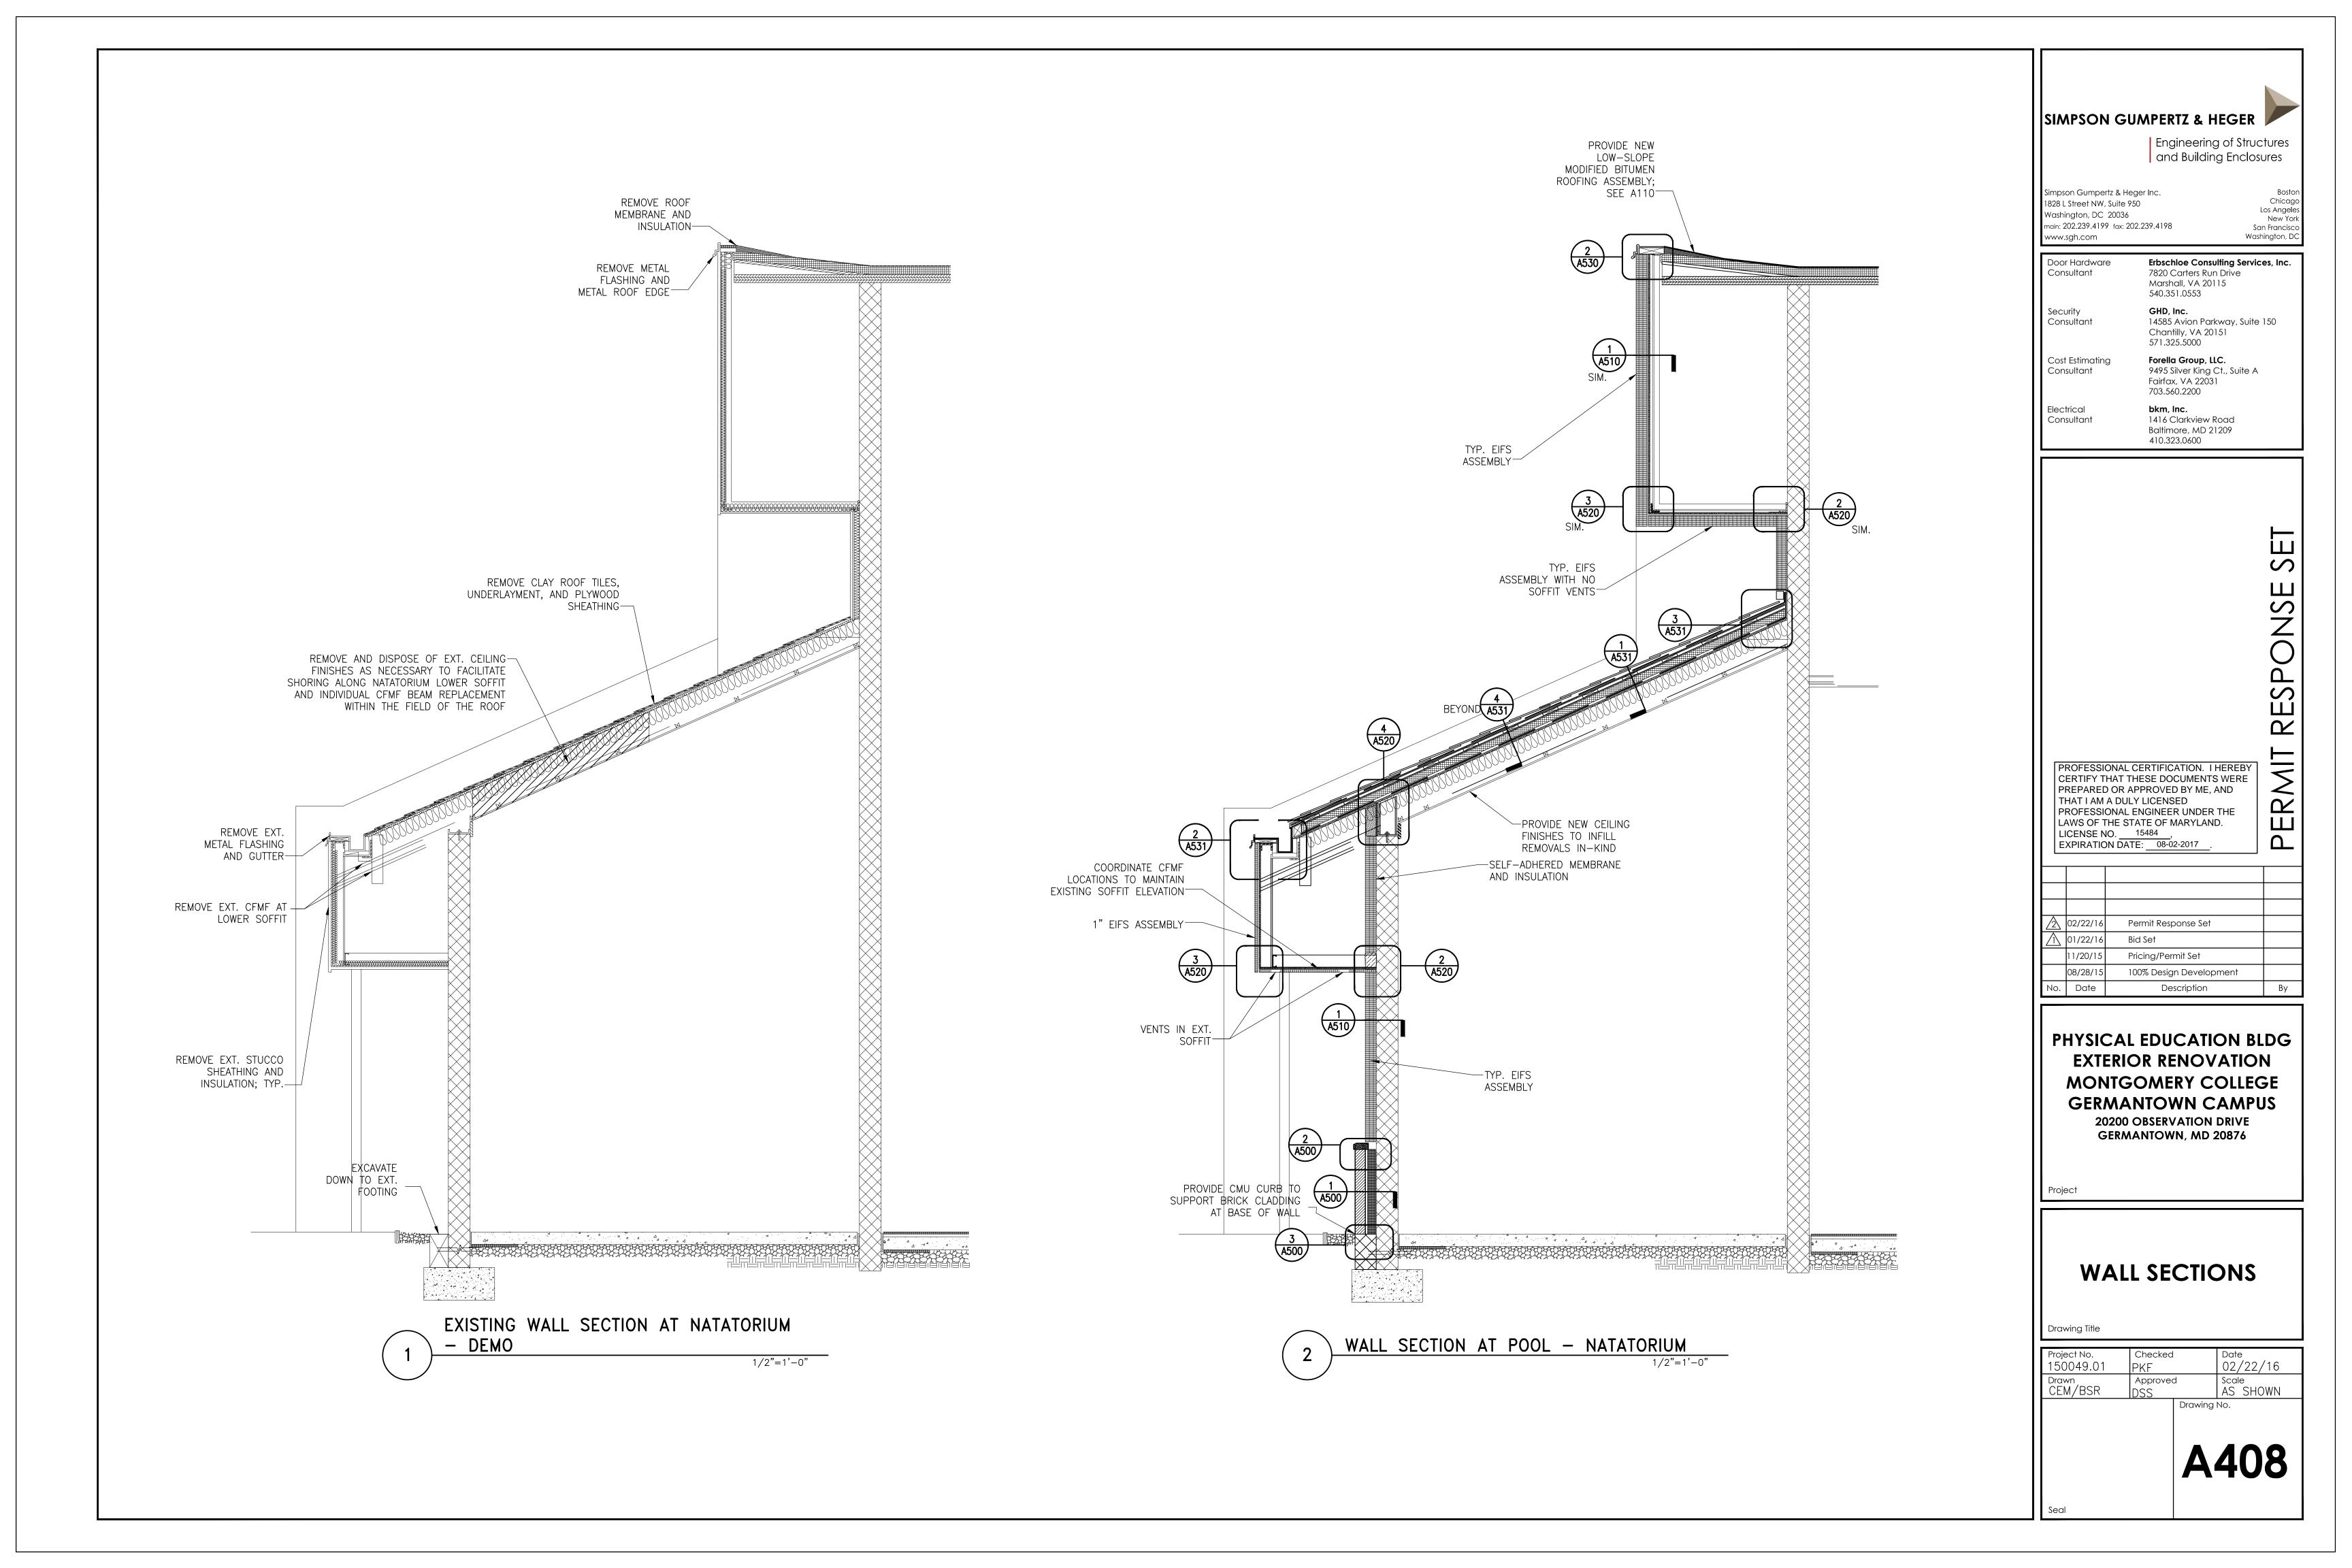
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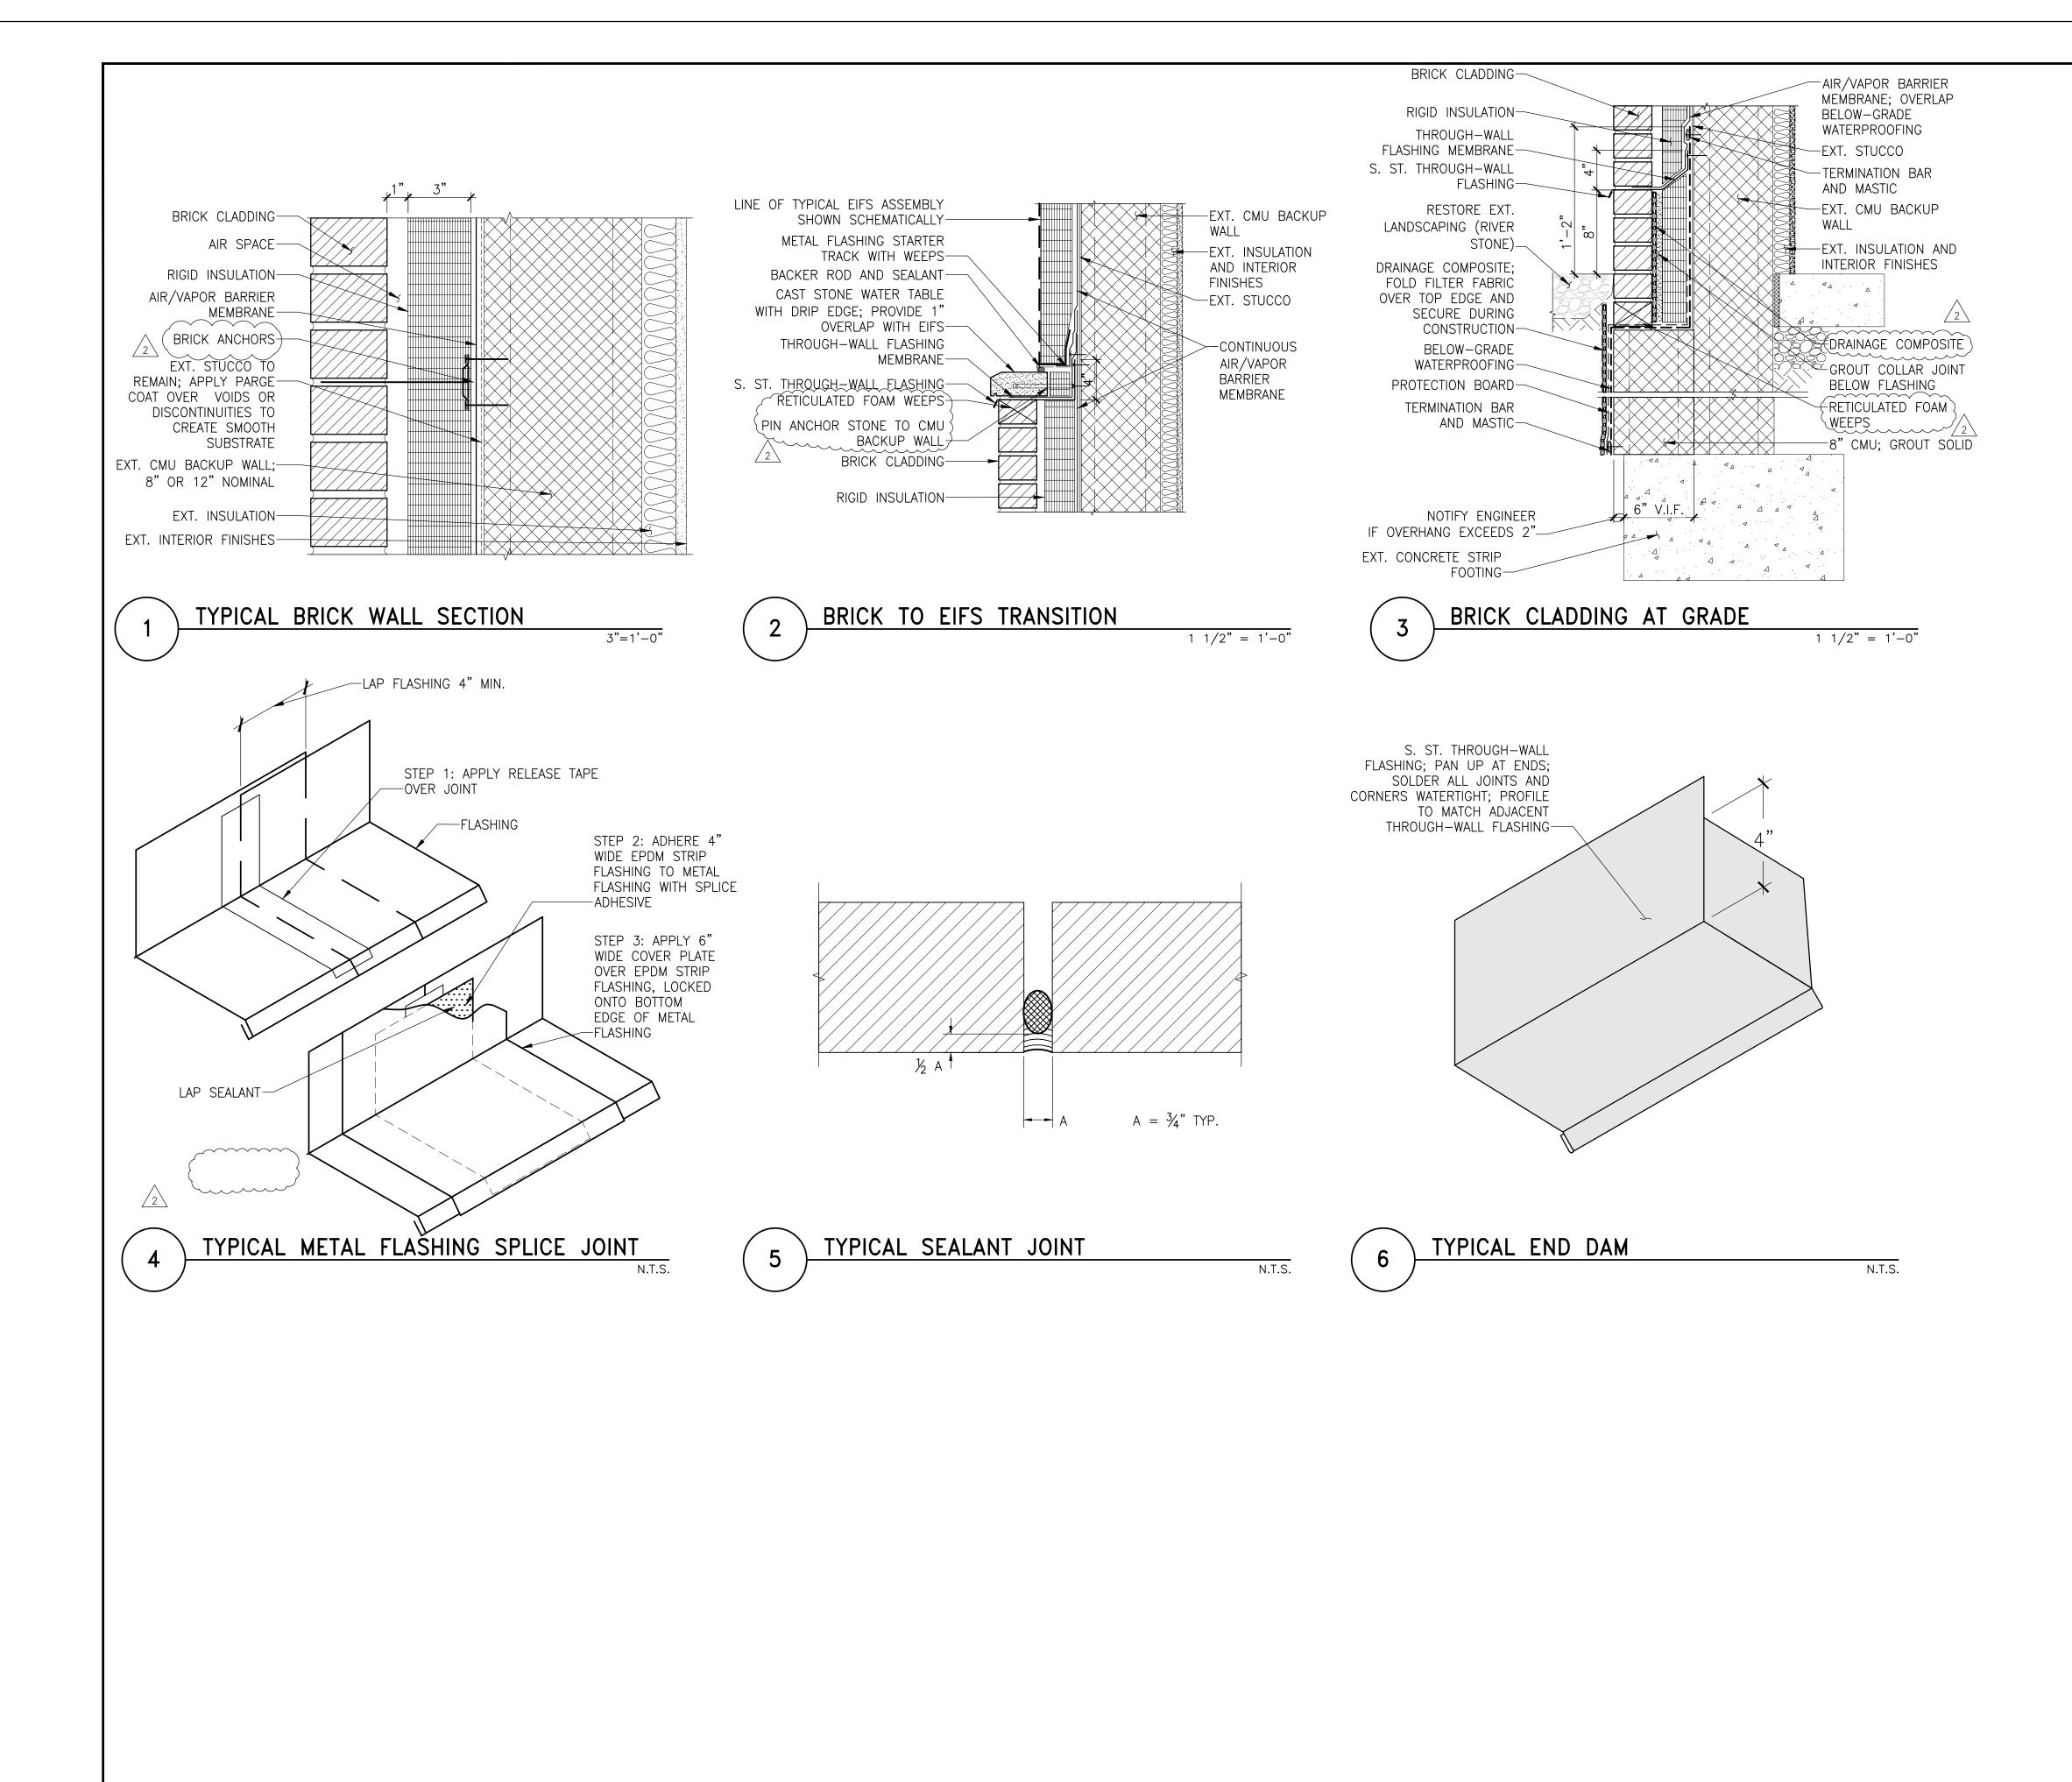
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San Francisco Washington, DC

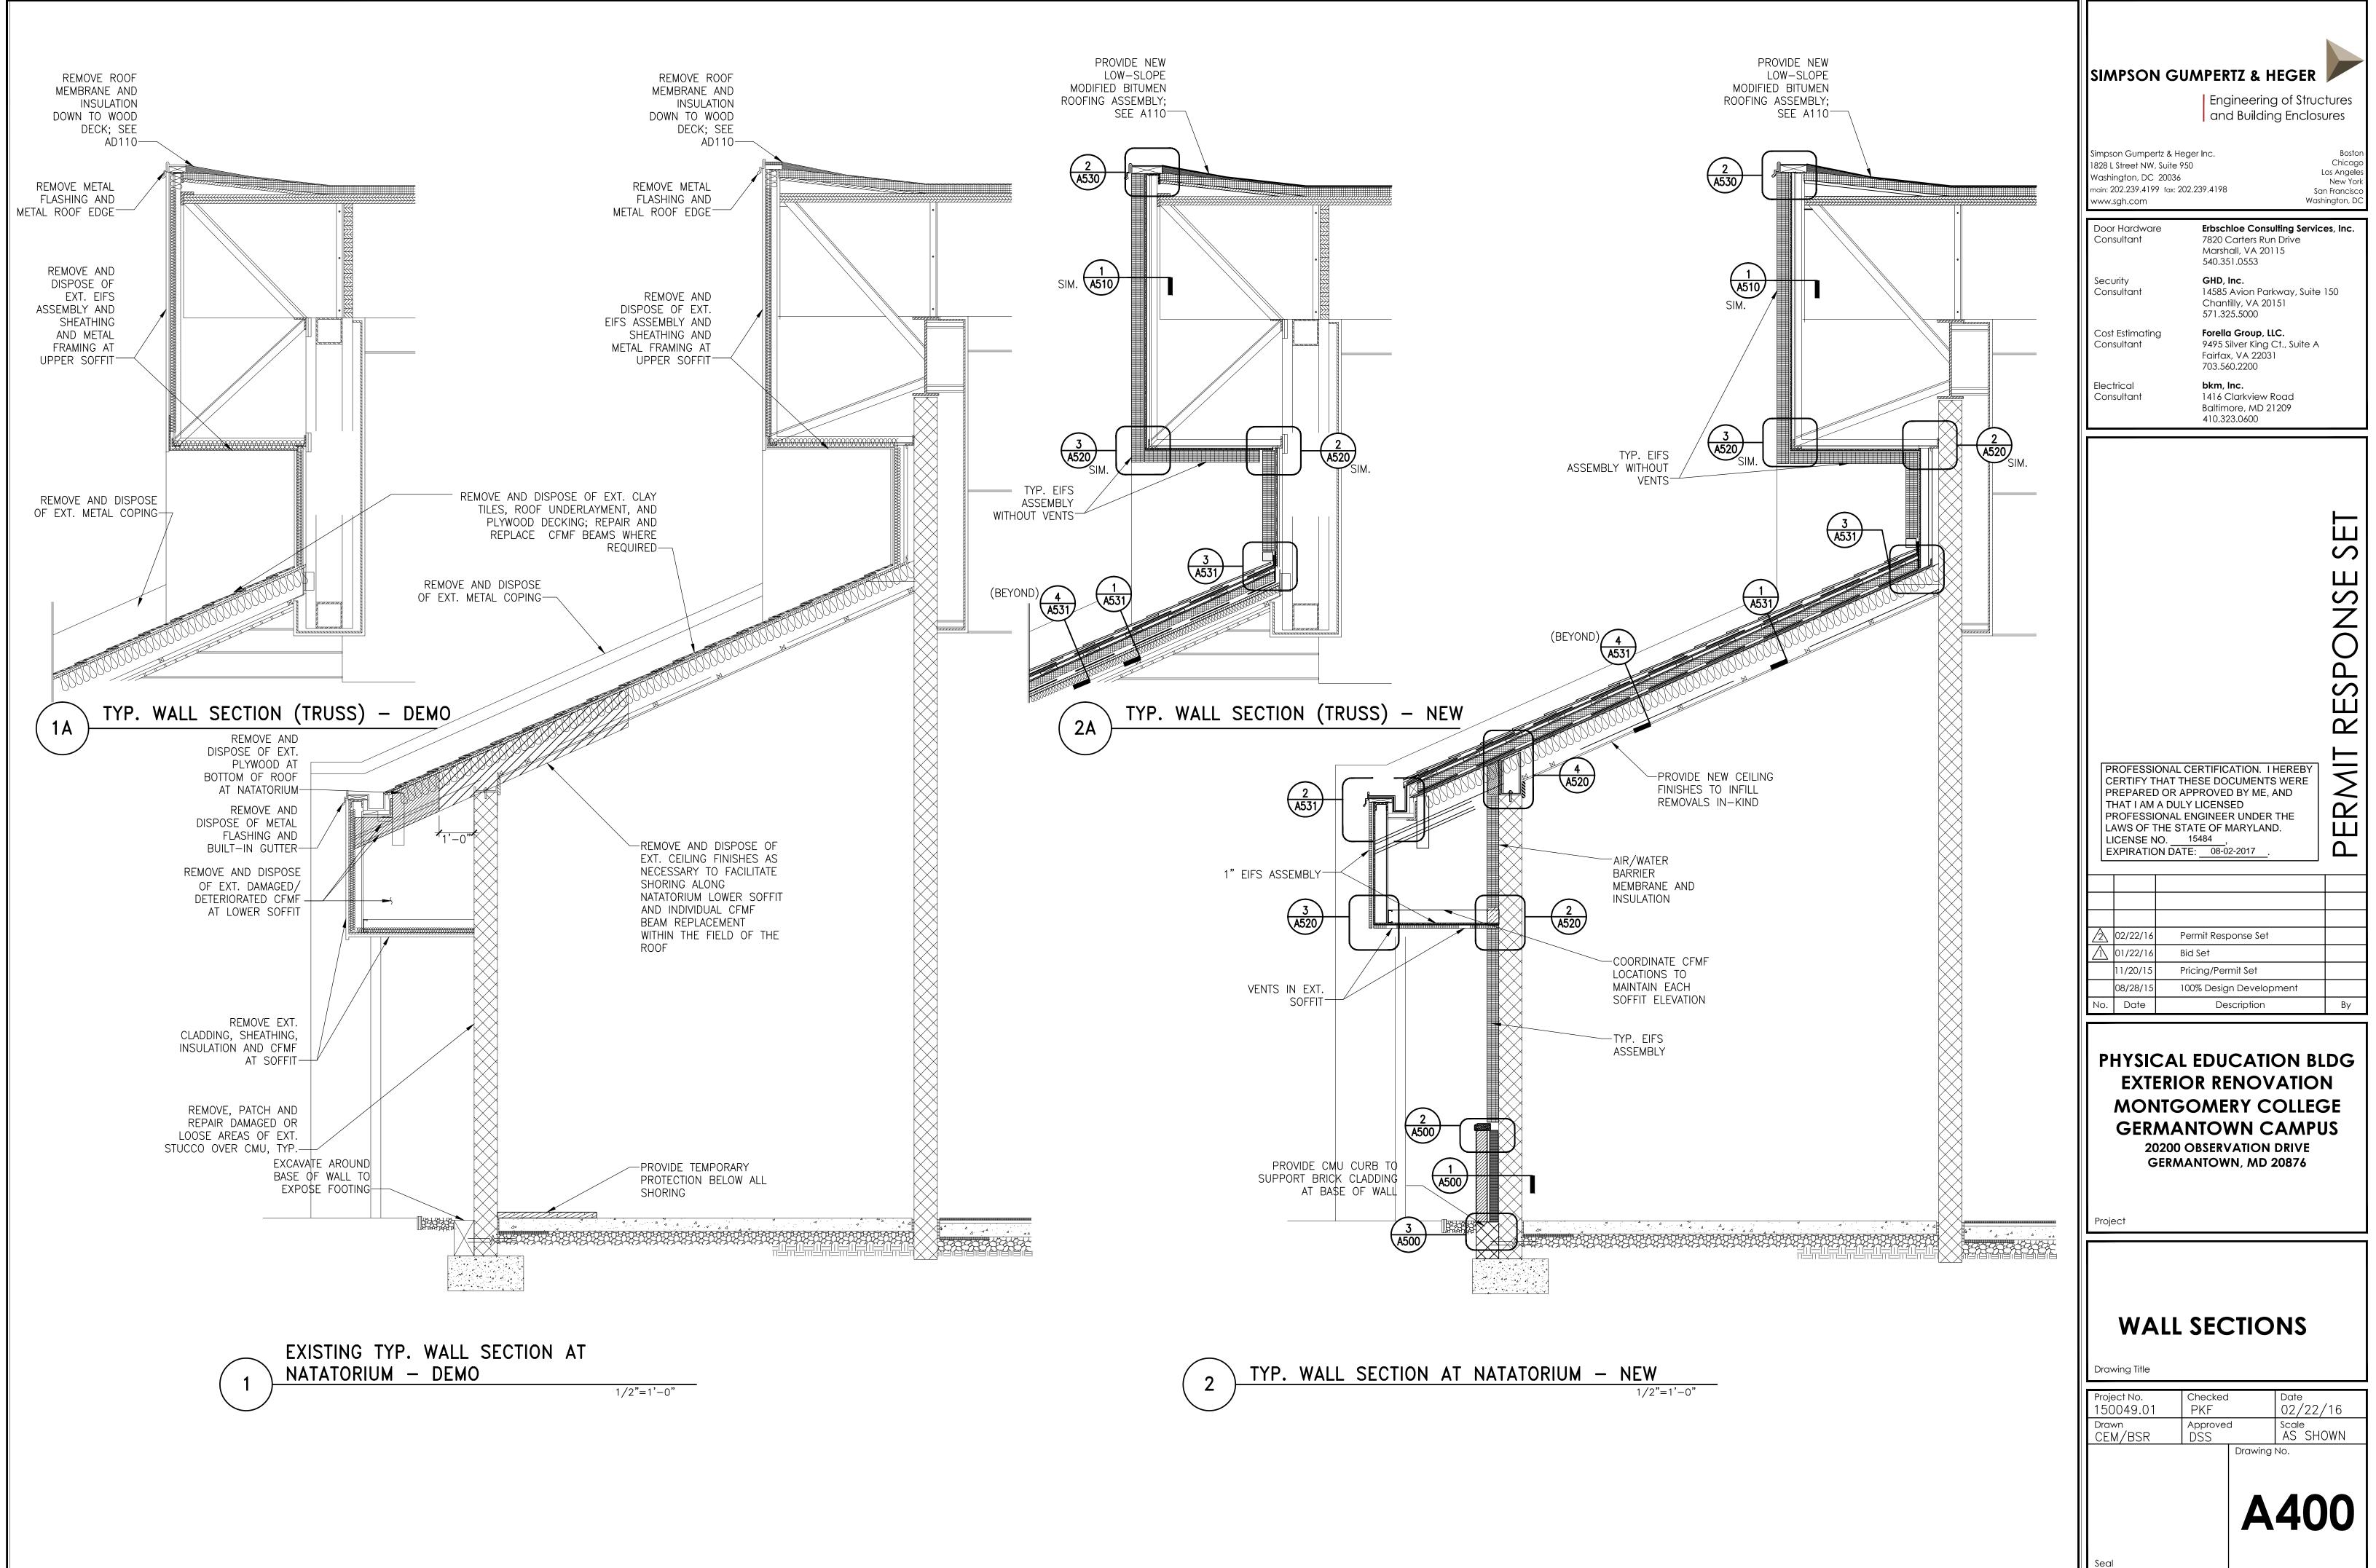

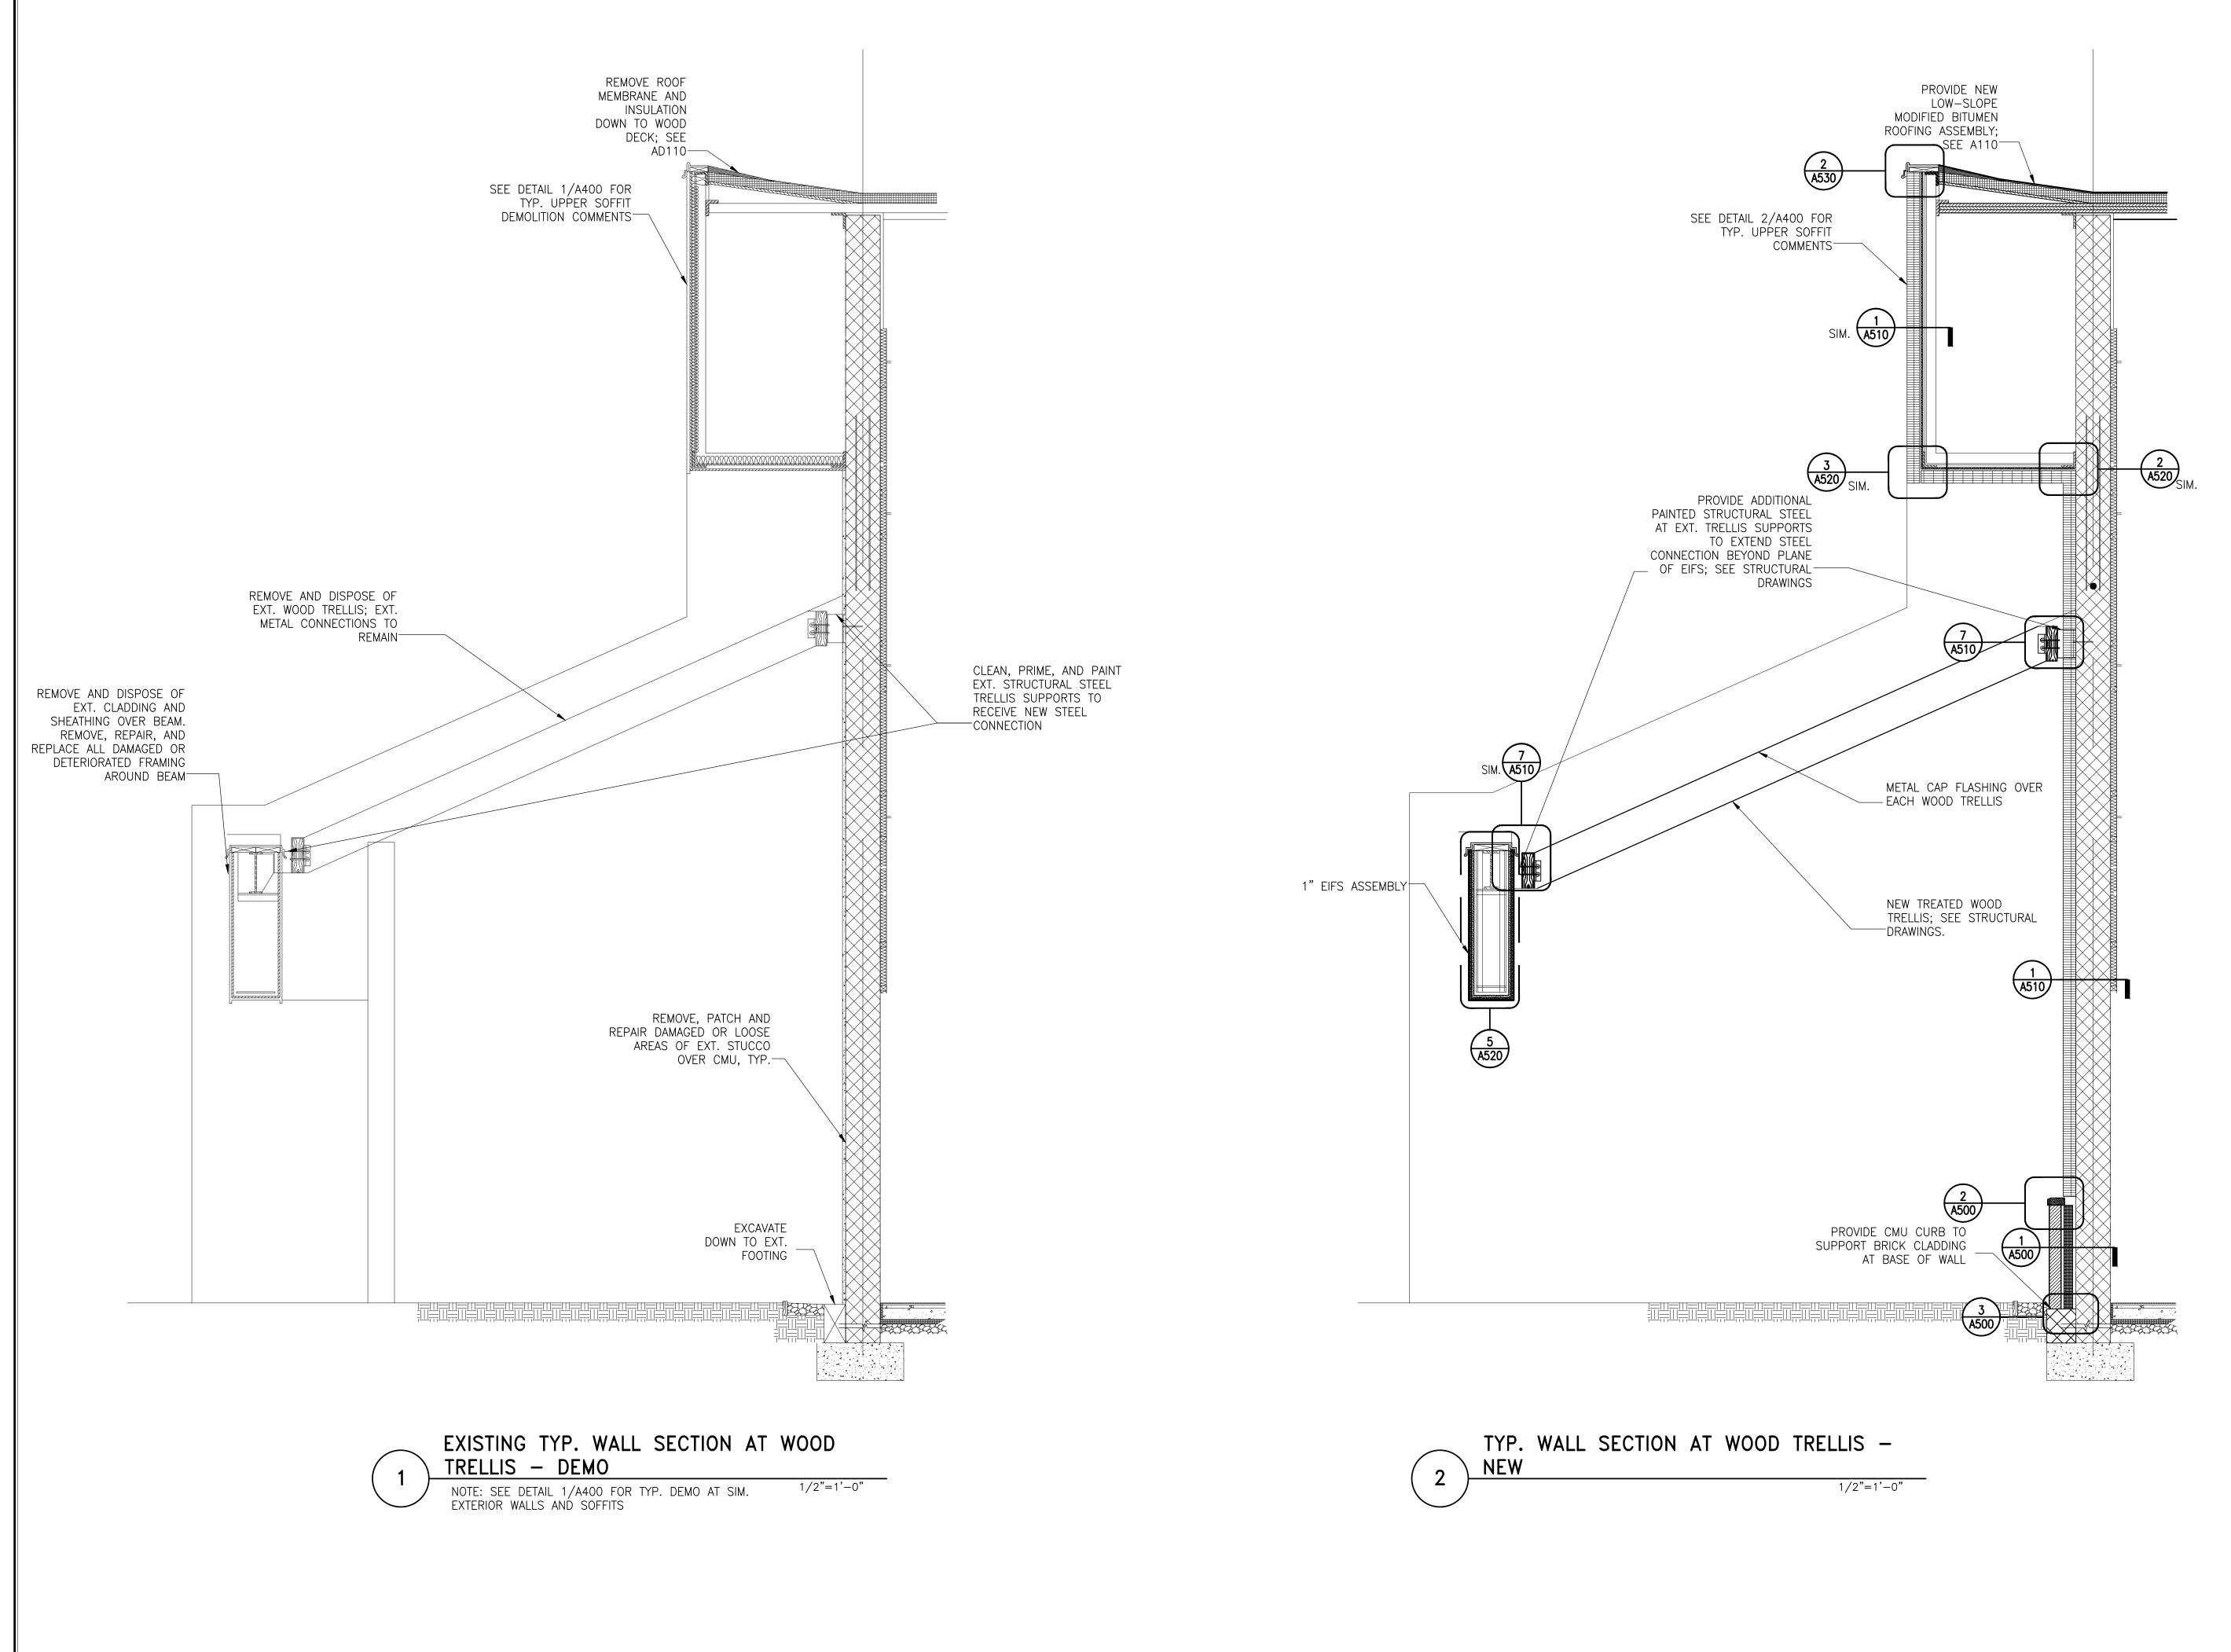
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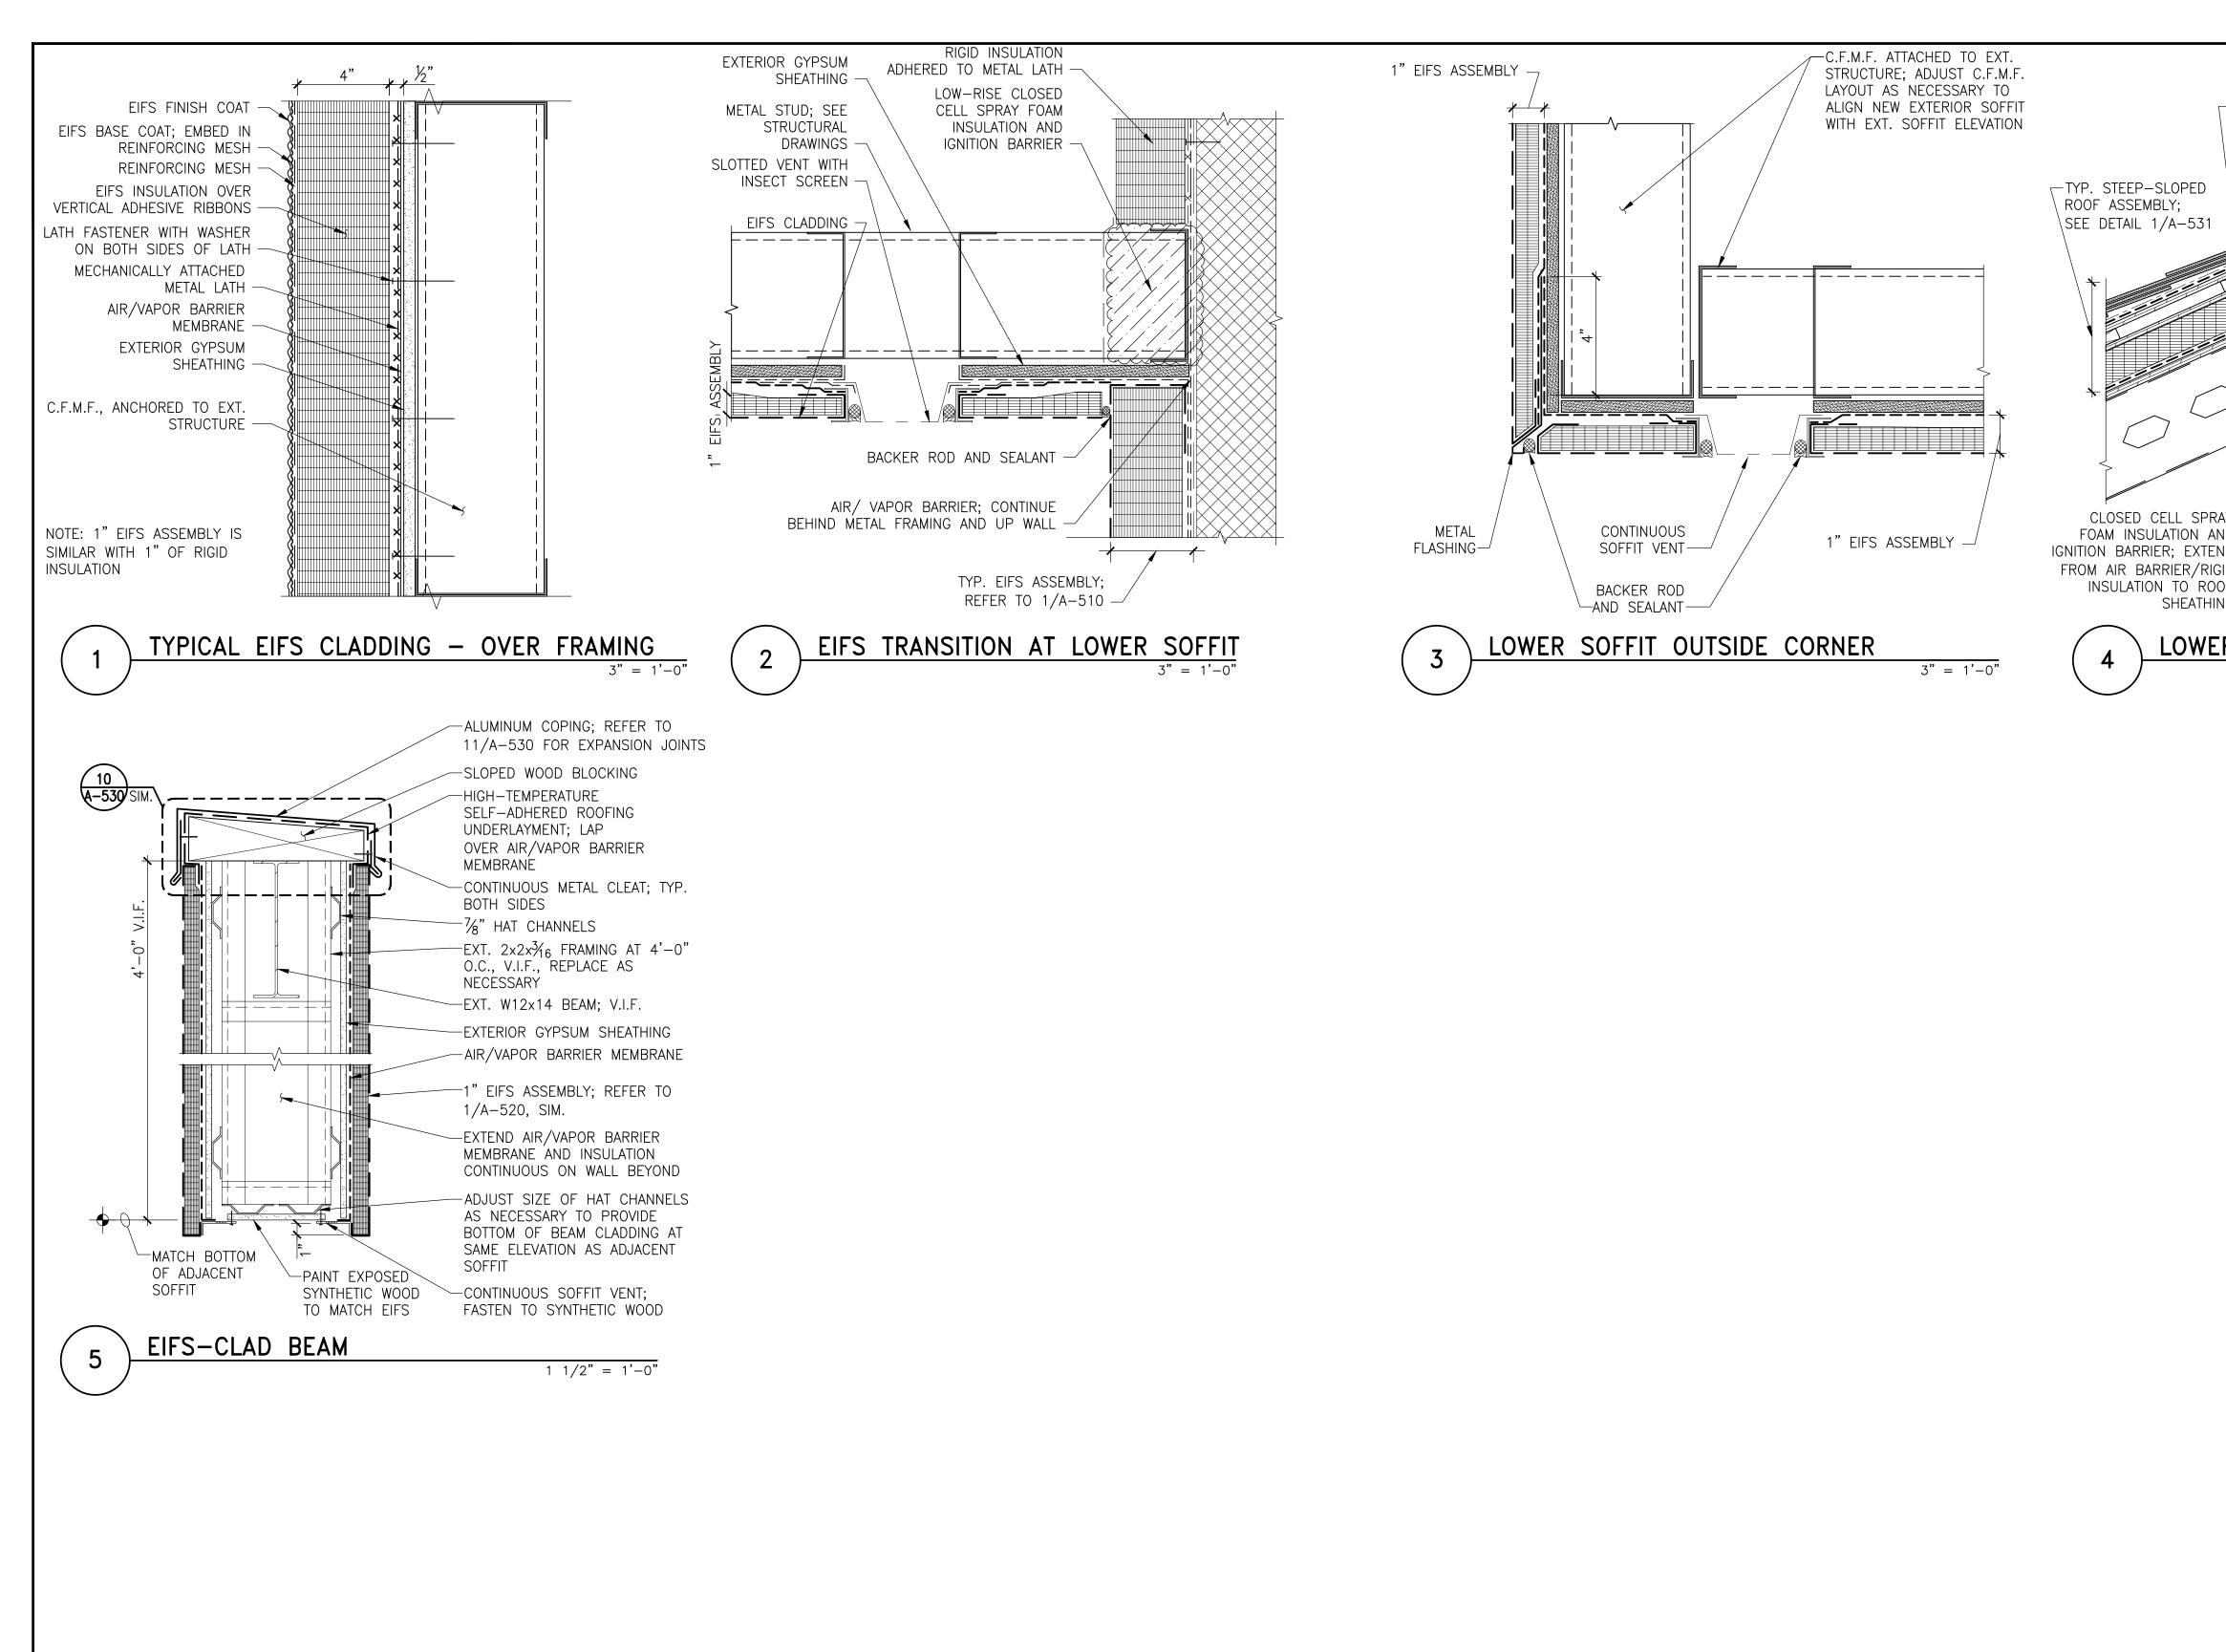


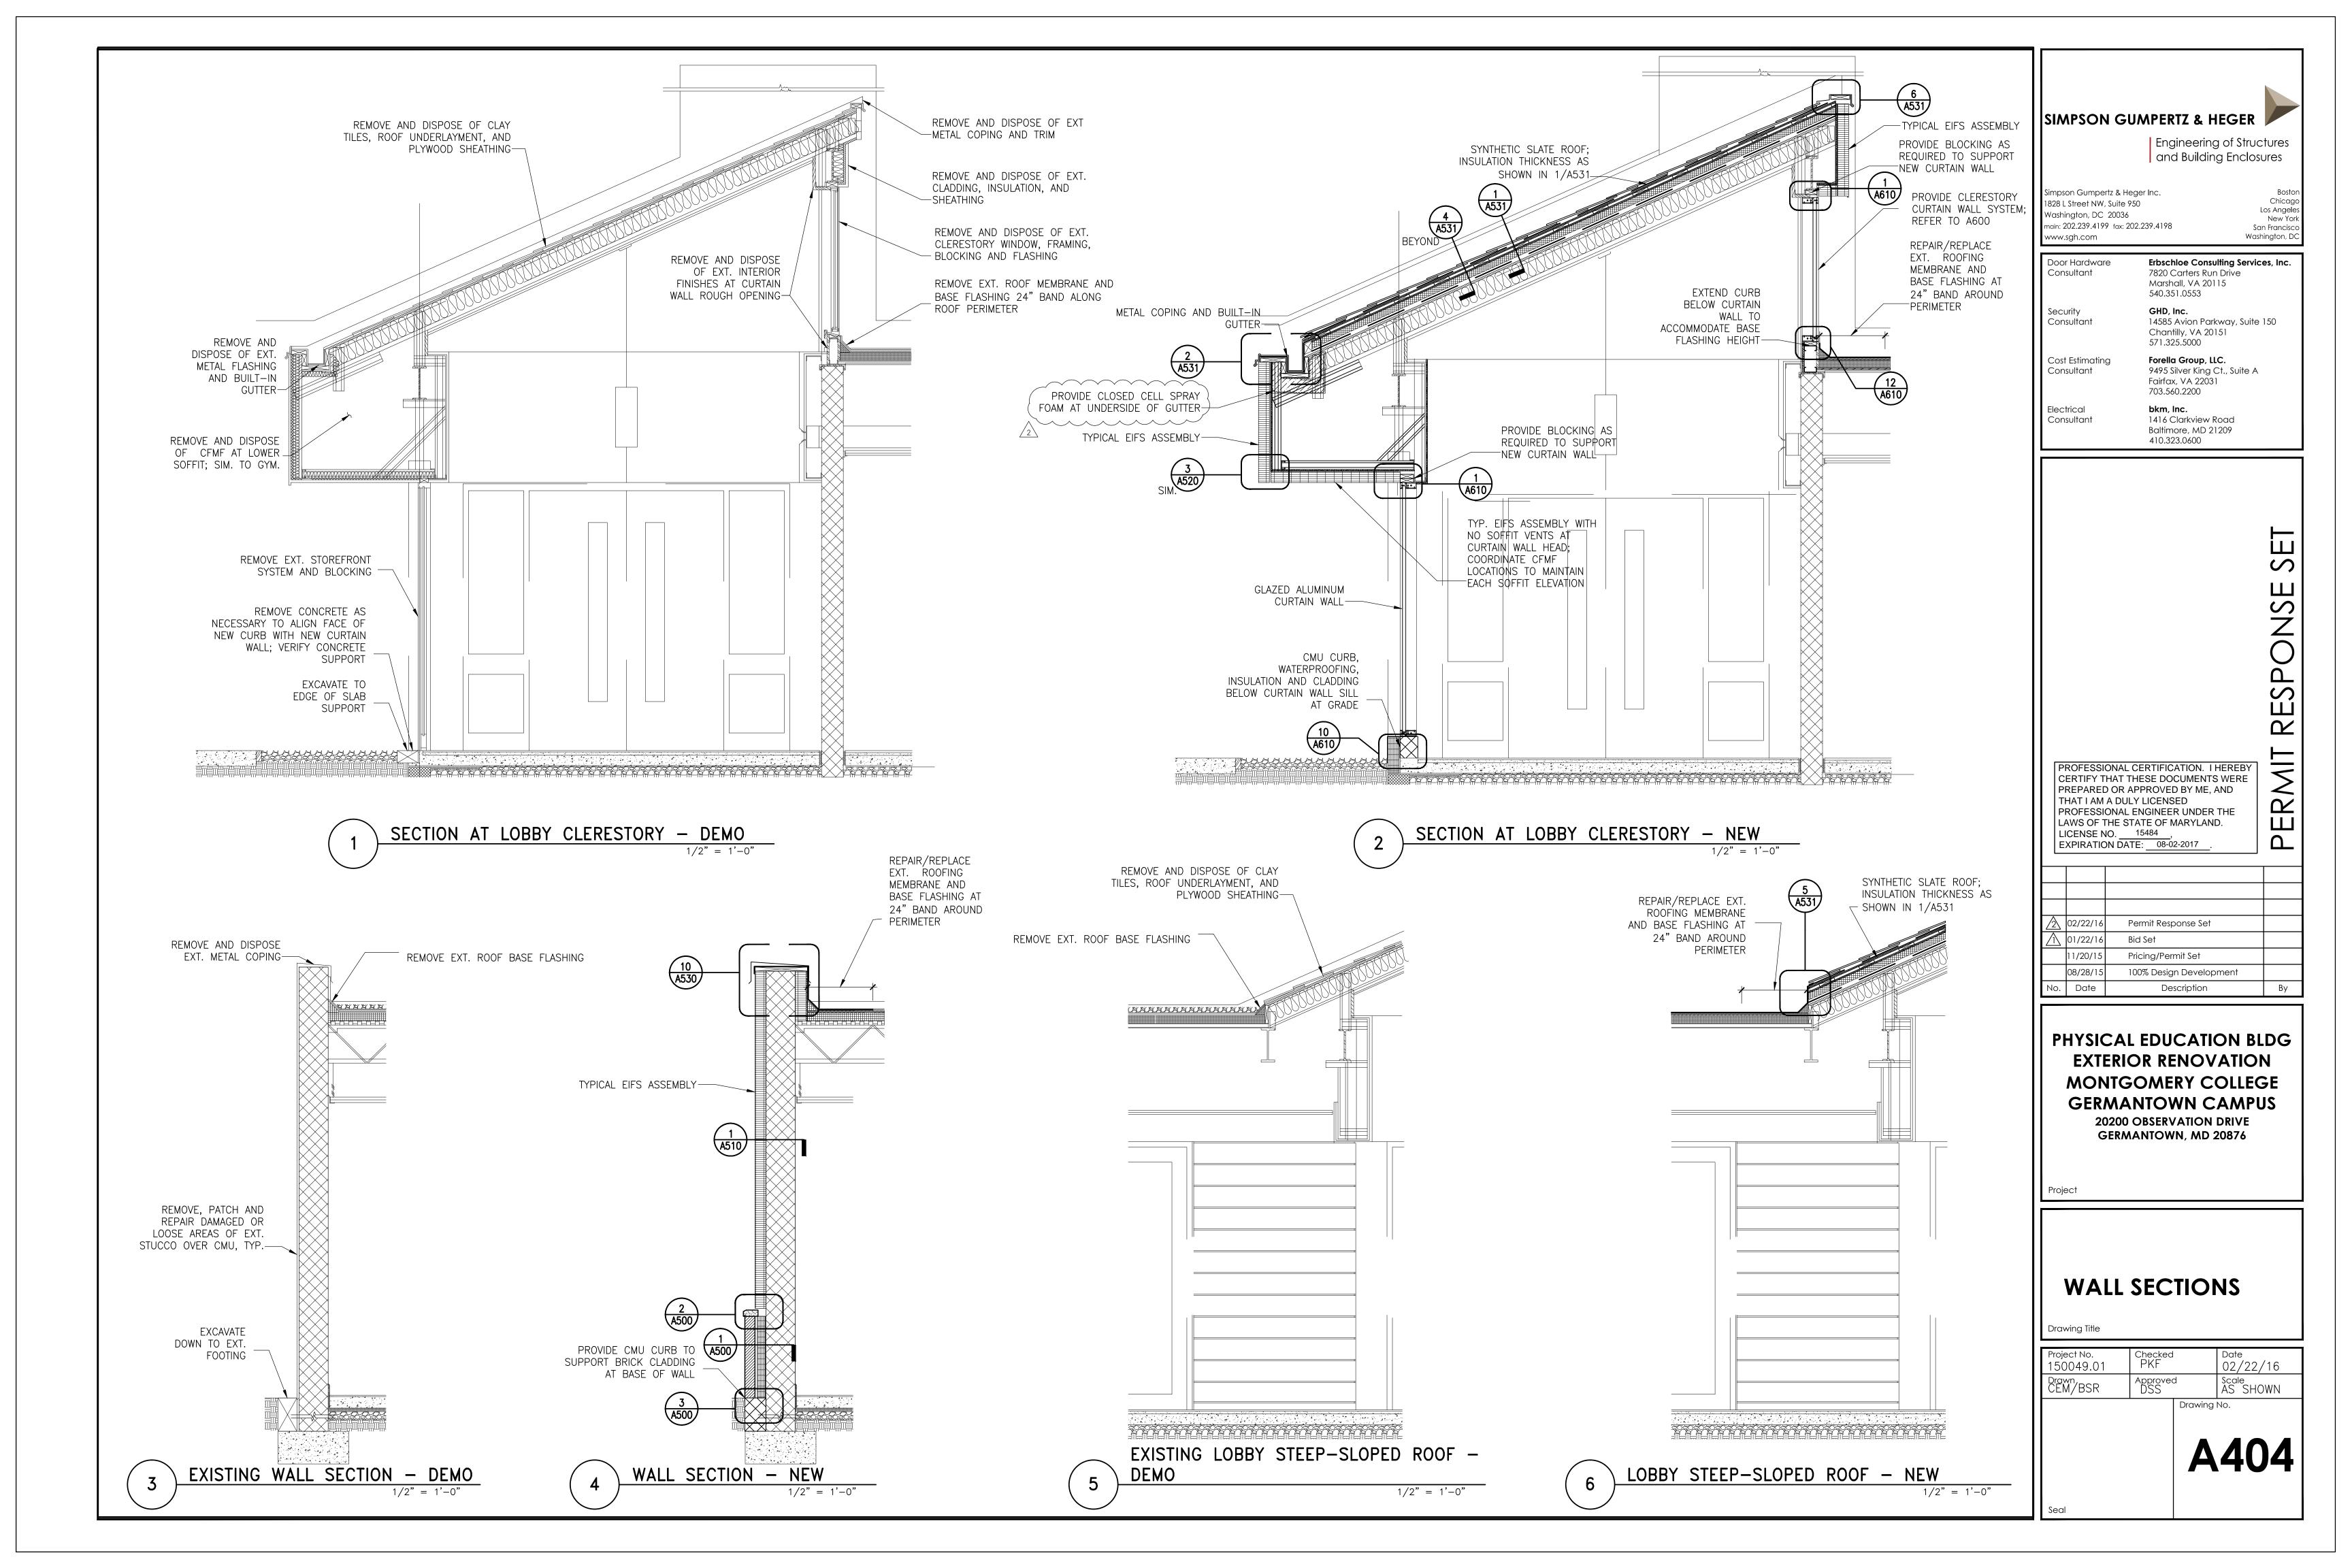

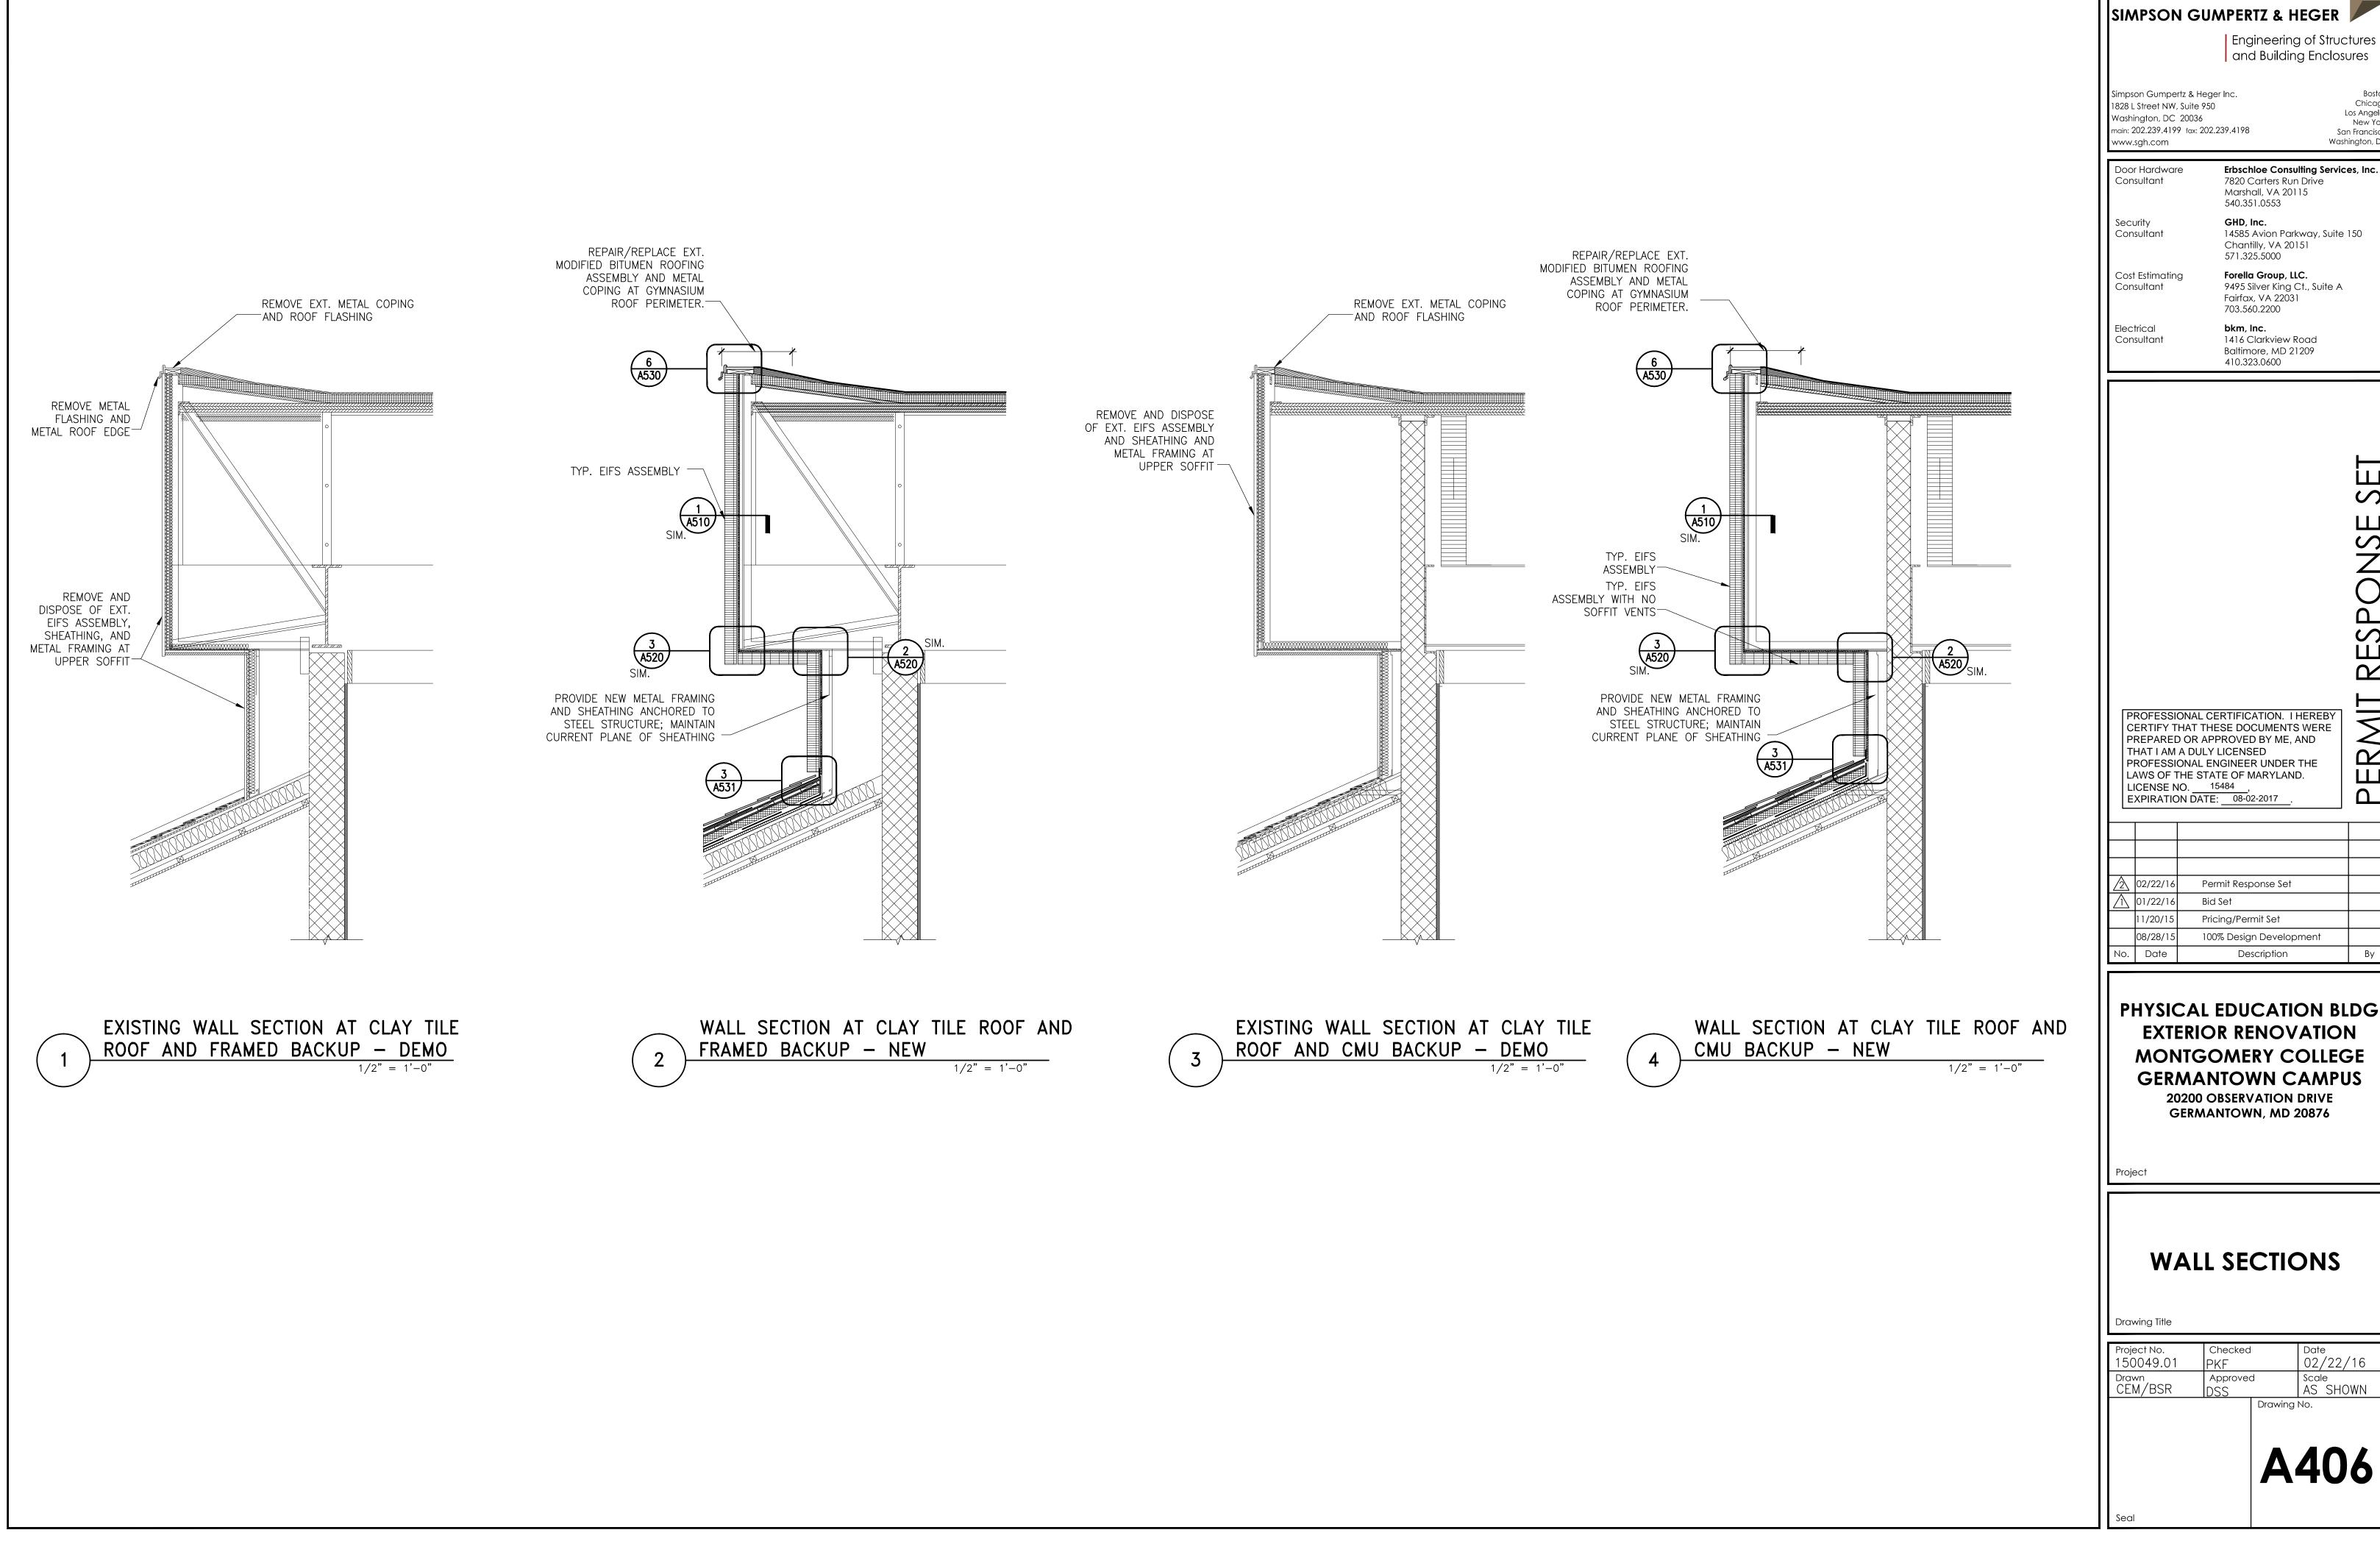
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Security Consultant	GHD, 14585 Chan		way, Suite 151	150	
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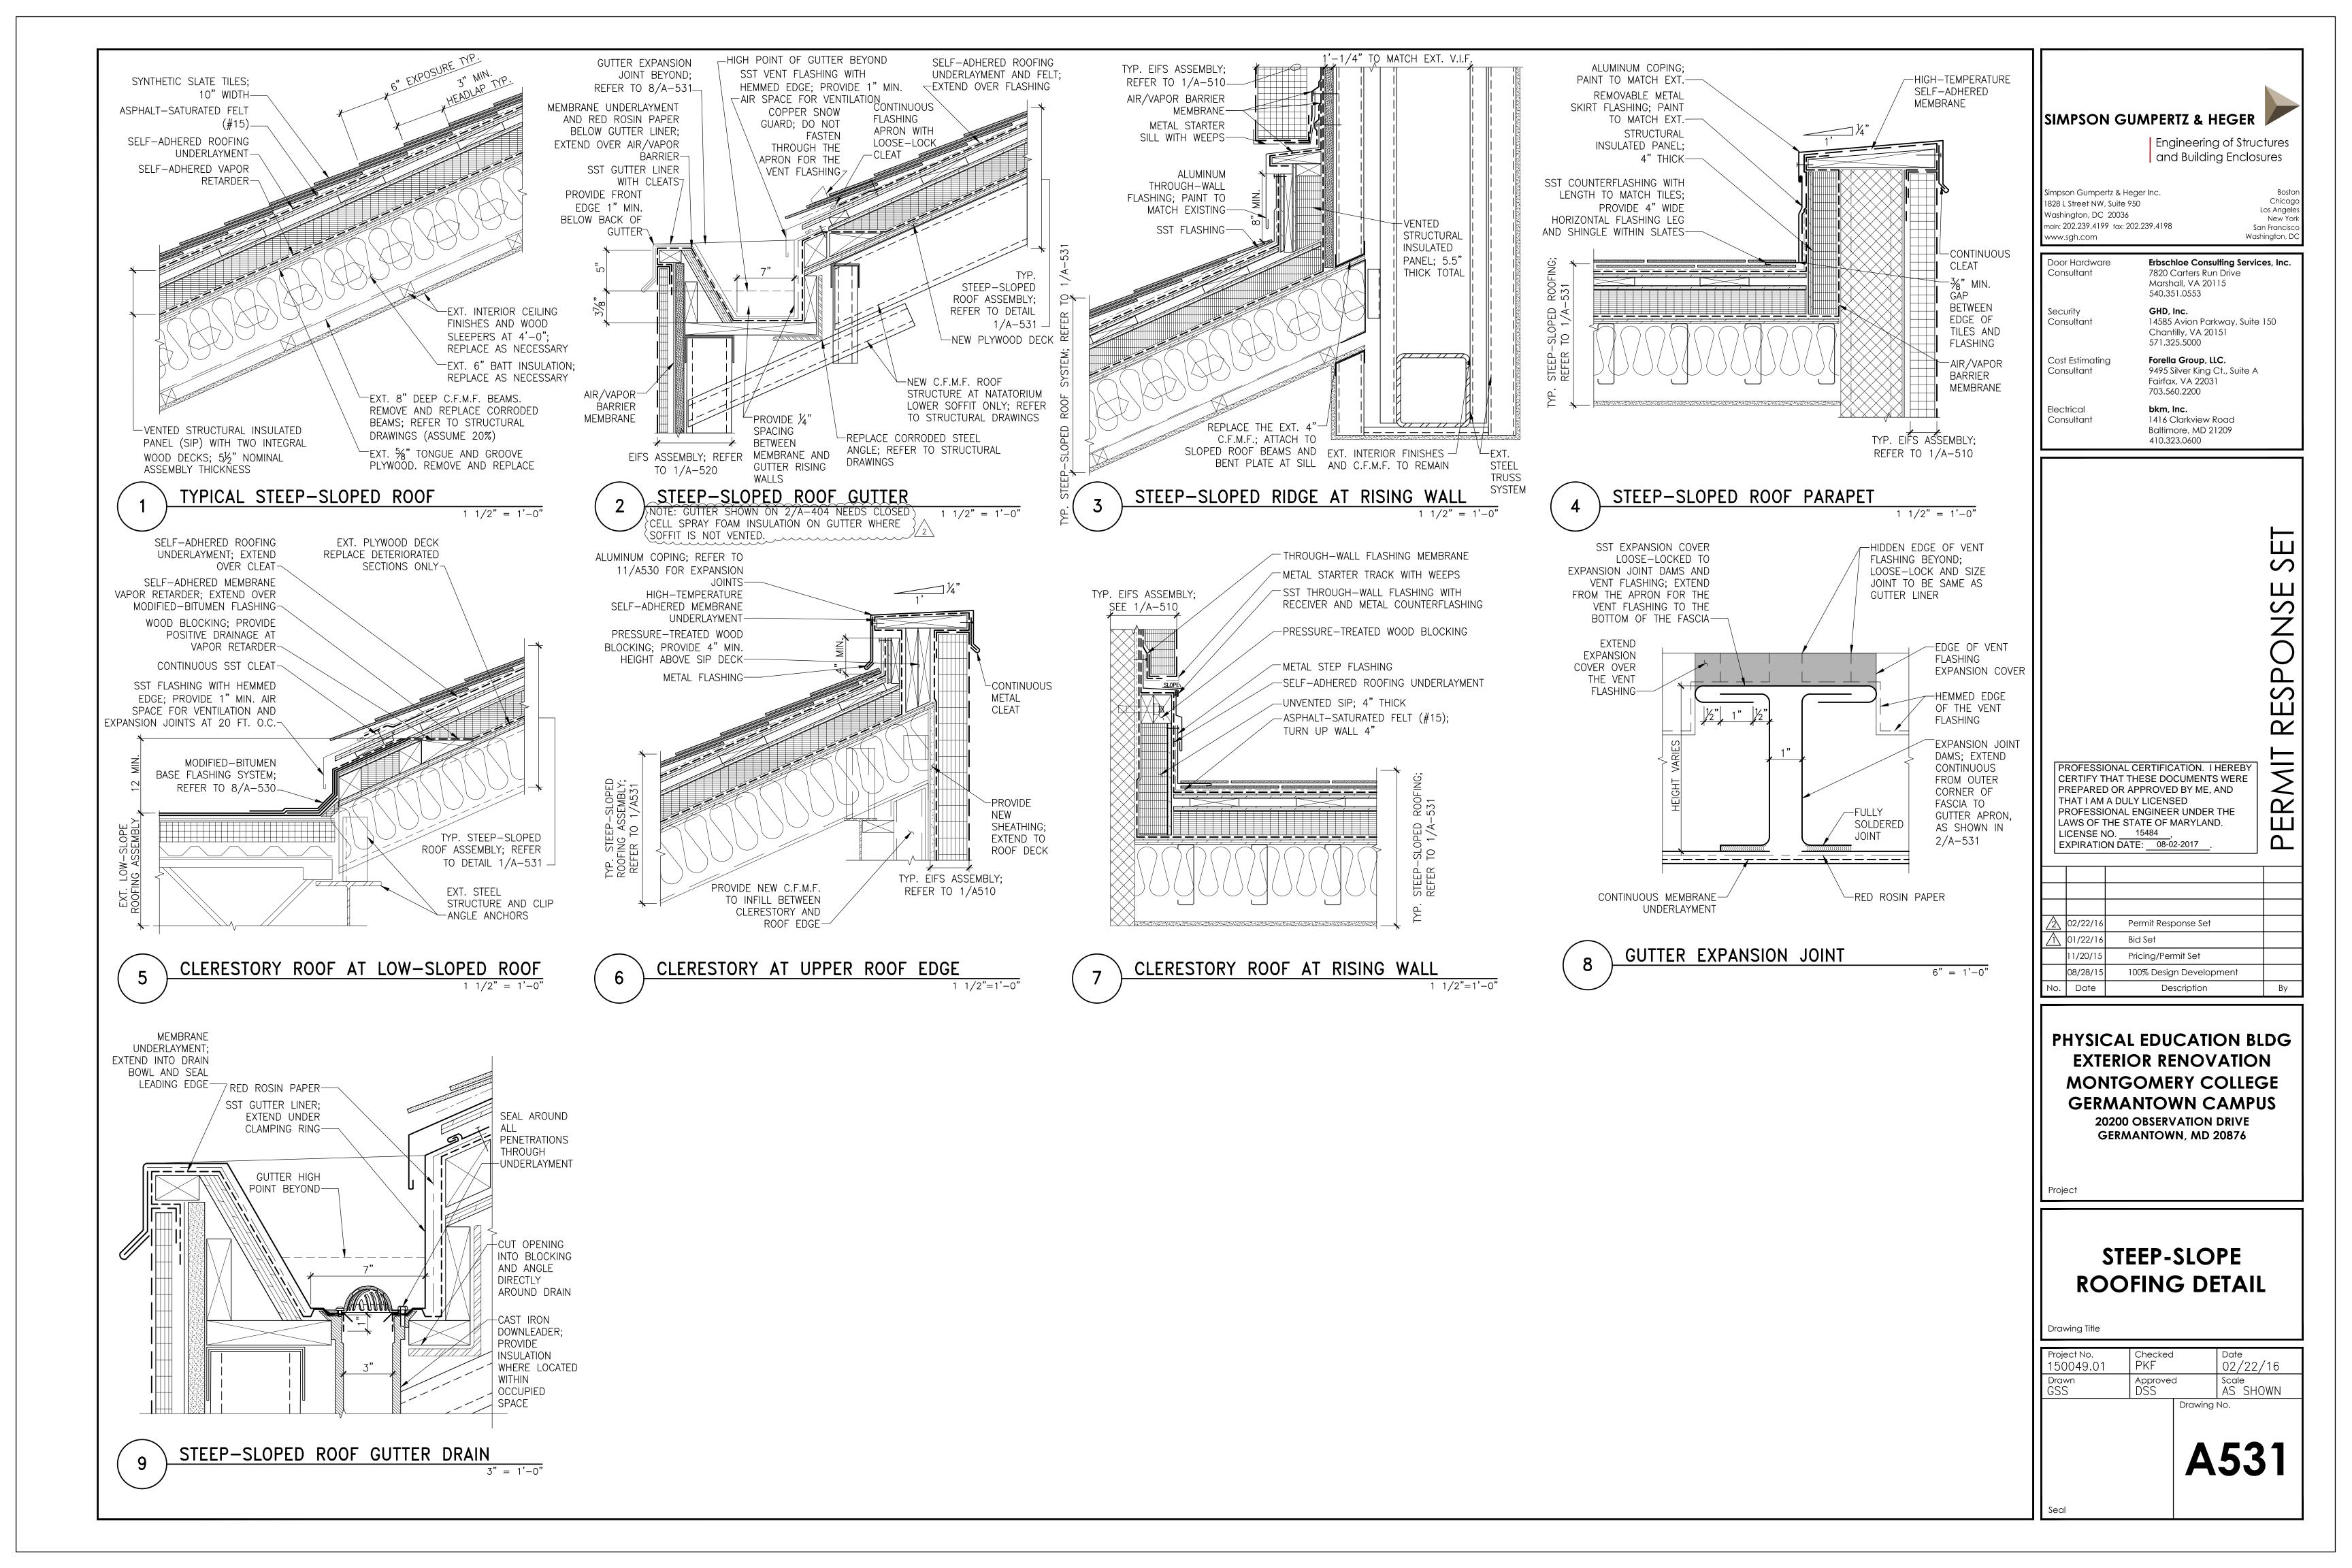



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NEW C.F.M.F. SPLICED ONTO EXT. C.F.M.F SEE STRUCTURAL DRAWINGS ++++++++++++++++++++++++++++++++++++	SIMPSON GUMPERTZ & HEGER Engineering of Structures and Building Enclosures Simpson Gumpertz & Heger Inc. Boston 1828 L Street NV, Suite 950 Washington, DC 20036 Main: 202.239.4199 fax: 202.239.4198 Www.sgh.com Marshall, VA 20115 S40.351.0553 Security CHD, Inc. Consultant 14585 Avion Parkway, Suite 150 Chantilly, VA 20115 S40.351.0553 Security CHD, Inc. Consultant 14585 Avion Parkway, Suite 150 Chantilly, VA 20151 S71.325.5000 Cost Estimating Forela Group, LLC. Consultant 9495 Silver King Ct., Suite A Fairfax, VA 22031 703.560.2200 Electrical bkm, Inc. Consultant 1416 Clarkview Road Baltimore, MD 21209 410.323.0600
1 1/2" = 1'-0"	PROFESSIONAL CERTIFICATION. I HEREBY CERTIFY THAT THESE DOCUMENTS WERE PROFESSIONAL CERTIFICATION. I HEREBY CERTIFY THAT THESE DOCUMENTS WERE PROFESSIONAL ENGINEER UNDER THE LAWS OF THE STATE OF MARYLAND. LICENSE NO15484
	PHYSICAL EDUCATION BLDG EXTERIOR RENOVATION MONTGOMERY COLLEGE GERMANTOWN CAMPUS Doubservation Drive GERMANTOWN, MD 20876ProjectSOFFIT DETAILSDraving TitleDate 02/22/16 Draving BSR/CEM DSSProject No. 150049.01Checked PKF 02/22/16 DSSDraving TitleDate 02/22/16 AS SHOWN Draving No.Draving TitleDate 02/22/16 DSSDraving TitleDate 02/22/16 DSSDraving No.Date DSSDraving No.Date DSSDraving No.Date DSSDraving No.Date DSSDraving No.Date DSSDraving No.Date DSSDraving No.Date DSSDraving No.Date DSSDraving No.Draving No.Draving No.Draving No.SealDate DSS

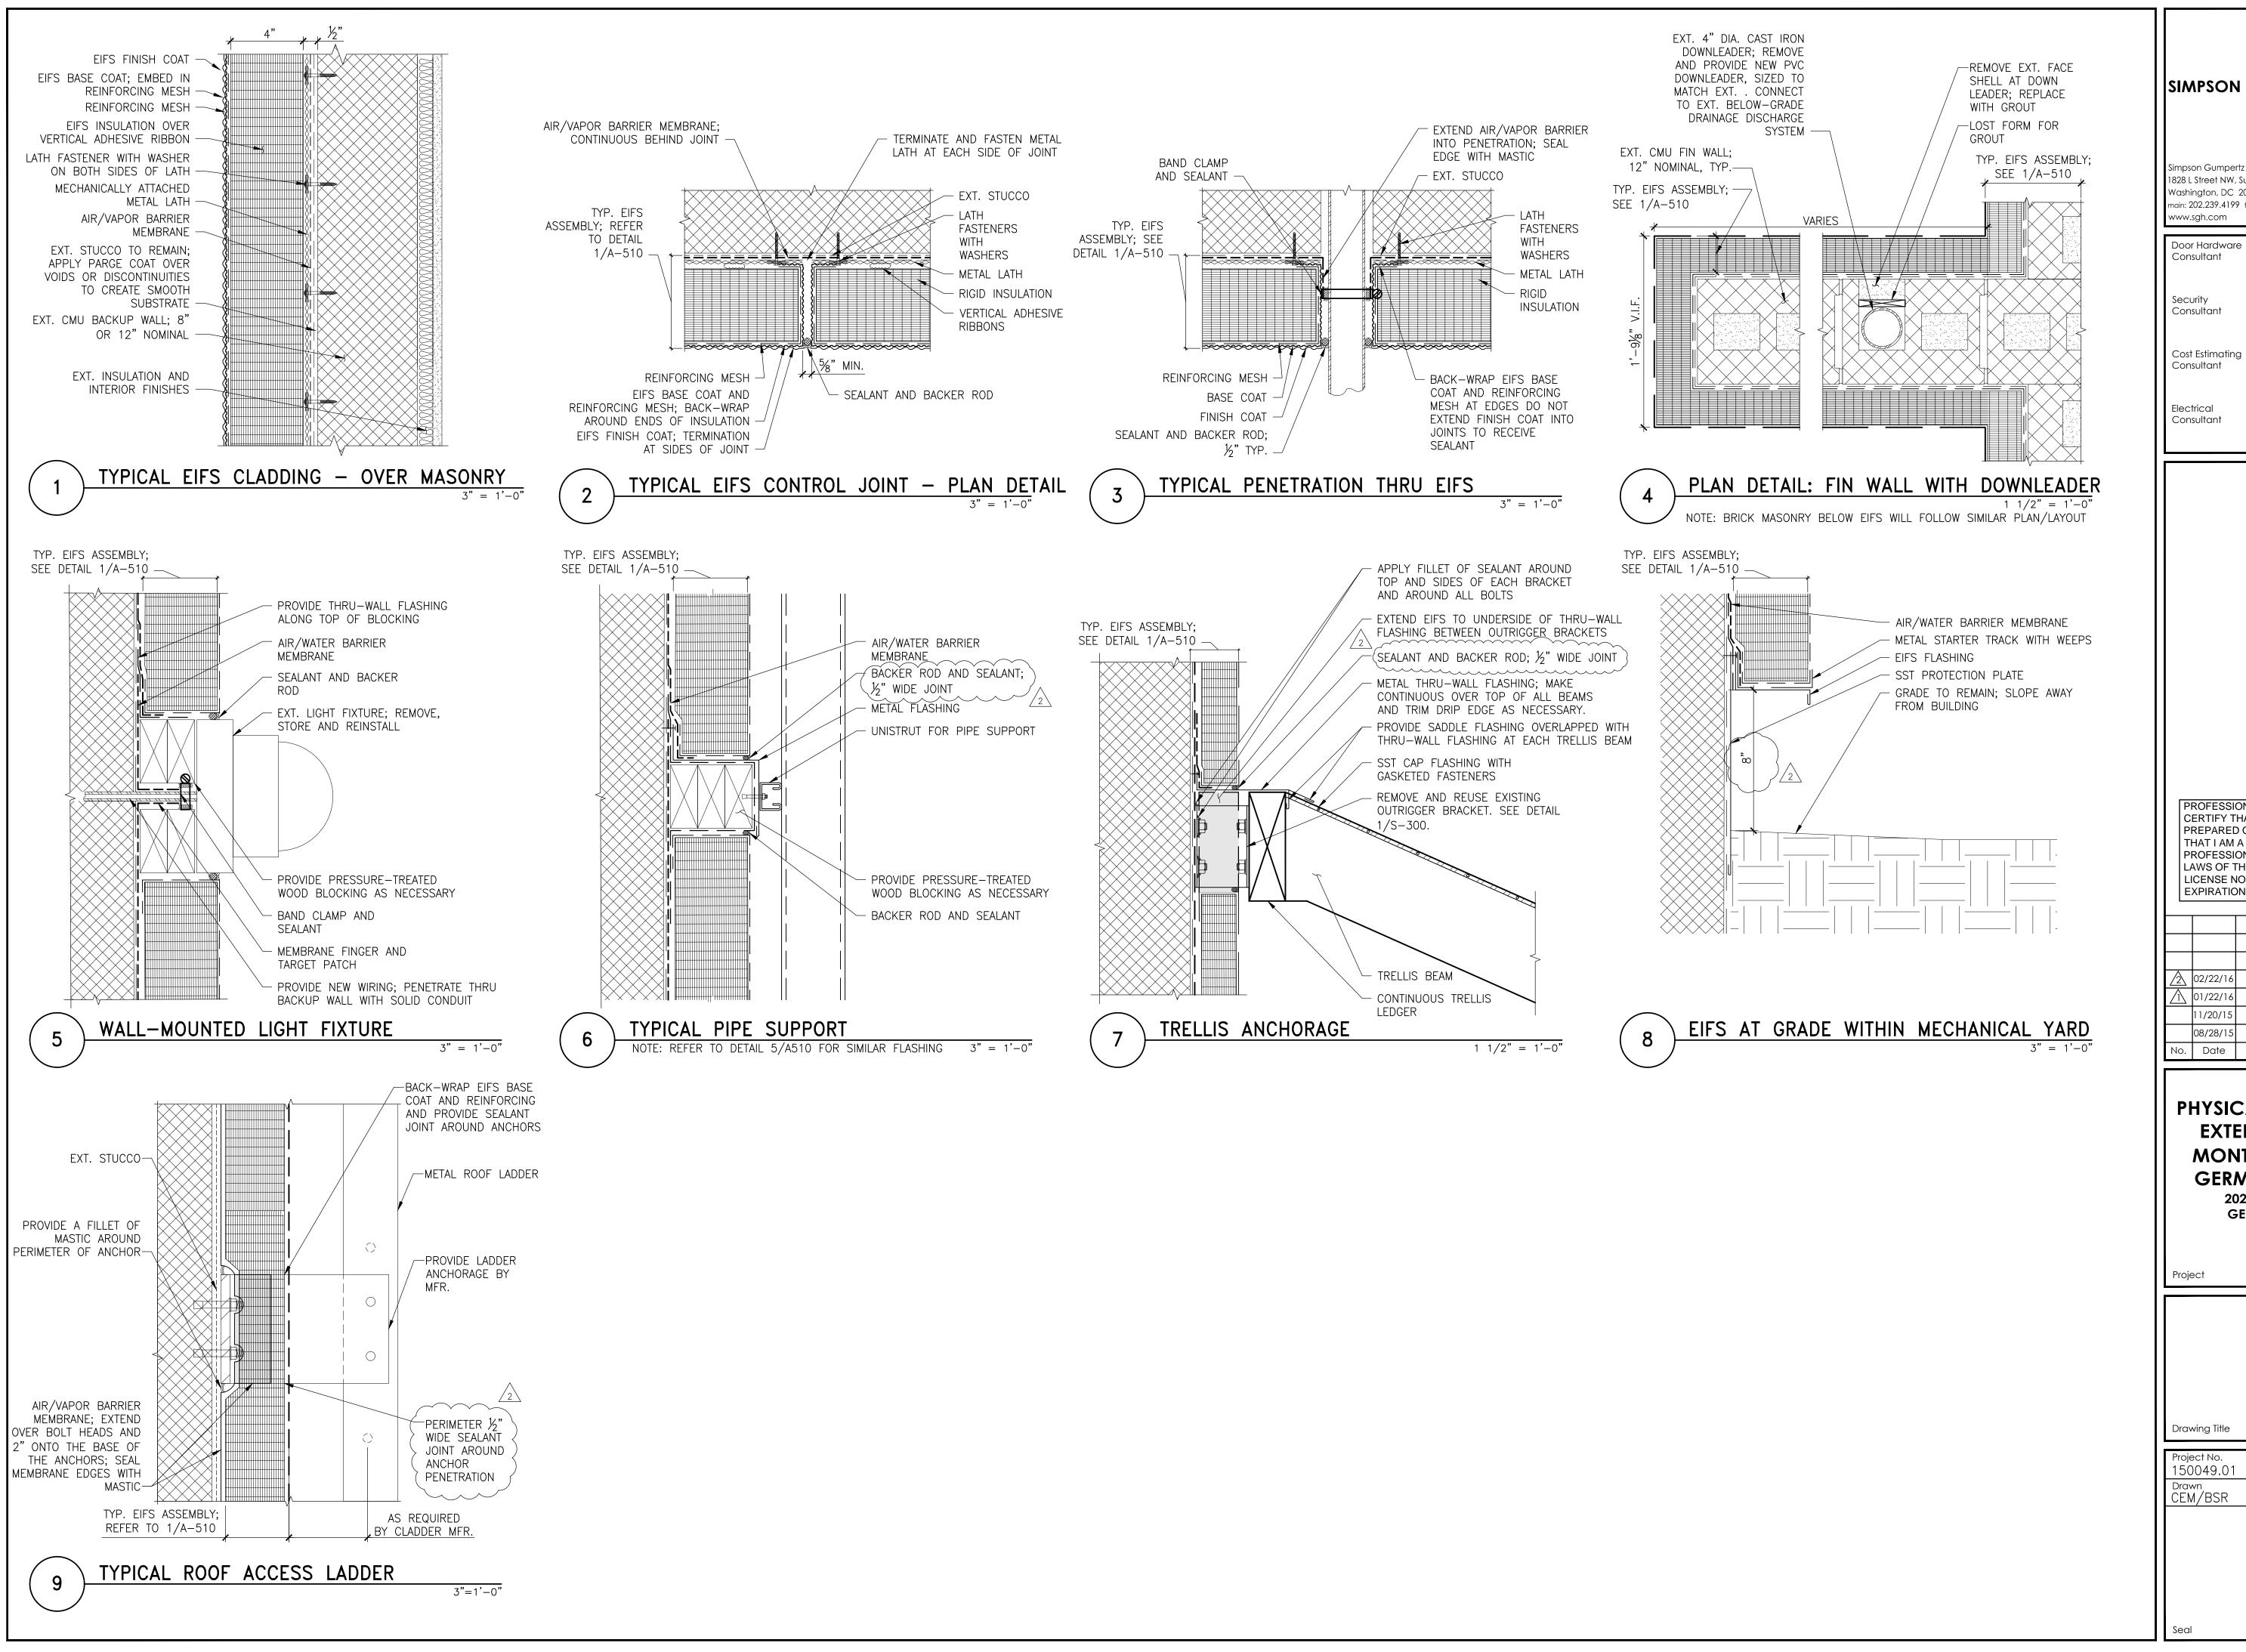




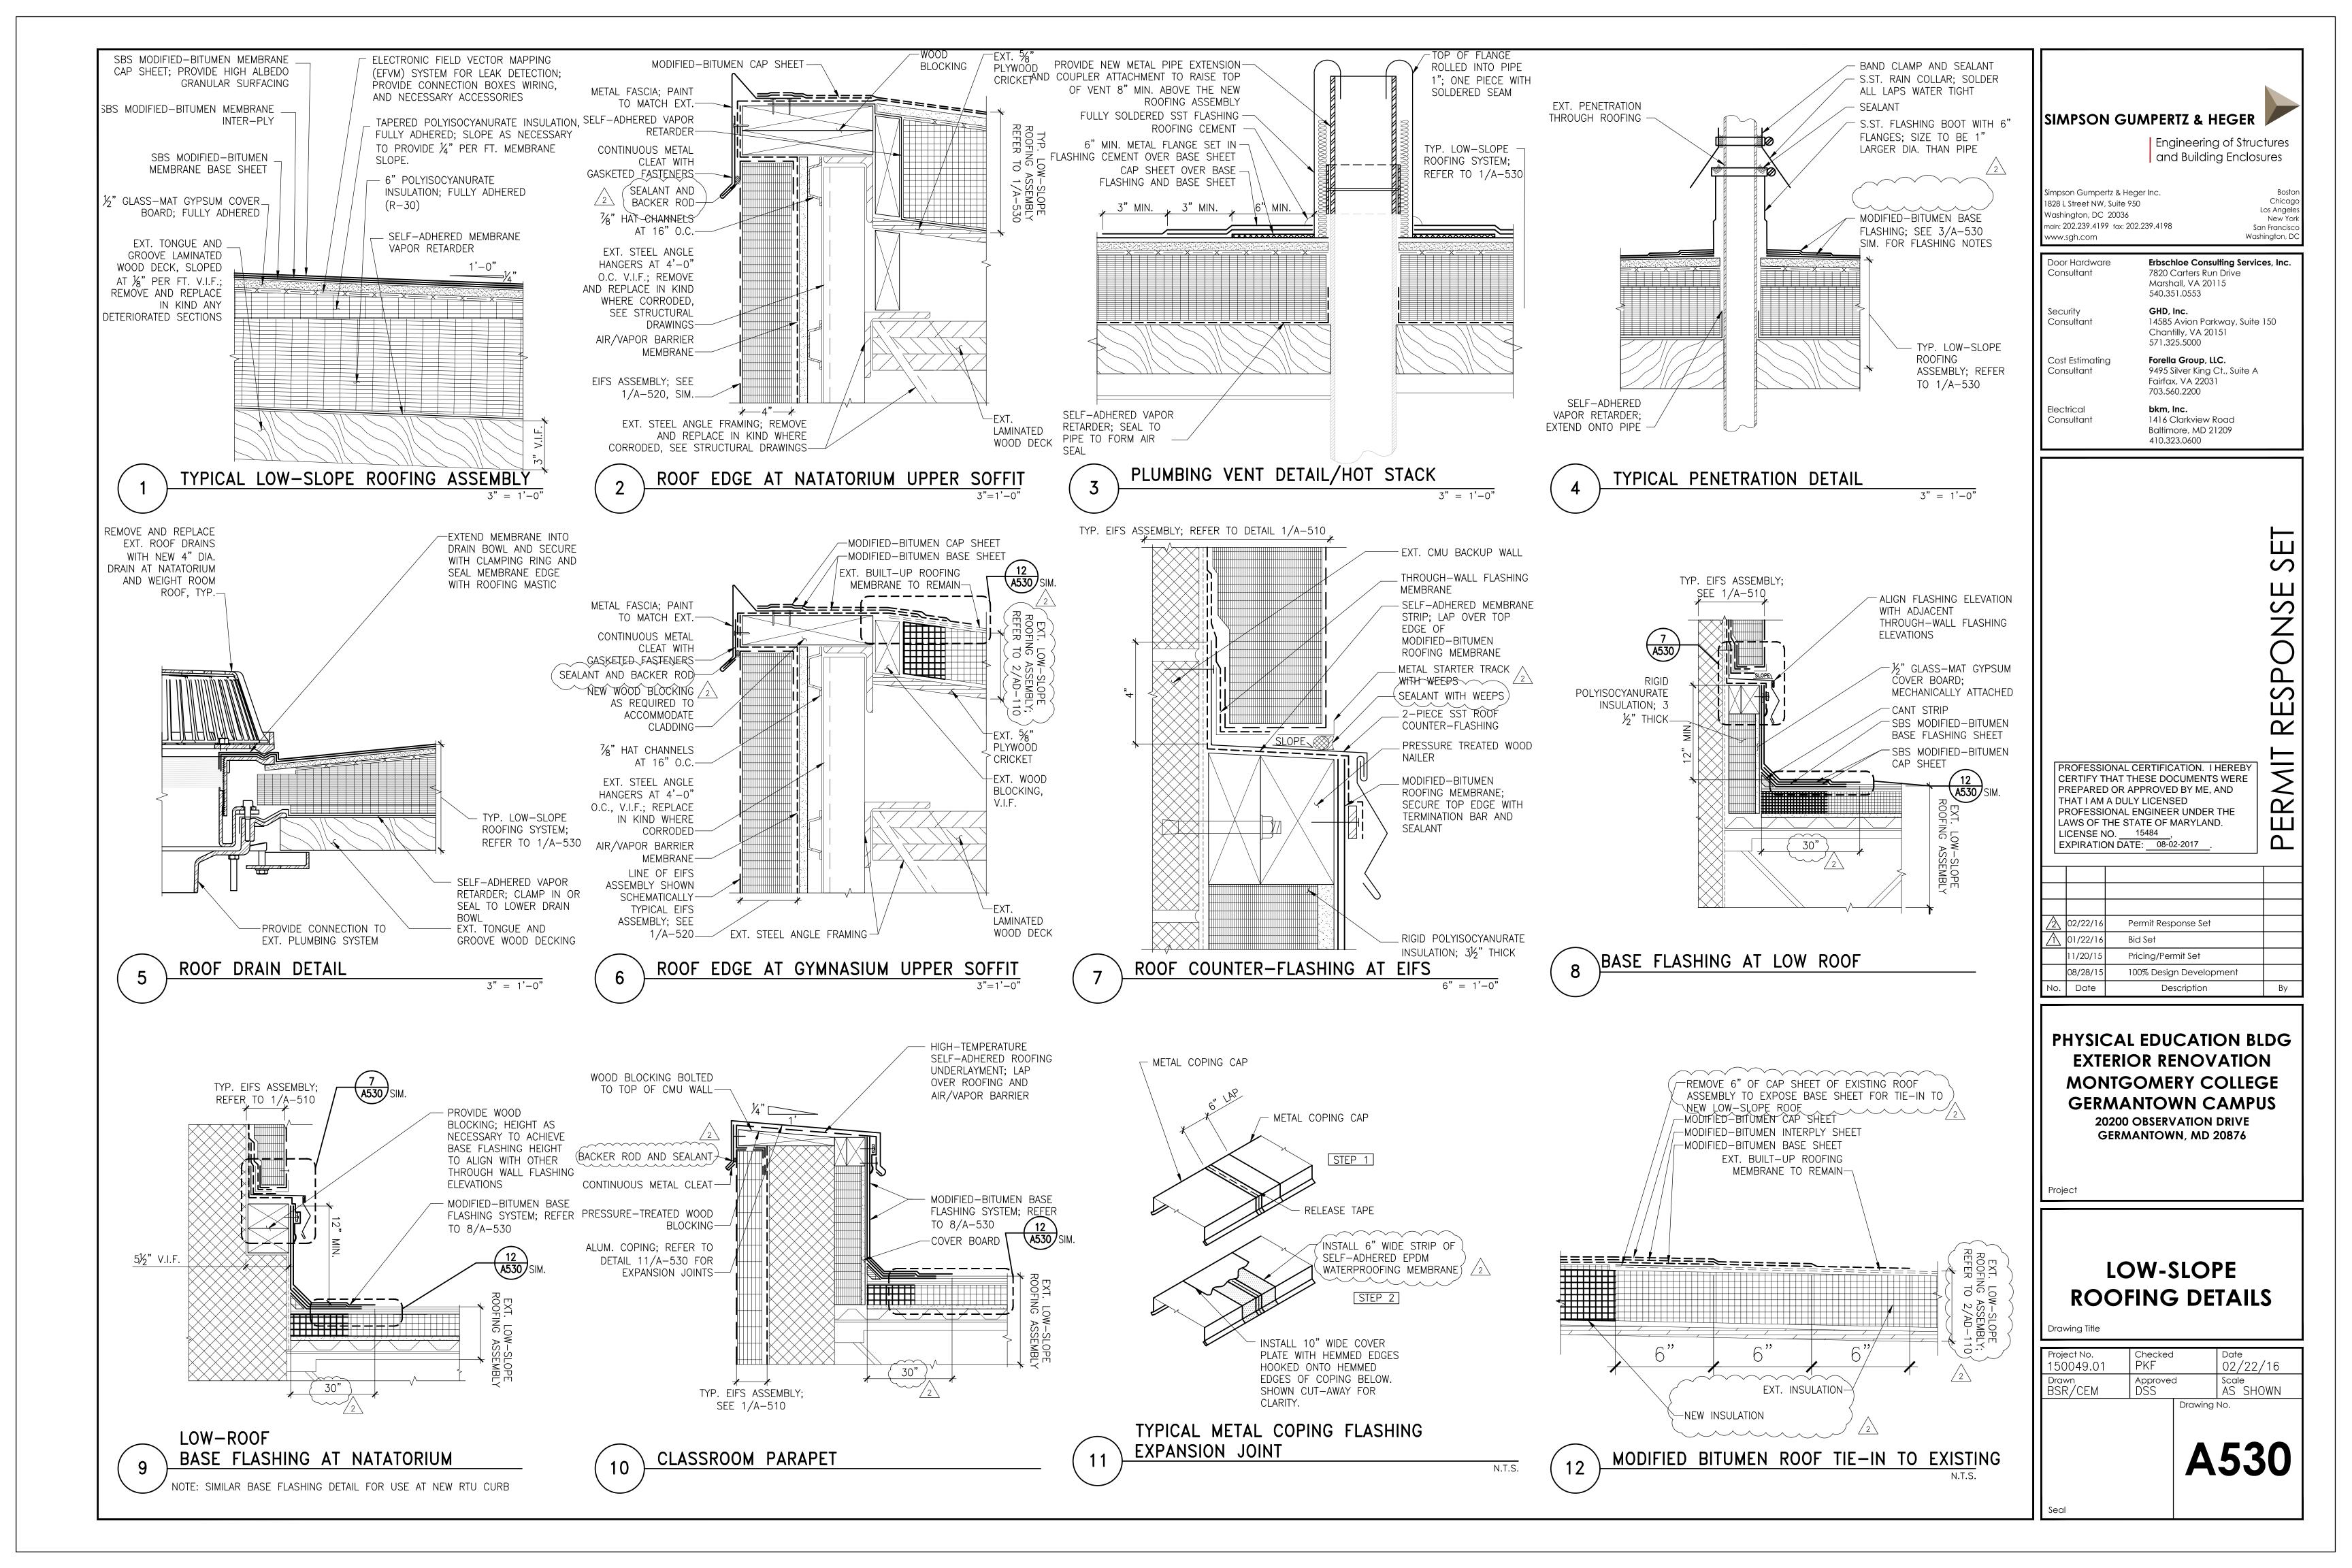


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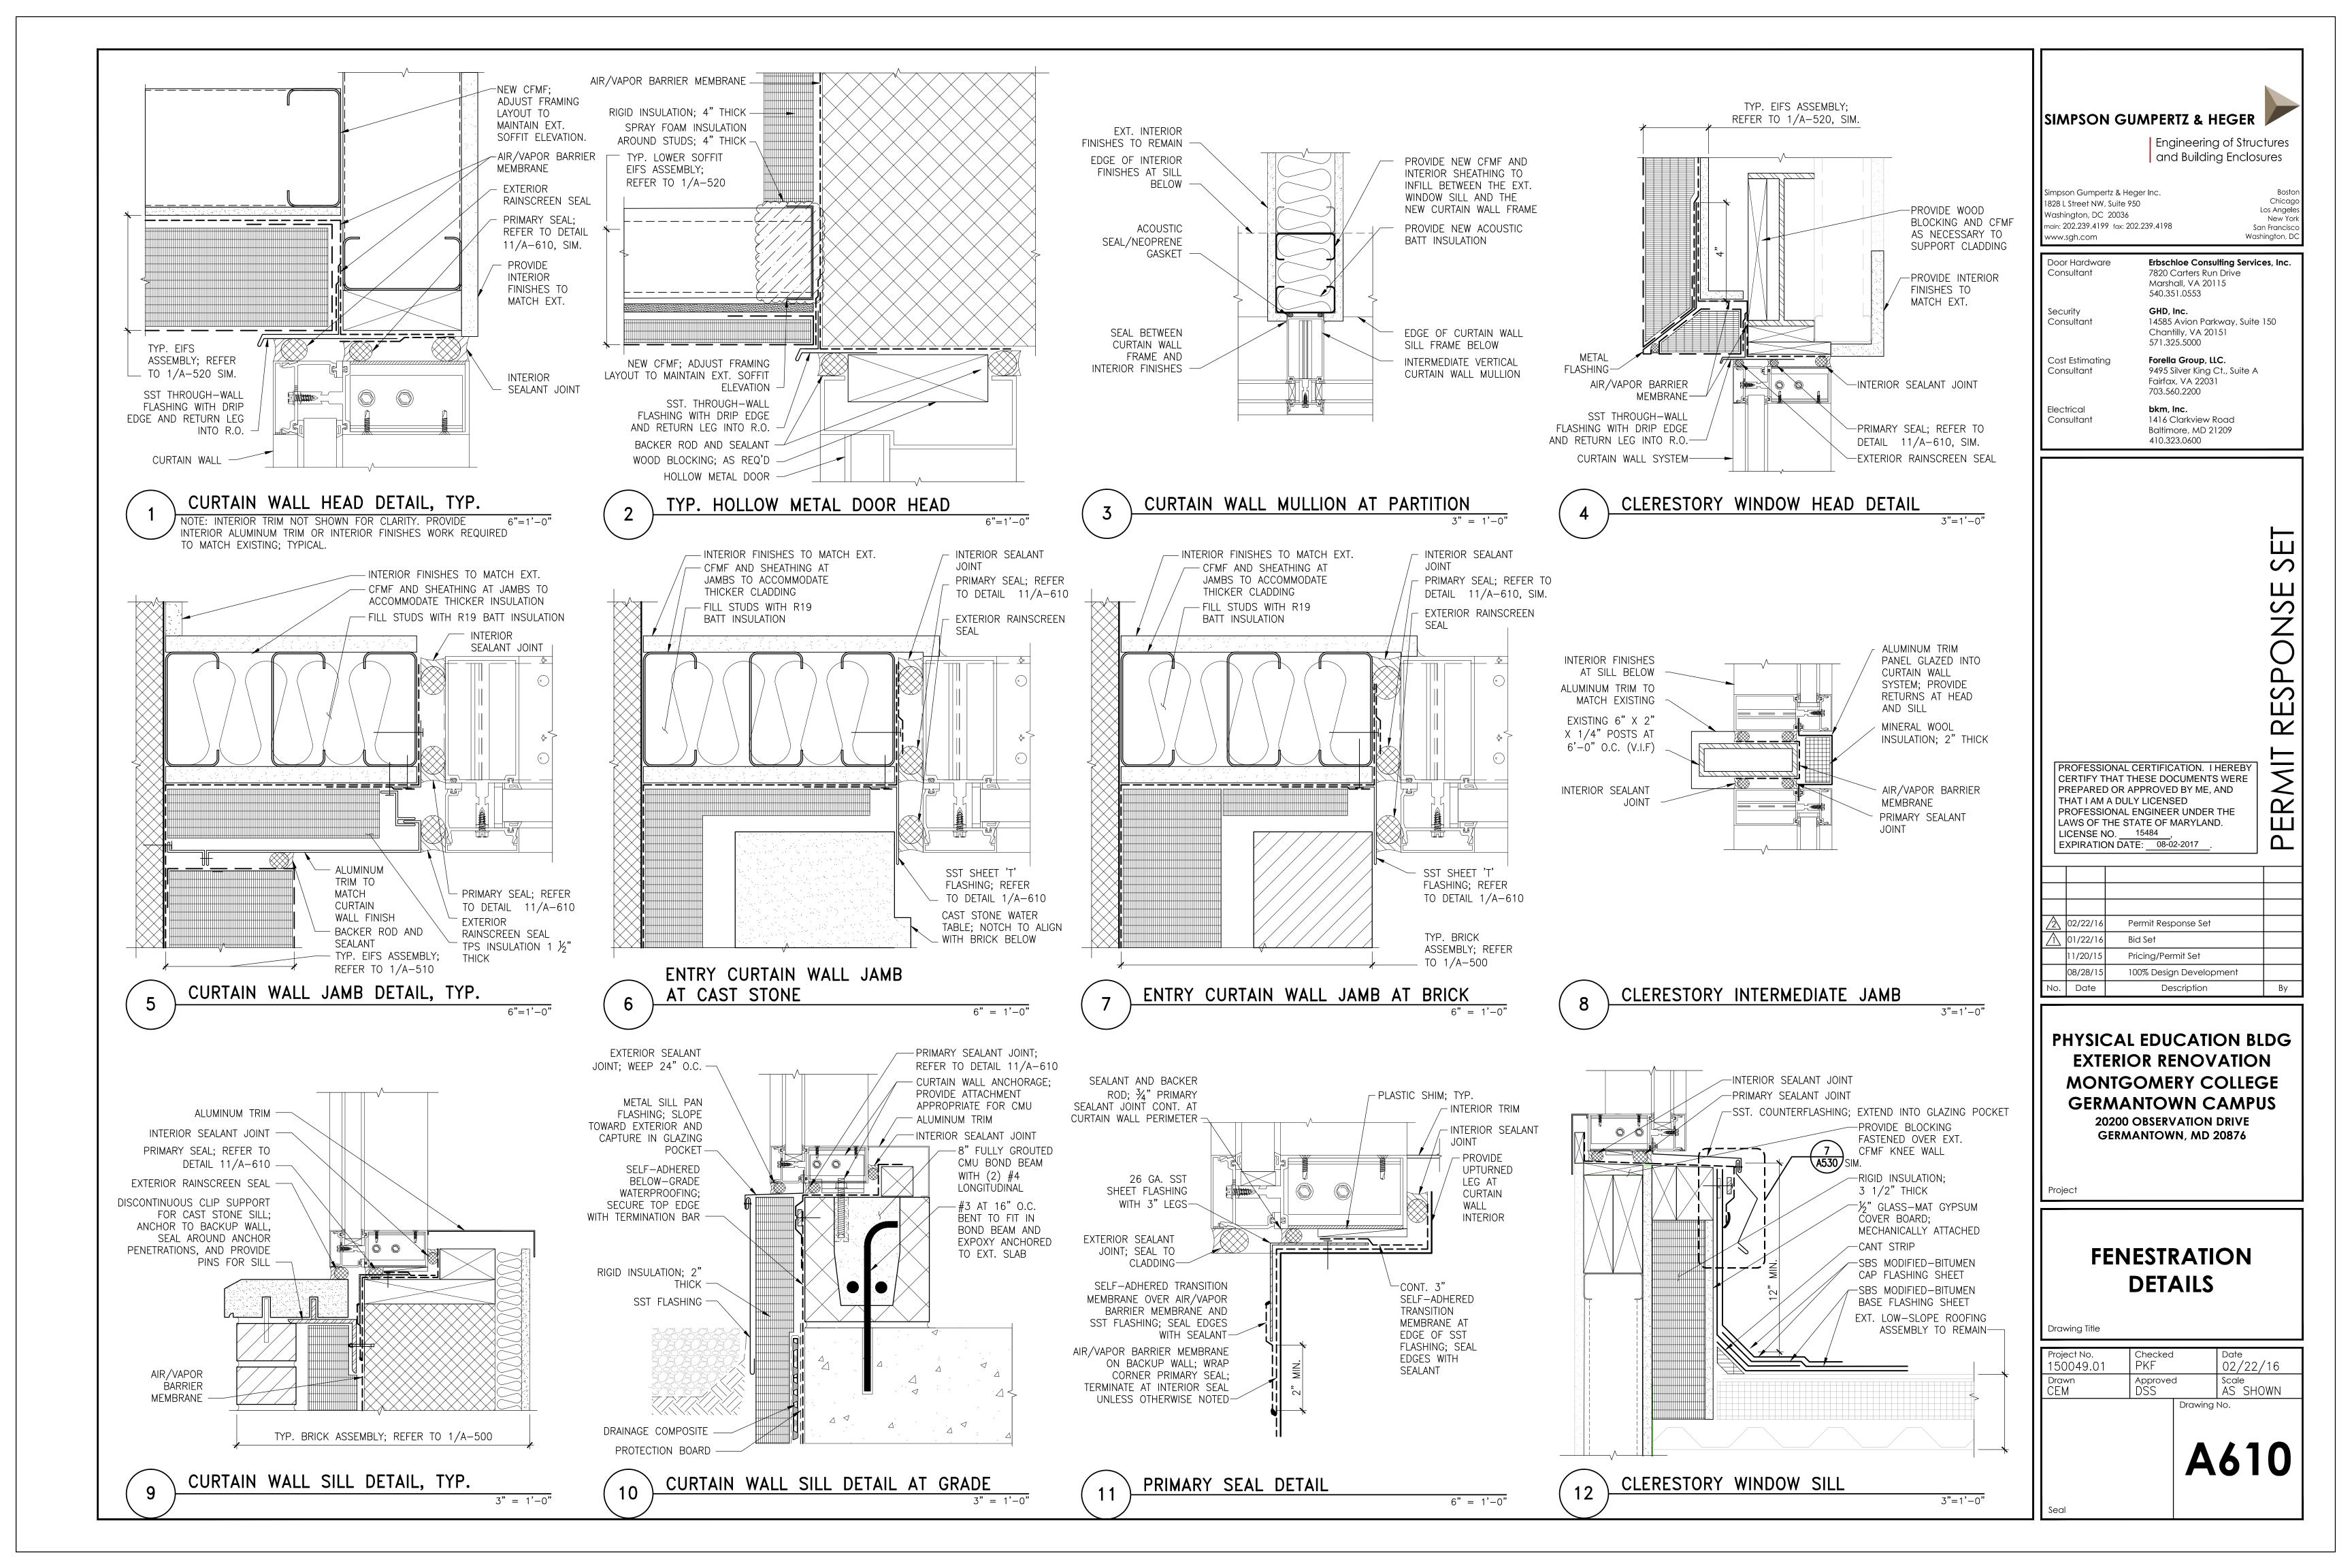
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NO	LOCATION	TYPE	SIZE	DOOR LEAF MATL	DOOR LEAF PQMT	FRAME MATL	FRAME PQMT	FIRE RATING	THRESHOLD DETAILS	HEAD DETAILS	JAMB DETAILS	HARDWARE	EMERGENCY	REMARKS
1	LOBBY	А	6'-0" X 8'-0"	ALUM/GL	EXT.	ALUM	NEW	TME	3/A611	1/A610	TBD	440 (YES <	
2	LOBBY	А	6'-0" X 8'-0"	ALUM/GL	EXT.	ALUM	NEW	TME	3/A611	1/A610	TBD	442	YES	2
15	ELEC. EQUP. ROOM	D	3'-0" X 8'-0"	НМ	NEW	НМ	EXT.	TME	EXT.	EXT.	EXT.	815	NO	
21	N. ENTRANCE	В	3'-0" X 8'-0"	ALUM/GL	NEW	ALUM	NEW	TME	3/A611	1/A611	5/A610	431 (YES	
22	HALLWAY #3	С	6'-0" X 8'-0"	НМ	NEW	НМ	NEW	TME	3/A611	1/A611	2/A611	322 (YES ⁴	
30	DRESSING ROOM	А	2'-6" X 6'-8"	НМ	NEW	НМ	EXT.	TME	EXT.	EXT.	EXT.	814	NO ,	2
34	POOL MNGR. ROOM	D	3'-0" X 8'-0"	НМ	NEW	НМ	EXT.	TME	EXT.	EXT.	EXT.	814	NO	
35	CLASSROOM	D	3'-0" X 8'-0"	НМ	NEW	НМ	NEW	TME	3/A611	1/A611	TBD	816	YES	
36	LOBBY	С	6'-0" X 8'-0"	FRP	NEW	НМ	EXT.	TME	EXT.	EXT.	EXT.	323 (NO ^r	PAINT EXT. FI
37	LOBBY	С	6'-0" X 8'-0"	НМ	NEW	НМ	EXT.	TME	TBD	TBD	TBD	325	YES ,	{
38	HALLWAY #2	С	6'-0" X 8'-0"	НМ	NEW	НМ	EXT.	TME	EXT.	EXT.	EXT.	325	YES)
40	STORAGE #4	С	6'-0" X 8'-0"	НМ	NEW	НМ	NEW	TME	3/A611	5/A611	2/A611	823	NO	
41	GYMNASIUM	С	6'-0" X 8'-0"	НМ	NEW	НМ	NEW	TME	3/A611	5/A611	2/A611	322 (YES ⁴	
42	GYMNASIUM	С	6'-0" X 8'-0"	НМ	NEW	НМ	NEW	TME	3/A611	5/A611	2/A611	326	YES 4	
43	STORAGE #3	С	6'-0" X 8'-0"	НМ	NEW	НМ	NEW	TME	3/A611	5/A611	2/A611	823	NO)
45	STORAGE #3	D	6'-0" X 8'-0"	НМ	NEW	НМ	NEW	TME	3/A611	5/A611	2/A611	813	NO	
46	GYMNASIUM	D	3'-0" X 8'-0"	НМ	NEW	НМ	NEW	TME	3/A611	5/A611	2/A611	312 (YES	
47	MECH. ROOM #3	D	3'-0" X 8'-0"	НМ	NEW	НМ	NEW	TME	3/A611	5/A611	2/A611	813 (NO <	<
48	MECH. ROOM #2	D	3'-0" X 8'-0"	НМ	NEW	НМ	NEW	TME	3/A611	5/A611	2/A611	813	NO)
49	GYMNASIUM	D	3'-0" X 8'-0"	НМ	NEW	НМ	NEW	TME	3/A611	5/A611	2/A611	312	YES)
50	MECH. ROOM #1	D	3'-0" X 8'-0"	НМ	NEW	НМ	NEW	TME	3/A611	5/A611	2/A611	813 (NO	
51	STORAGE #2	С	6'-0" X 8'-0"	НМ	NEW	НМ	EXT.	TME	3/A611	EXT.	EXT.	824 (NO <	
52	GYMNASIUM	С	6'-0" X 8'-0"	НМ	NEW	НМ	EXT.	TME	3/A611	EXT.	EXT.	320	YES ,	2
53	GYMNASIUM	С	6'-0" X 8'-0"	НМ	NEW	НМ	EXT.	TME	, 3/A611	EXT.	EXT.	320	YES	
54	STORAGE #1	С	6'-0" X 8'-0"	НМ	NEW	НМ	EXT.	TME	, 3/A611	EXT.	EXT.	824	NO	
58	HALLWAY #3	С	6'-0" X 8'-0"	FRP	NEW	НМ	EXT.	TME	EXT.	EXT.	EXT.	324 (YES ⁴	PAINT EXT. FI
61	POOL DECK	С	6'-0" X 8'-0"	FRP	NEW	FRP	NEW	TME	3/A611	2/A610	2/A611	322	YES ,	2
63	POOL	С	6'-0" X 8'-0"	FRP	NEW	FRP	NEW	TME	, 3/A611	, 2/A610	2/A611	326	YES)
66	POOL DECK	С	6'-0" X 8'-0"	FRP	NEW	FRP	NEW	TME	, 3/A611	, 2/A610	, 2/A611	322	YES	
67	POOL EQUIP. ROOM	D	6'-0" X 8'-0"	FRP	NEW	FRP	NEW	TME	, 3/A611	2/A610	, 2/A611	813 (NO	
70	WT. ROOM	С	6'-0" X 8'-0"	HM	NEW	НМ	NEW	TME	, 3/A611	, 1/A610	TBD	322	YES 4	2
71	WT. ROOM	С	6'-0" X 8'-0"	НМ	NEW	НМ	NEW	ТМЕ	3/A611	1/A610	TBD	322	YES)

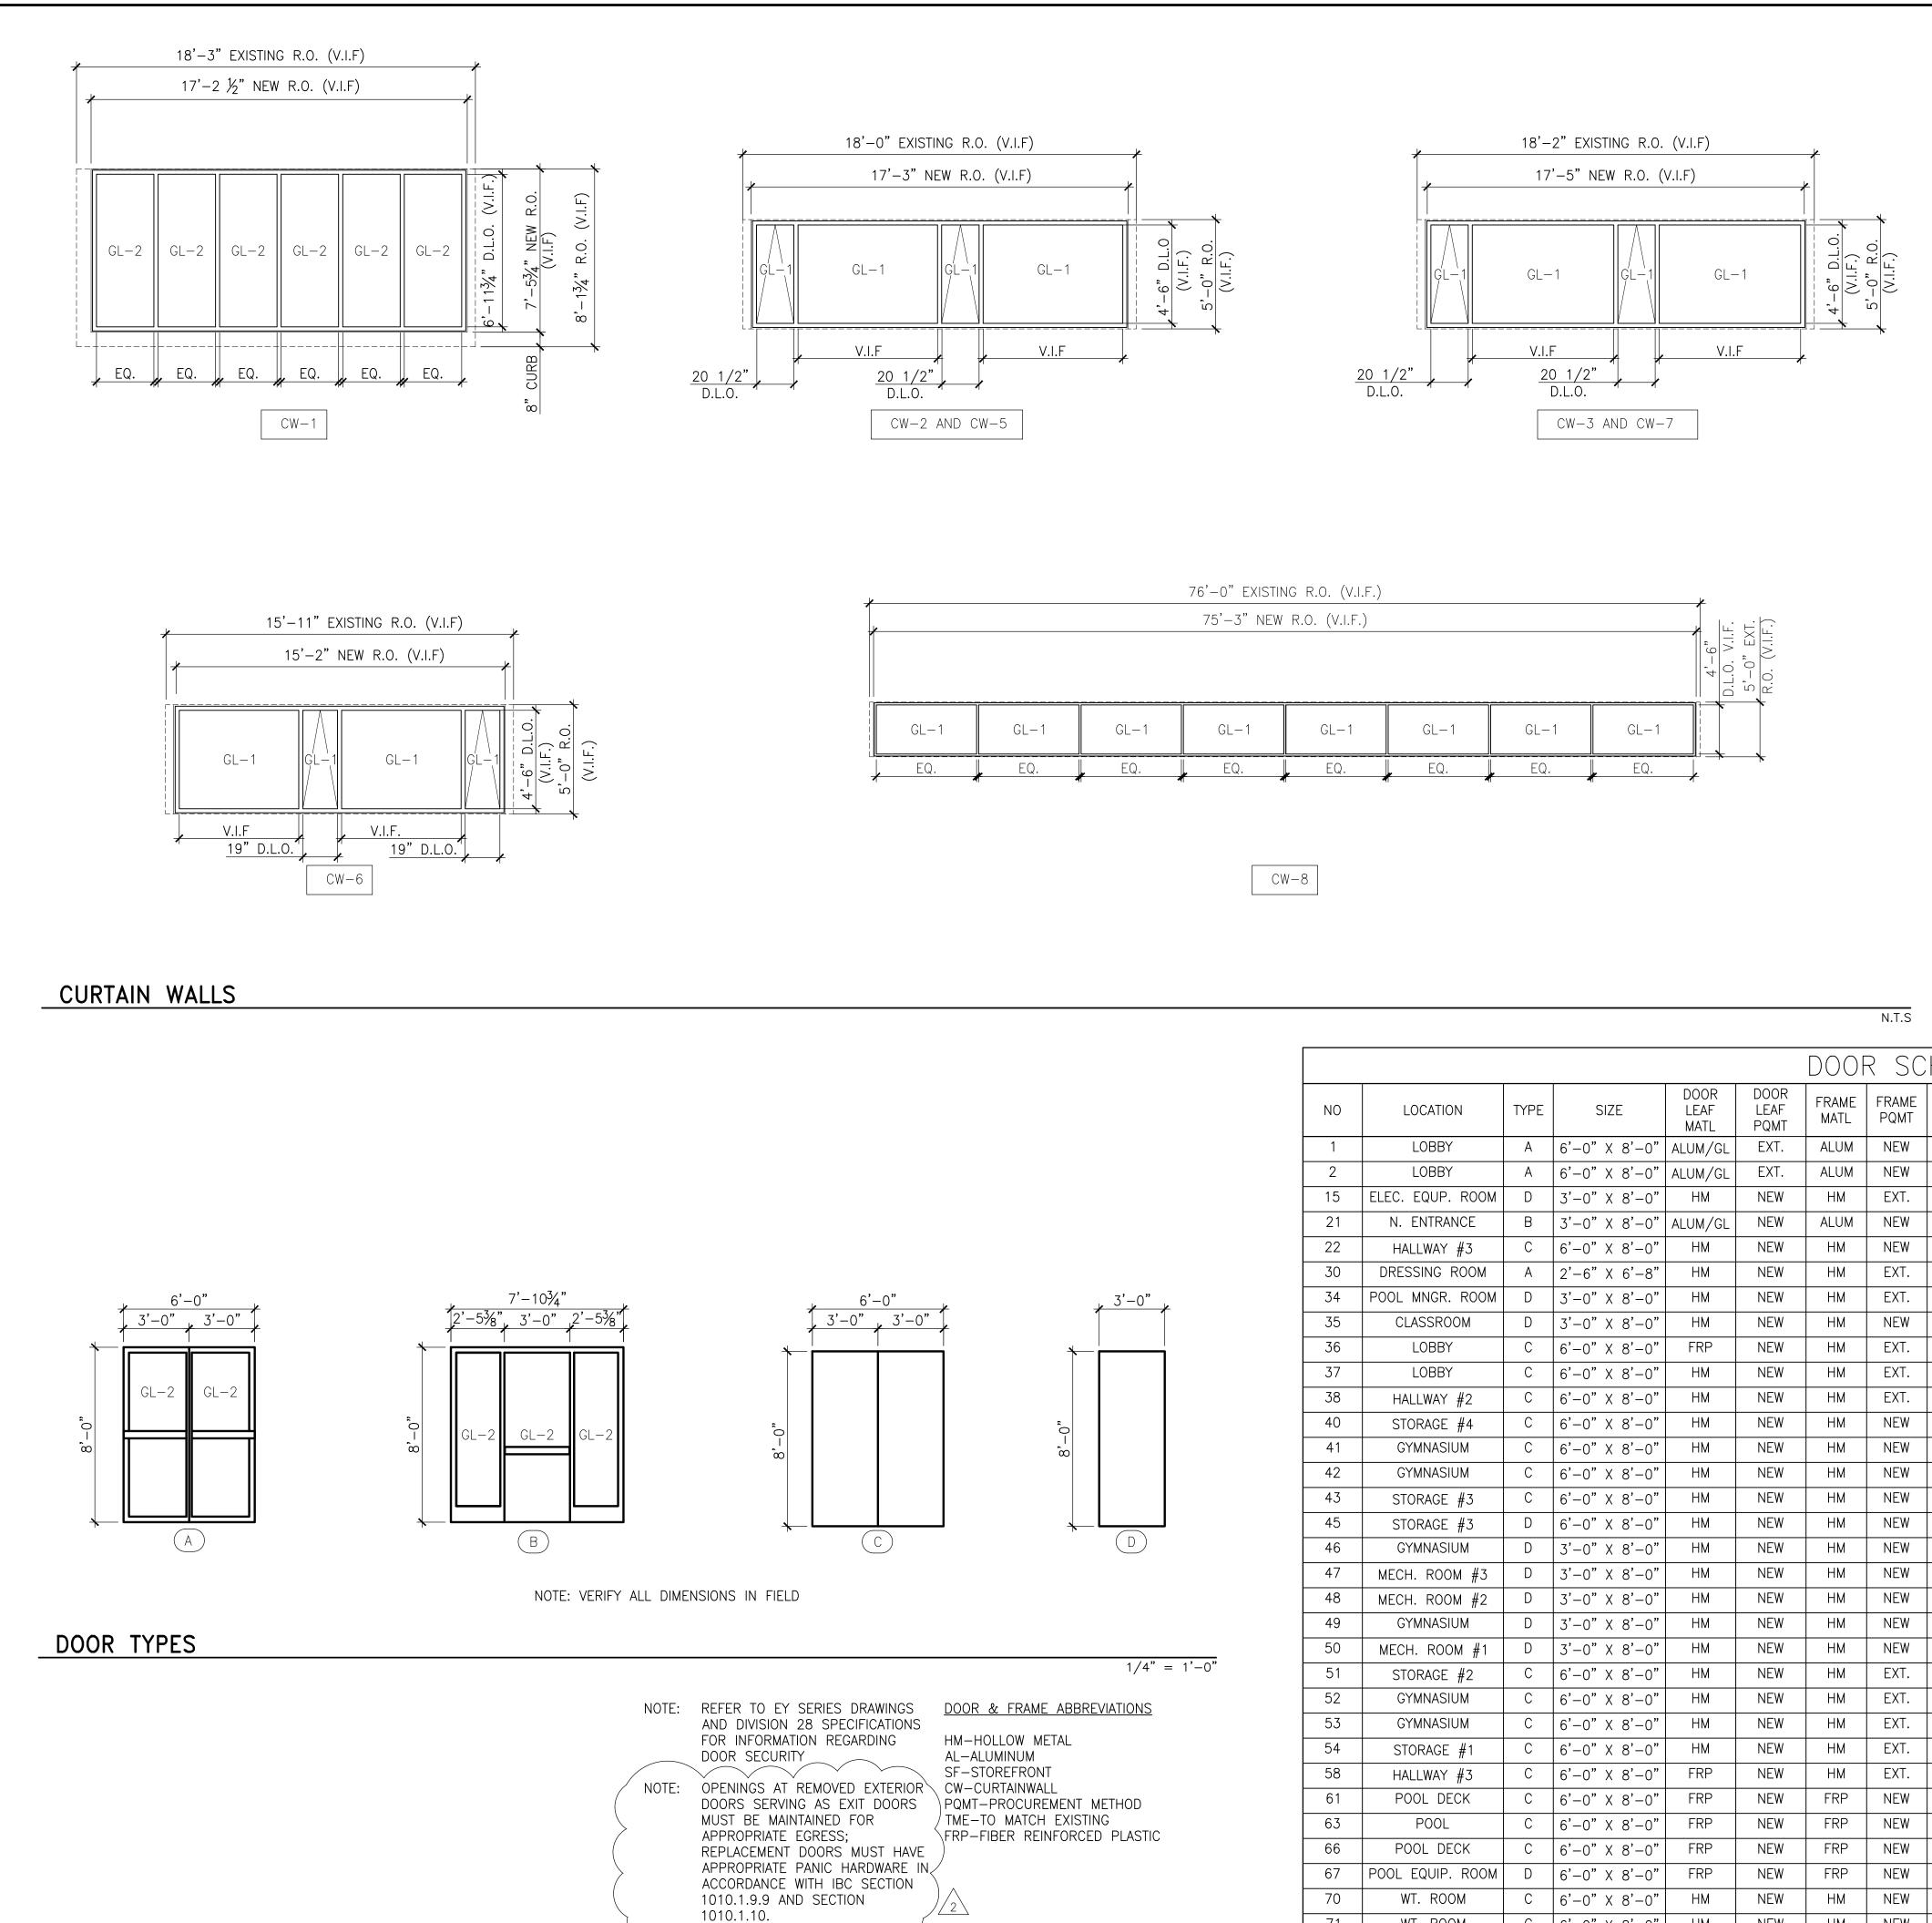


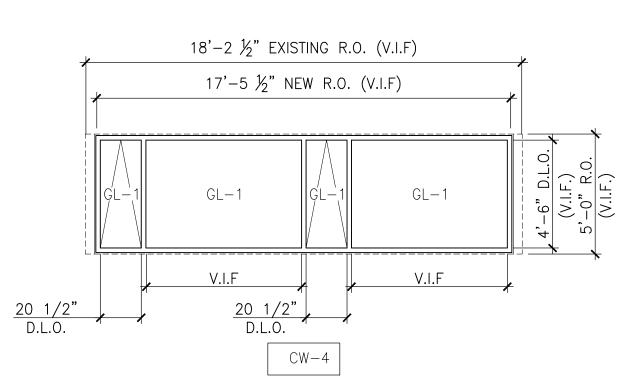


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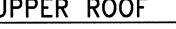
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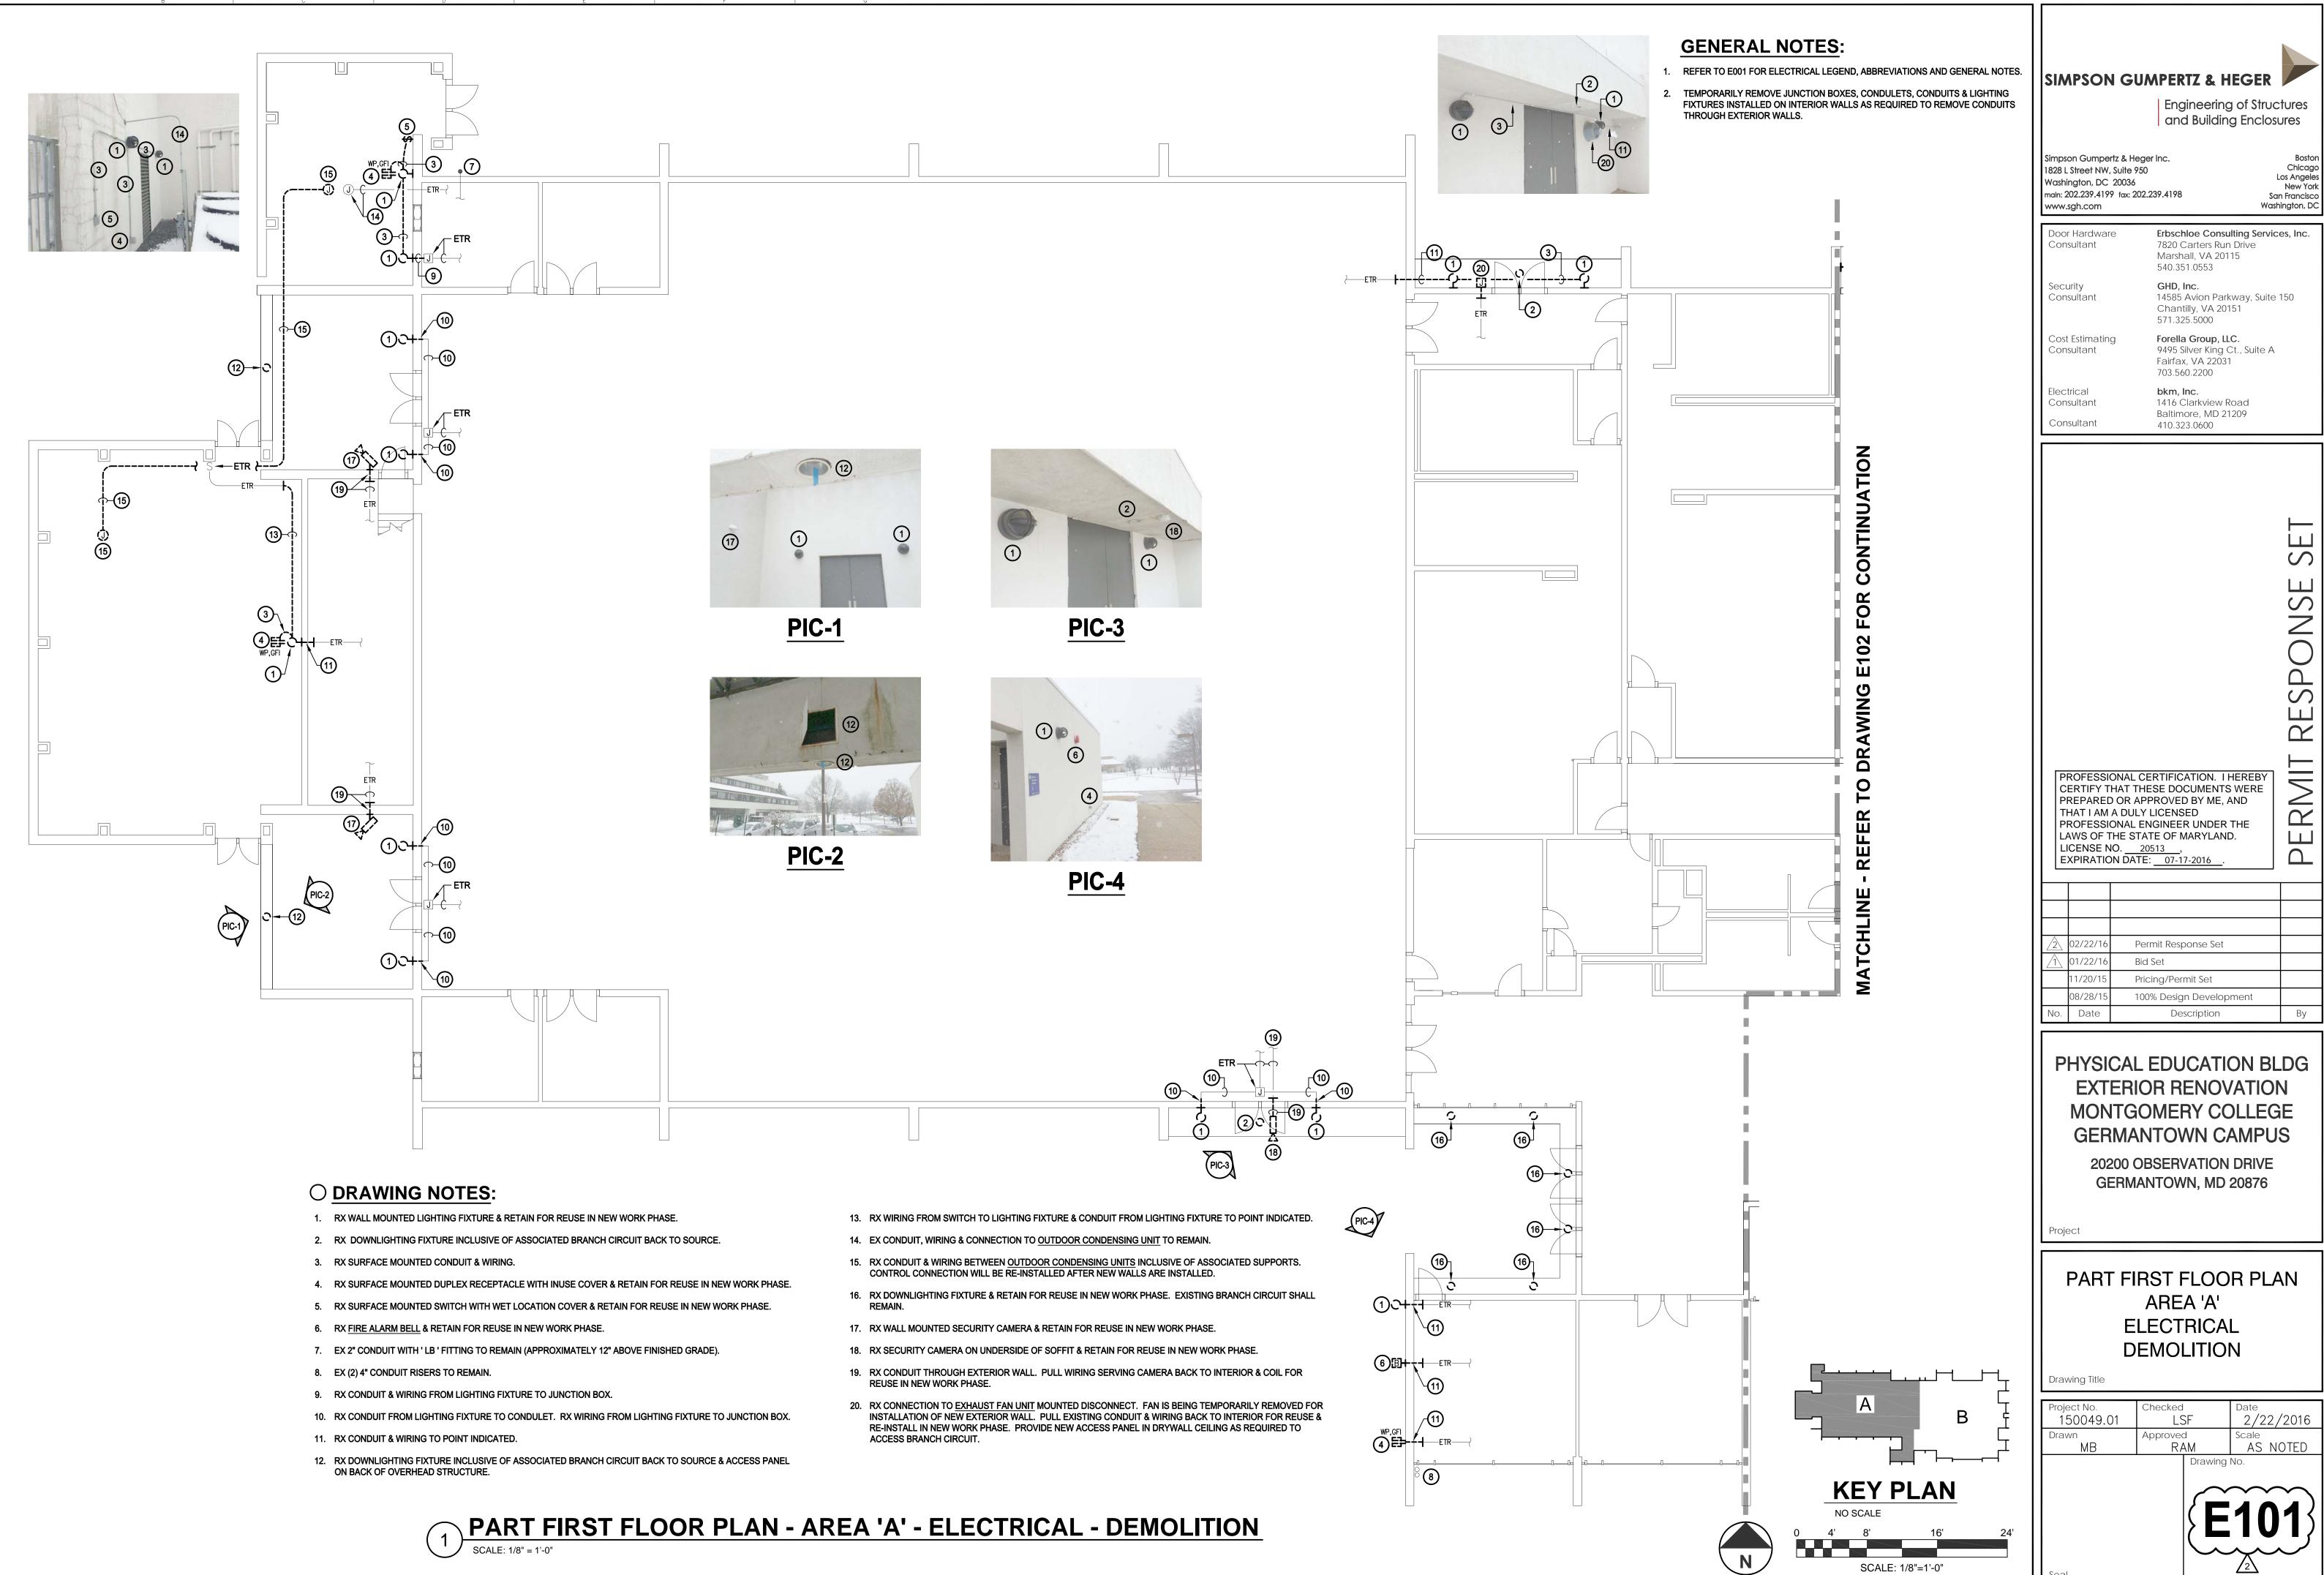


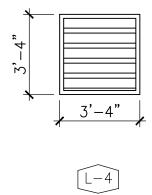


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3" = 1'-0"	PHYSICAL EDUCATION BLDG EXTERIOR RENOVATION MONTGOMERY COLLEGE GERMANTOWN CAMPUS J0200 OBSERVATION DRIVE GERMANTOWN, MD 20876 Project Project FENESTRATION DETAILS Drawing Title Project No. 150049.01 PKF Date DSS Date Approved DSS Date AS SHOWN Date AS SHOWN Mathematical Action Date DSS Date AS SHOWN Date AS SHOWN Actional Ac

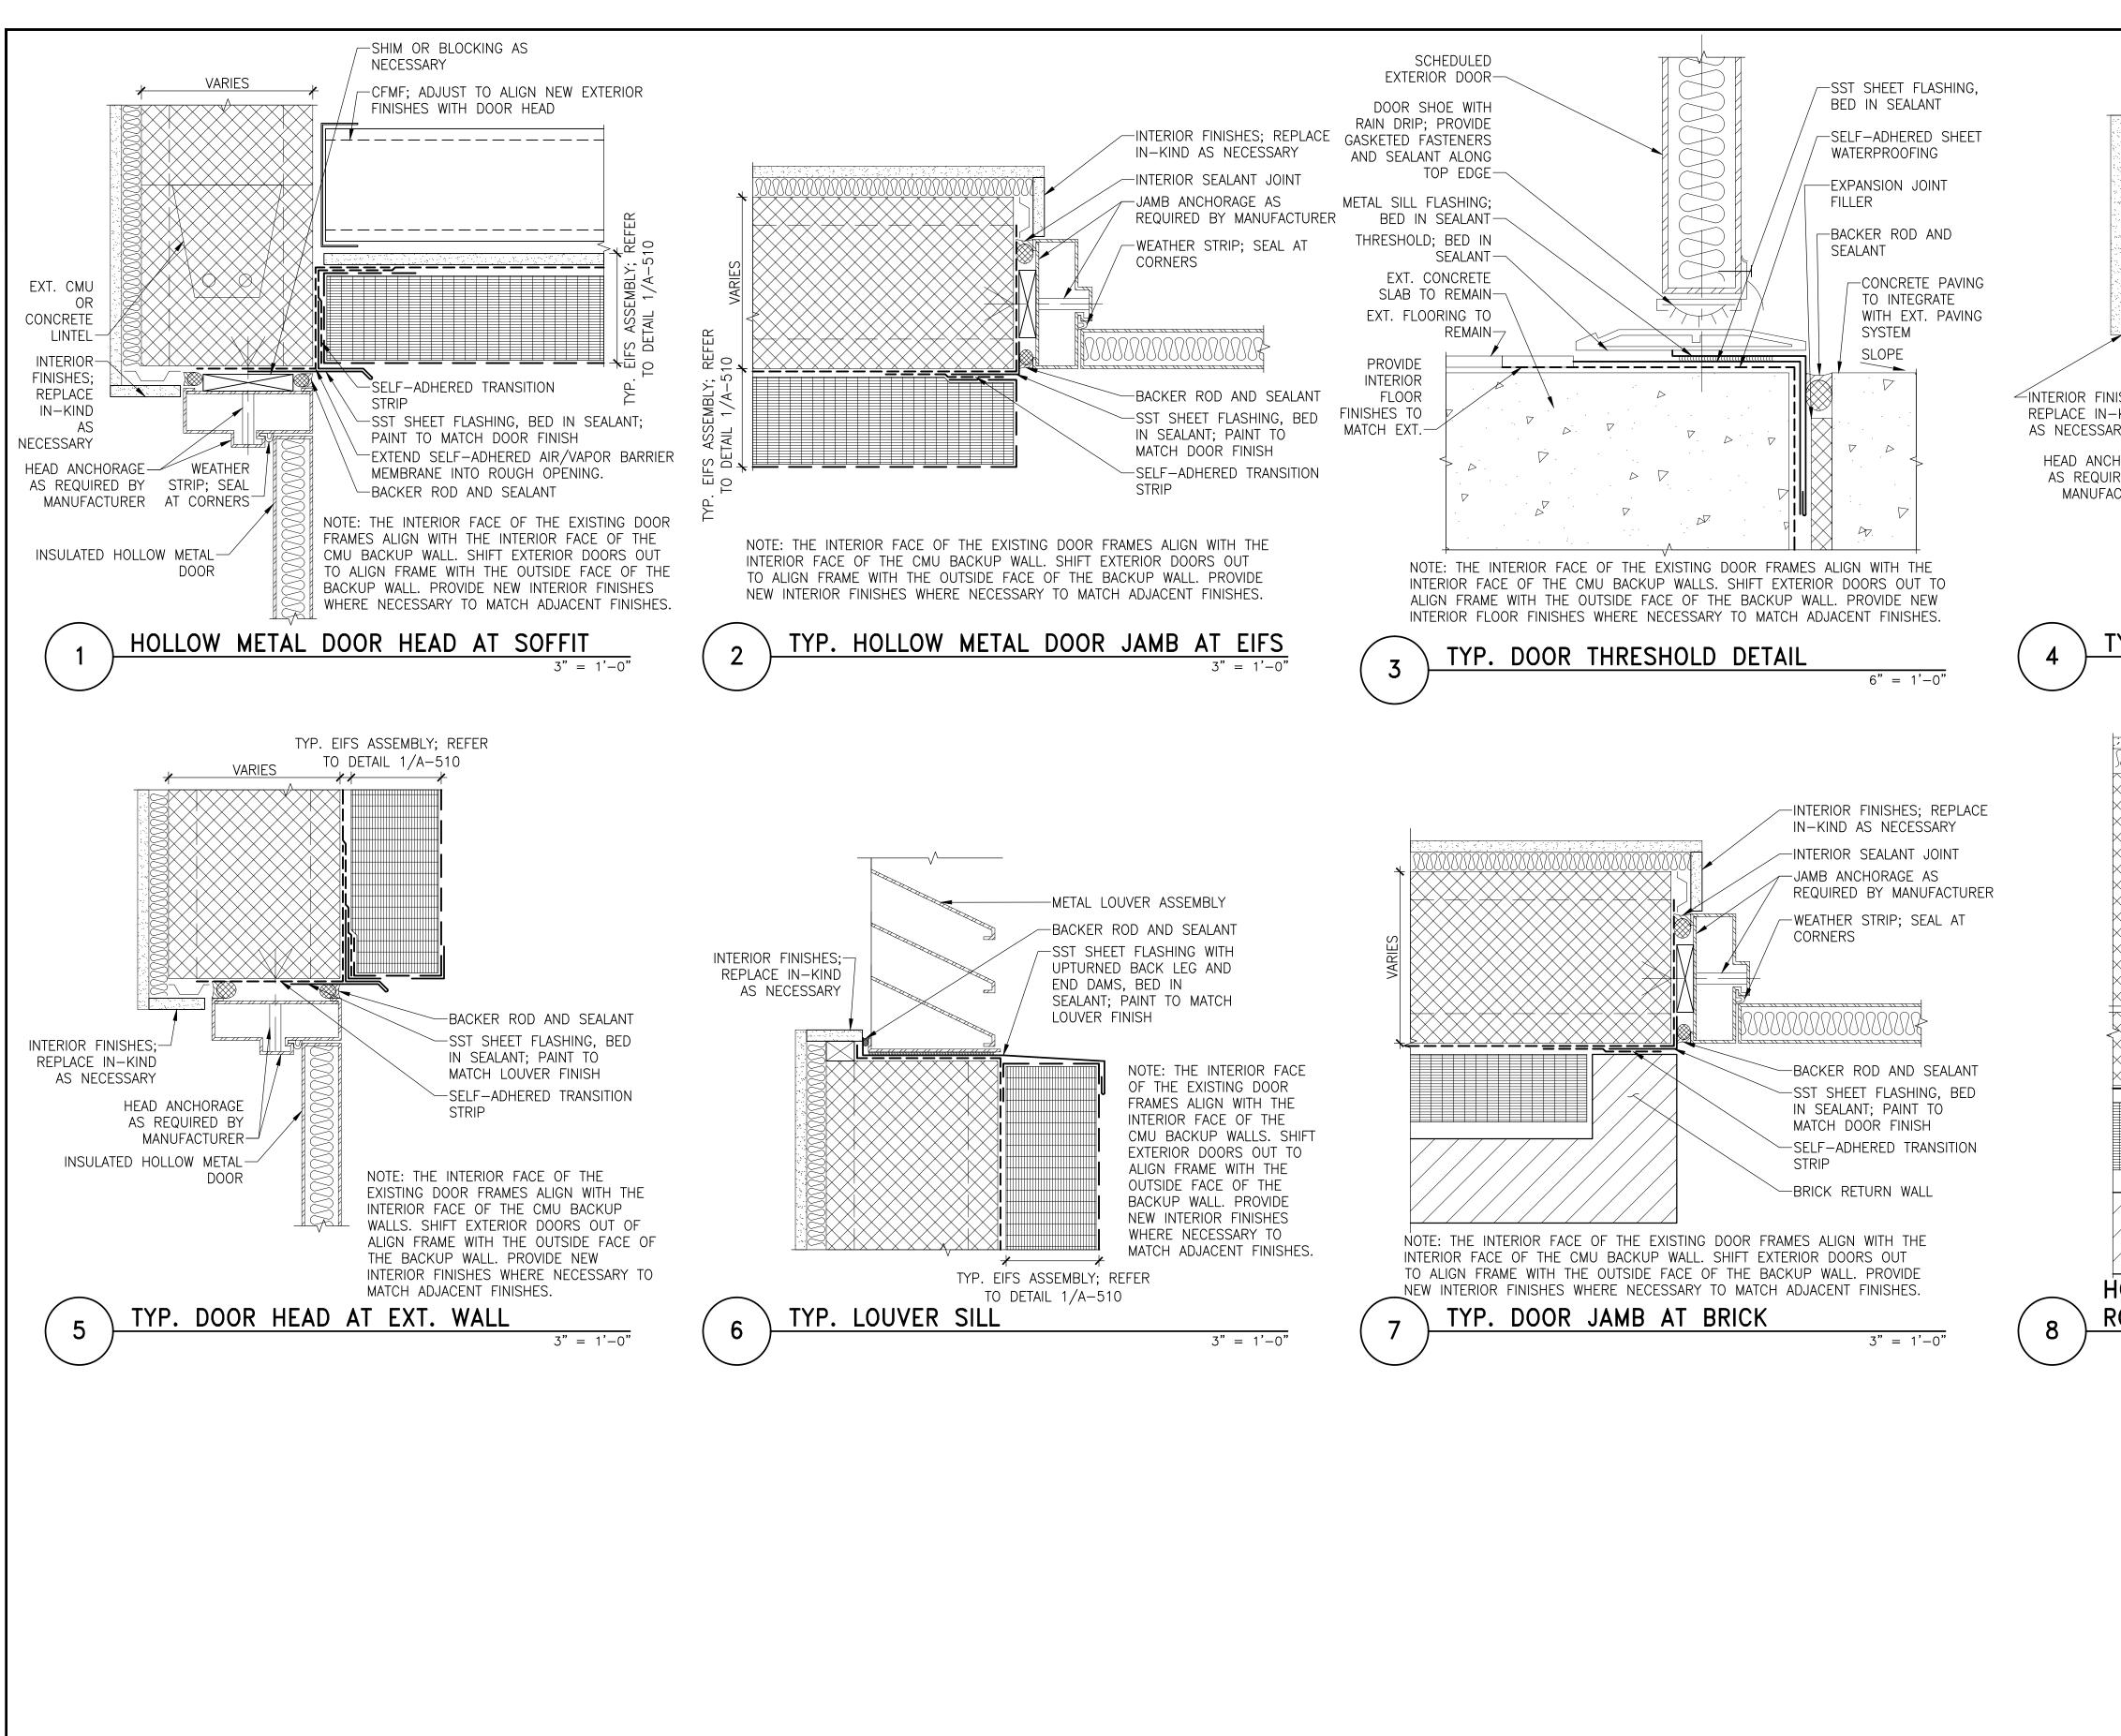



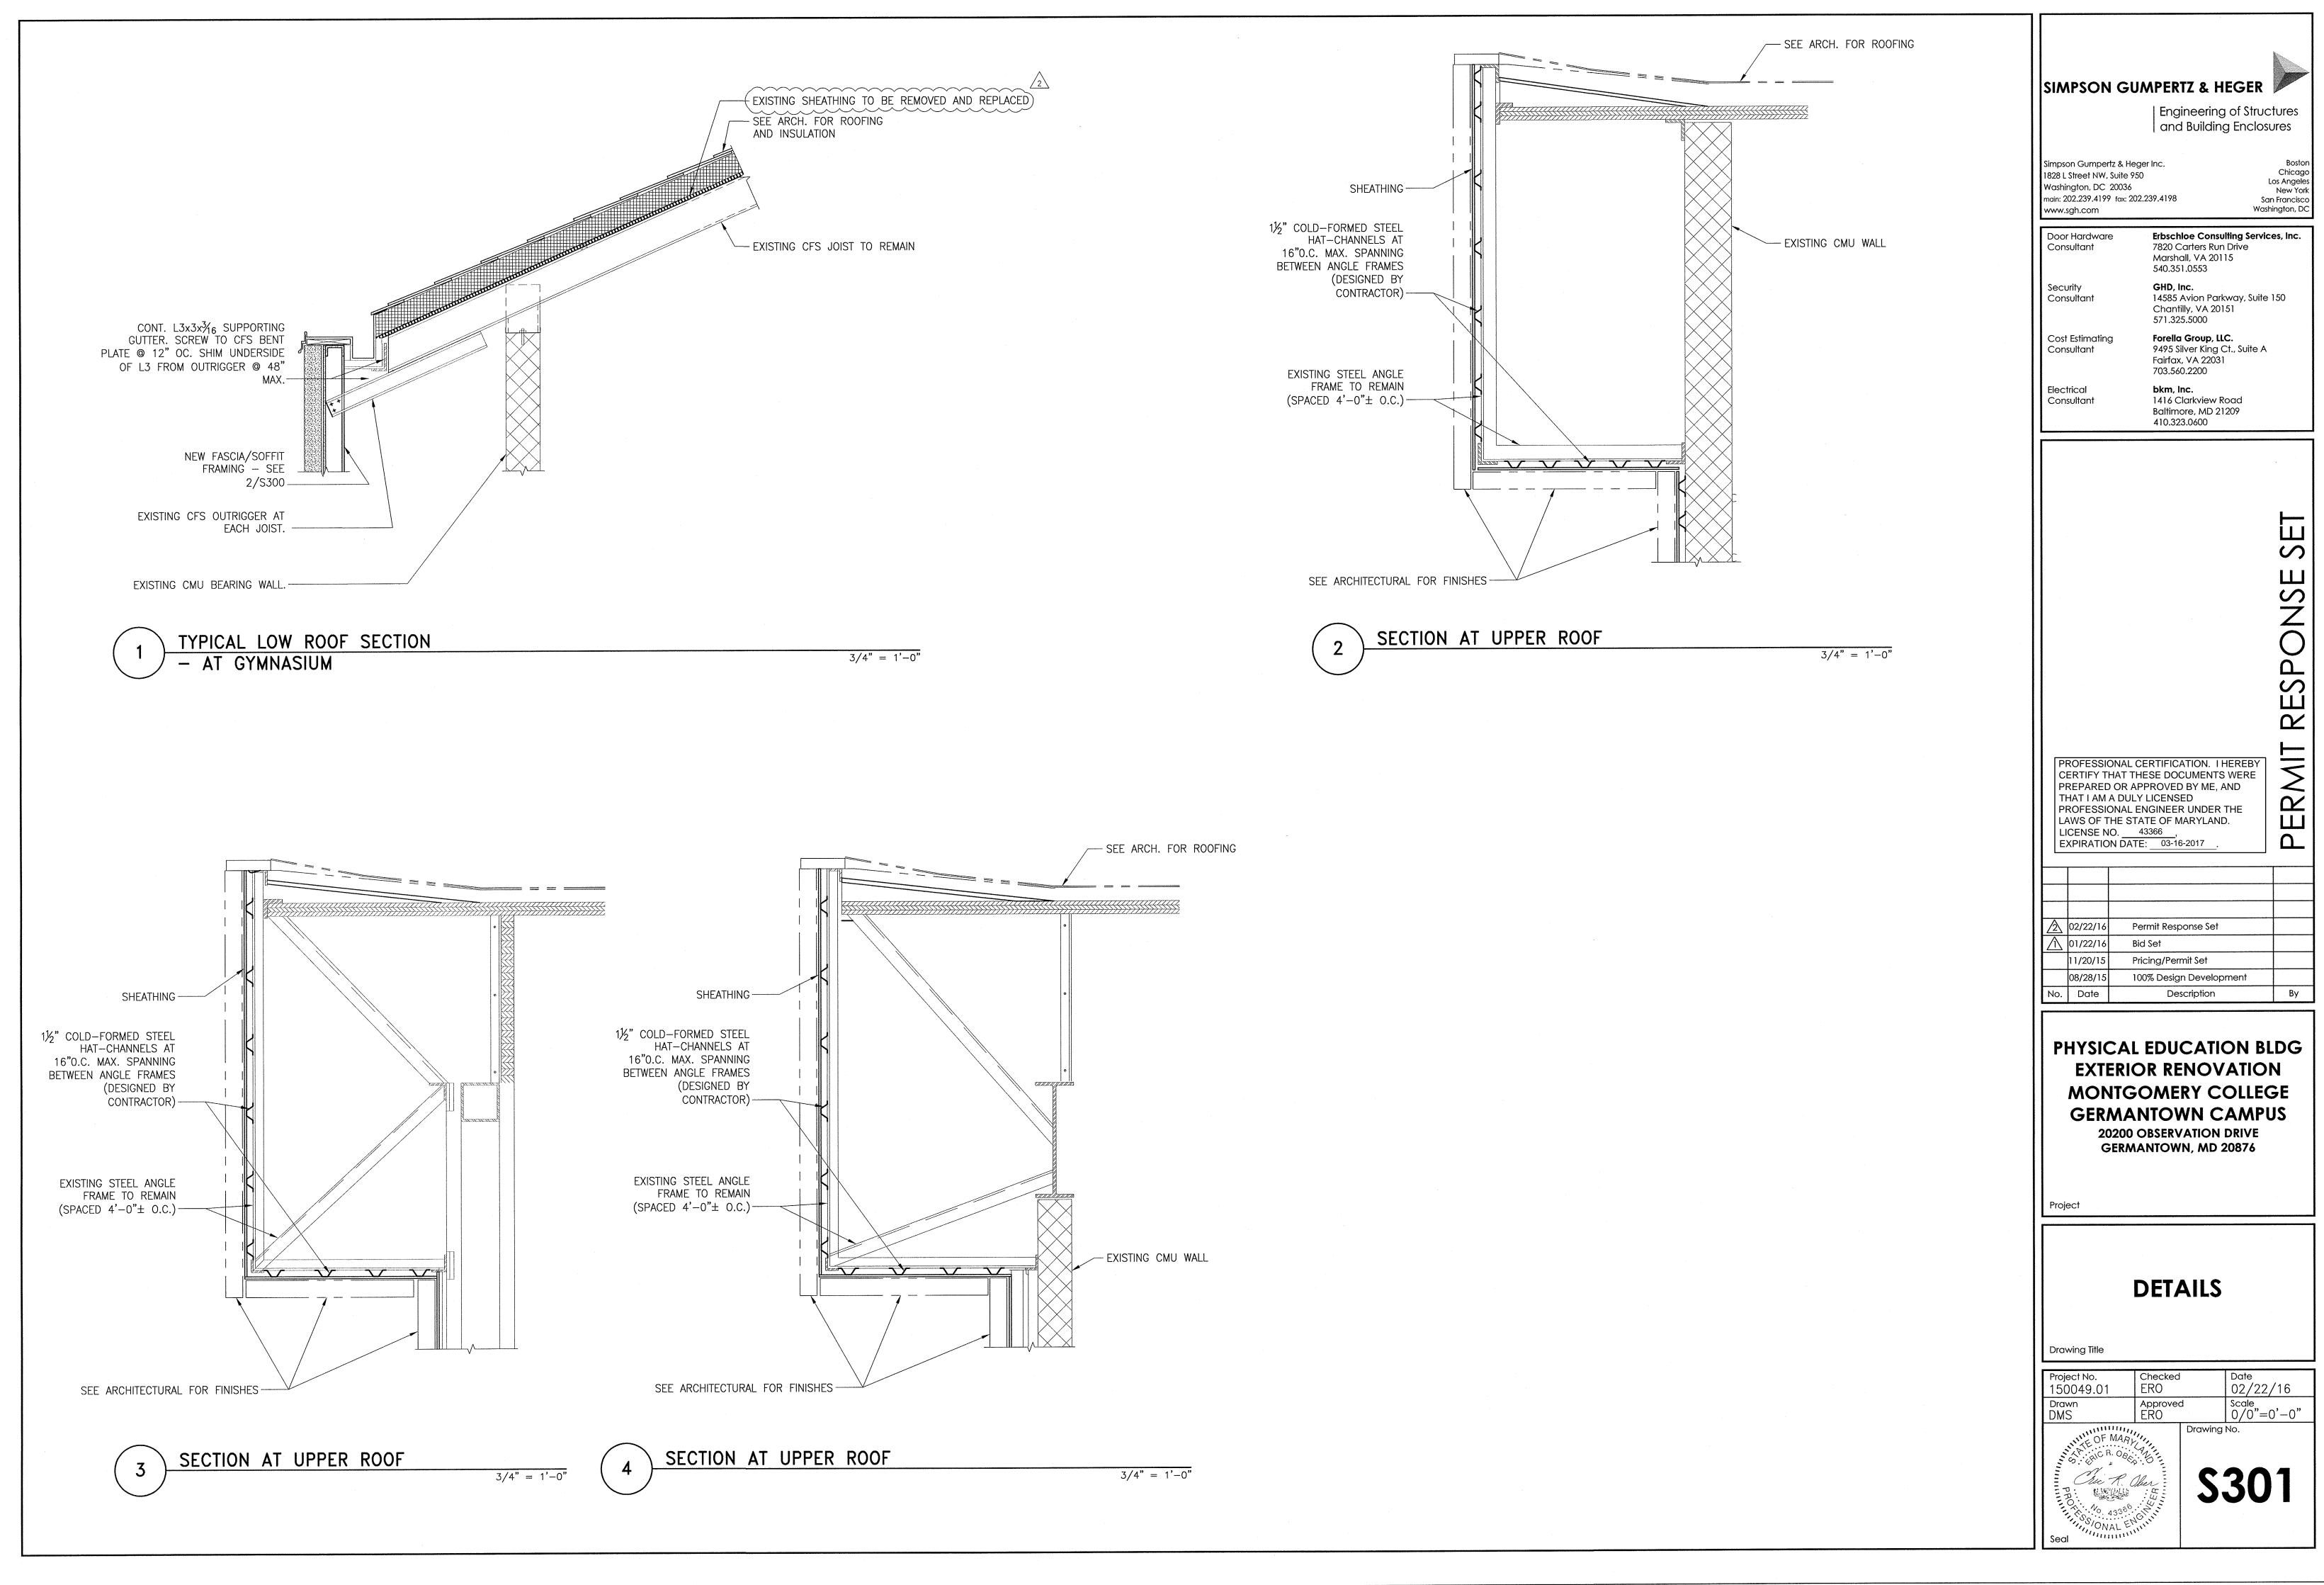

BKM# 16009.01

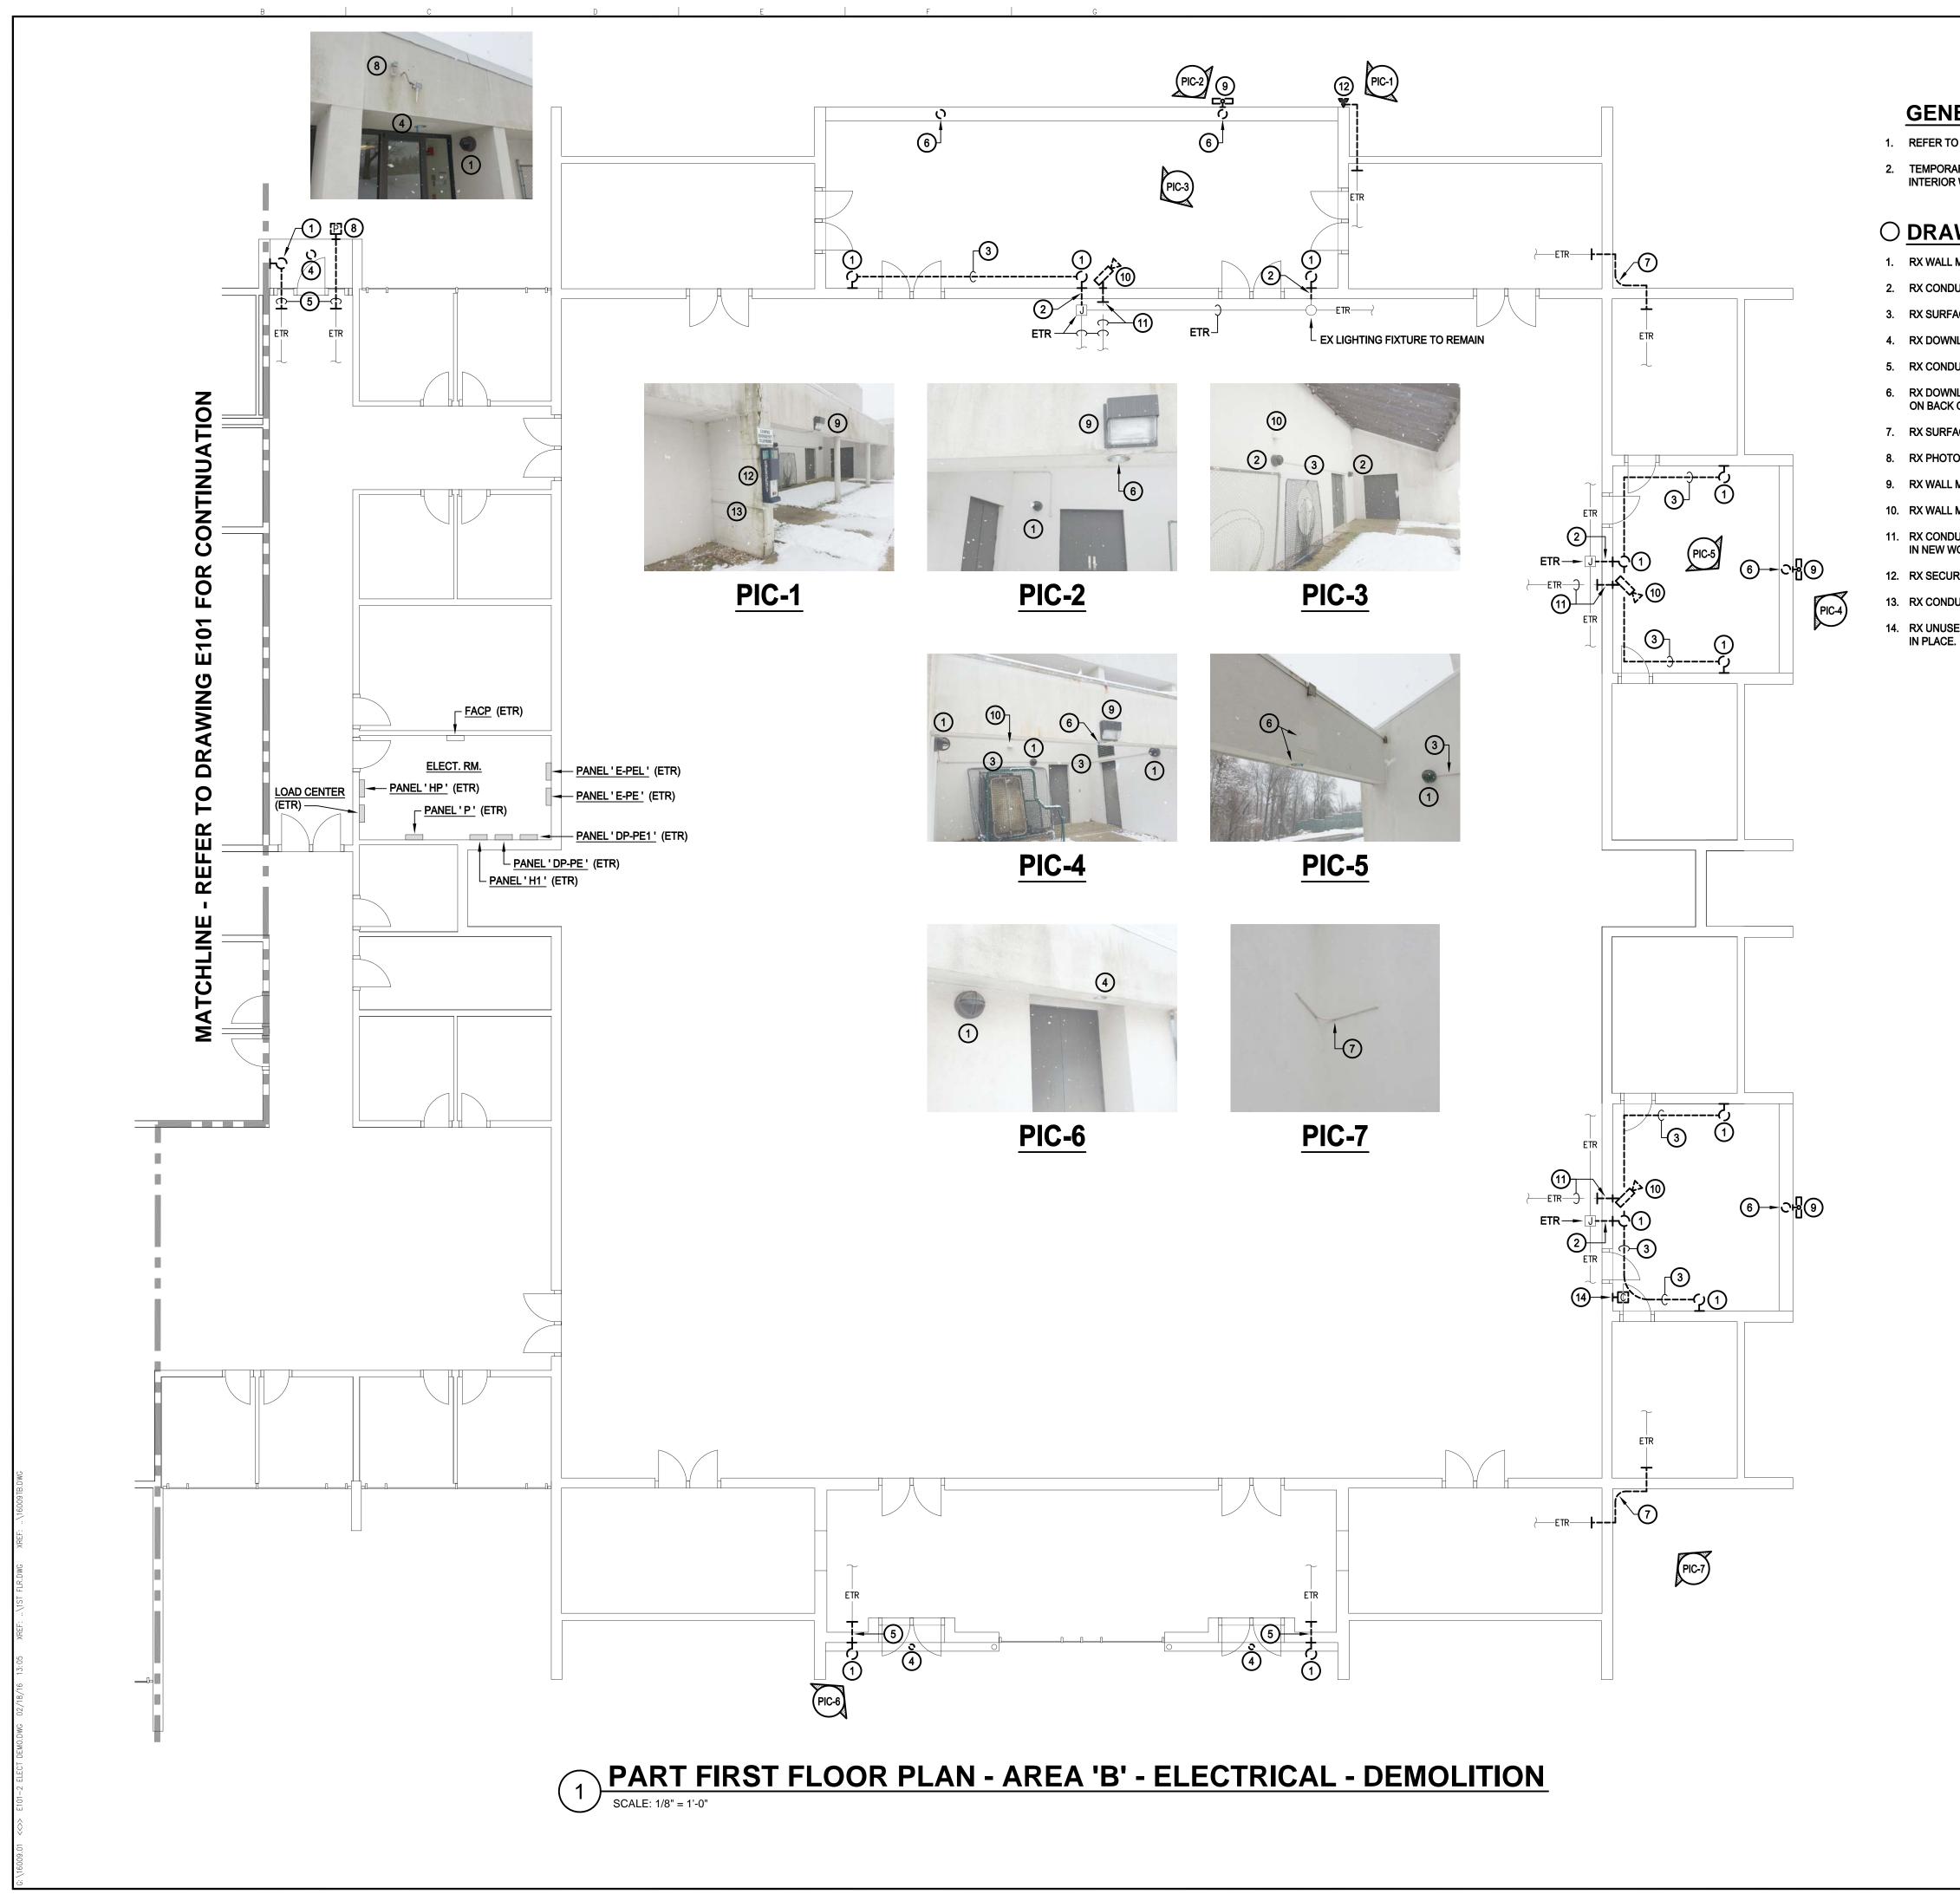

GENERAL NOTES:

1. REFER TO E001 FOR ELECTRICAL LEGEND, ABBREVIATIONS AND GENERAL NOTES.

2. TEMPORARILY REMOVE JUNCTION BOXES, CONDULETS, CONDUITS & LIGHTING FIXTURES INSTALLED ON INTERIOR WALLS AS REQUIRED TO REMOVE CONDUITS THROUGH EXTERIOR WALLS.

O DRAWING NOTES:

1. RX WALL MOUNTED LIGHTING FIXTURE & RETAIN FOR REUSE IN NEW WORK PHASE.

2. RX CONDUIT & WIRING FROM LIGHTING FIXTURE TO JUNCTION BOX OR LIGHTING FIXTURE.

3. RX SURFACE MOUNTED CONDUIT & WIRING.

4. RX DOWNLIGHTING FIXTURE INCLUSIVE OF ASSOCIATED BRANCH CIRCUIT BACK TO SOURCE. 5. RX CONDUIT & WIRING BACK TO POINT INDICATED.

6. RX DOWNLIGHTING FIXTURE INCLUSIVE OF ASSOCIATED BRANCH CIRCUIT BACK TO SOURCE & ACCESS PANEL ON BACK OF OVERHEAD STRUCTURE.

7. RX SURFACE MOUNTED CONDUIT & WIRING TO POINT INDICATED.

8. RX PHOTO CELL & RETAIN FOR REUSE IN NEW WORK PHASE.

9. RX WALL MOUNTED HALOGEN LIGHTING FIXTURE & ASSOCIATED BRANCH CIRCUIT BACK TO SOURCE.

10. RX WALL MOUNTED SECURITY CAMERA & RETAIN FOR REUSE IN NEW WORK PHASE.

11. RX CONDUIT THROUGH EXTERIOR WALL. PULL WIRING SERVING CAMERA BACK TO INTERIOR & COIL FOR REUSE IN NEW WORK PHASE.

12. RX SECURITY BLUE PHONE & RETAIN FOR REUSE IN NEW WORK PHASE.

13. RX CONDUIT & WIRING BACK TO POINT INDICATED.

14. RX UNUSED WIRING FROM OUTLET BOX BACK TO SOURCE. RE-INSTALL BLANK COVER & ABANDON OUTLET BOX

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	r Hardware sultant	Erbschloe Cons 7820 Carters Ru		vices, Ir
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Con	sultant	Baltimore, MD 2 410.323.0600	21209	
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MONTGOMERY COLLEGE GERMANTOWN CAMPUS

20200 OBSERVATION DRIVE GERMANTOWN, MD 20876

PART FIRST FLOOR PLAN AREA 'B' ELECTRICAL DEMOLITION

Drawing Title


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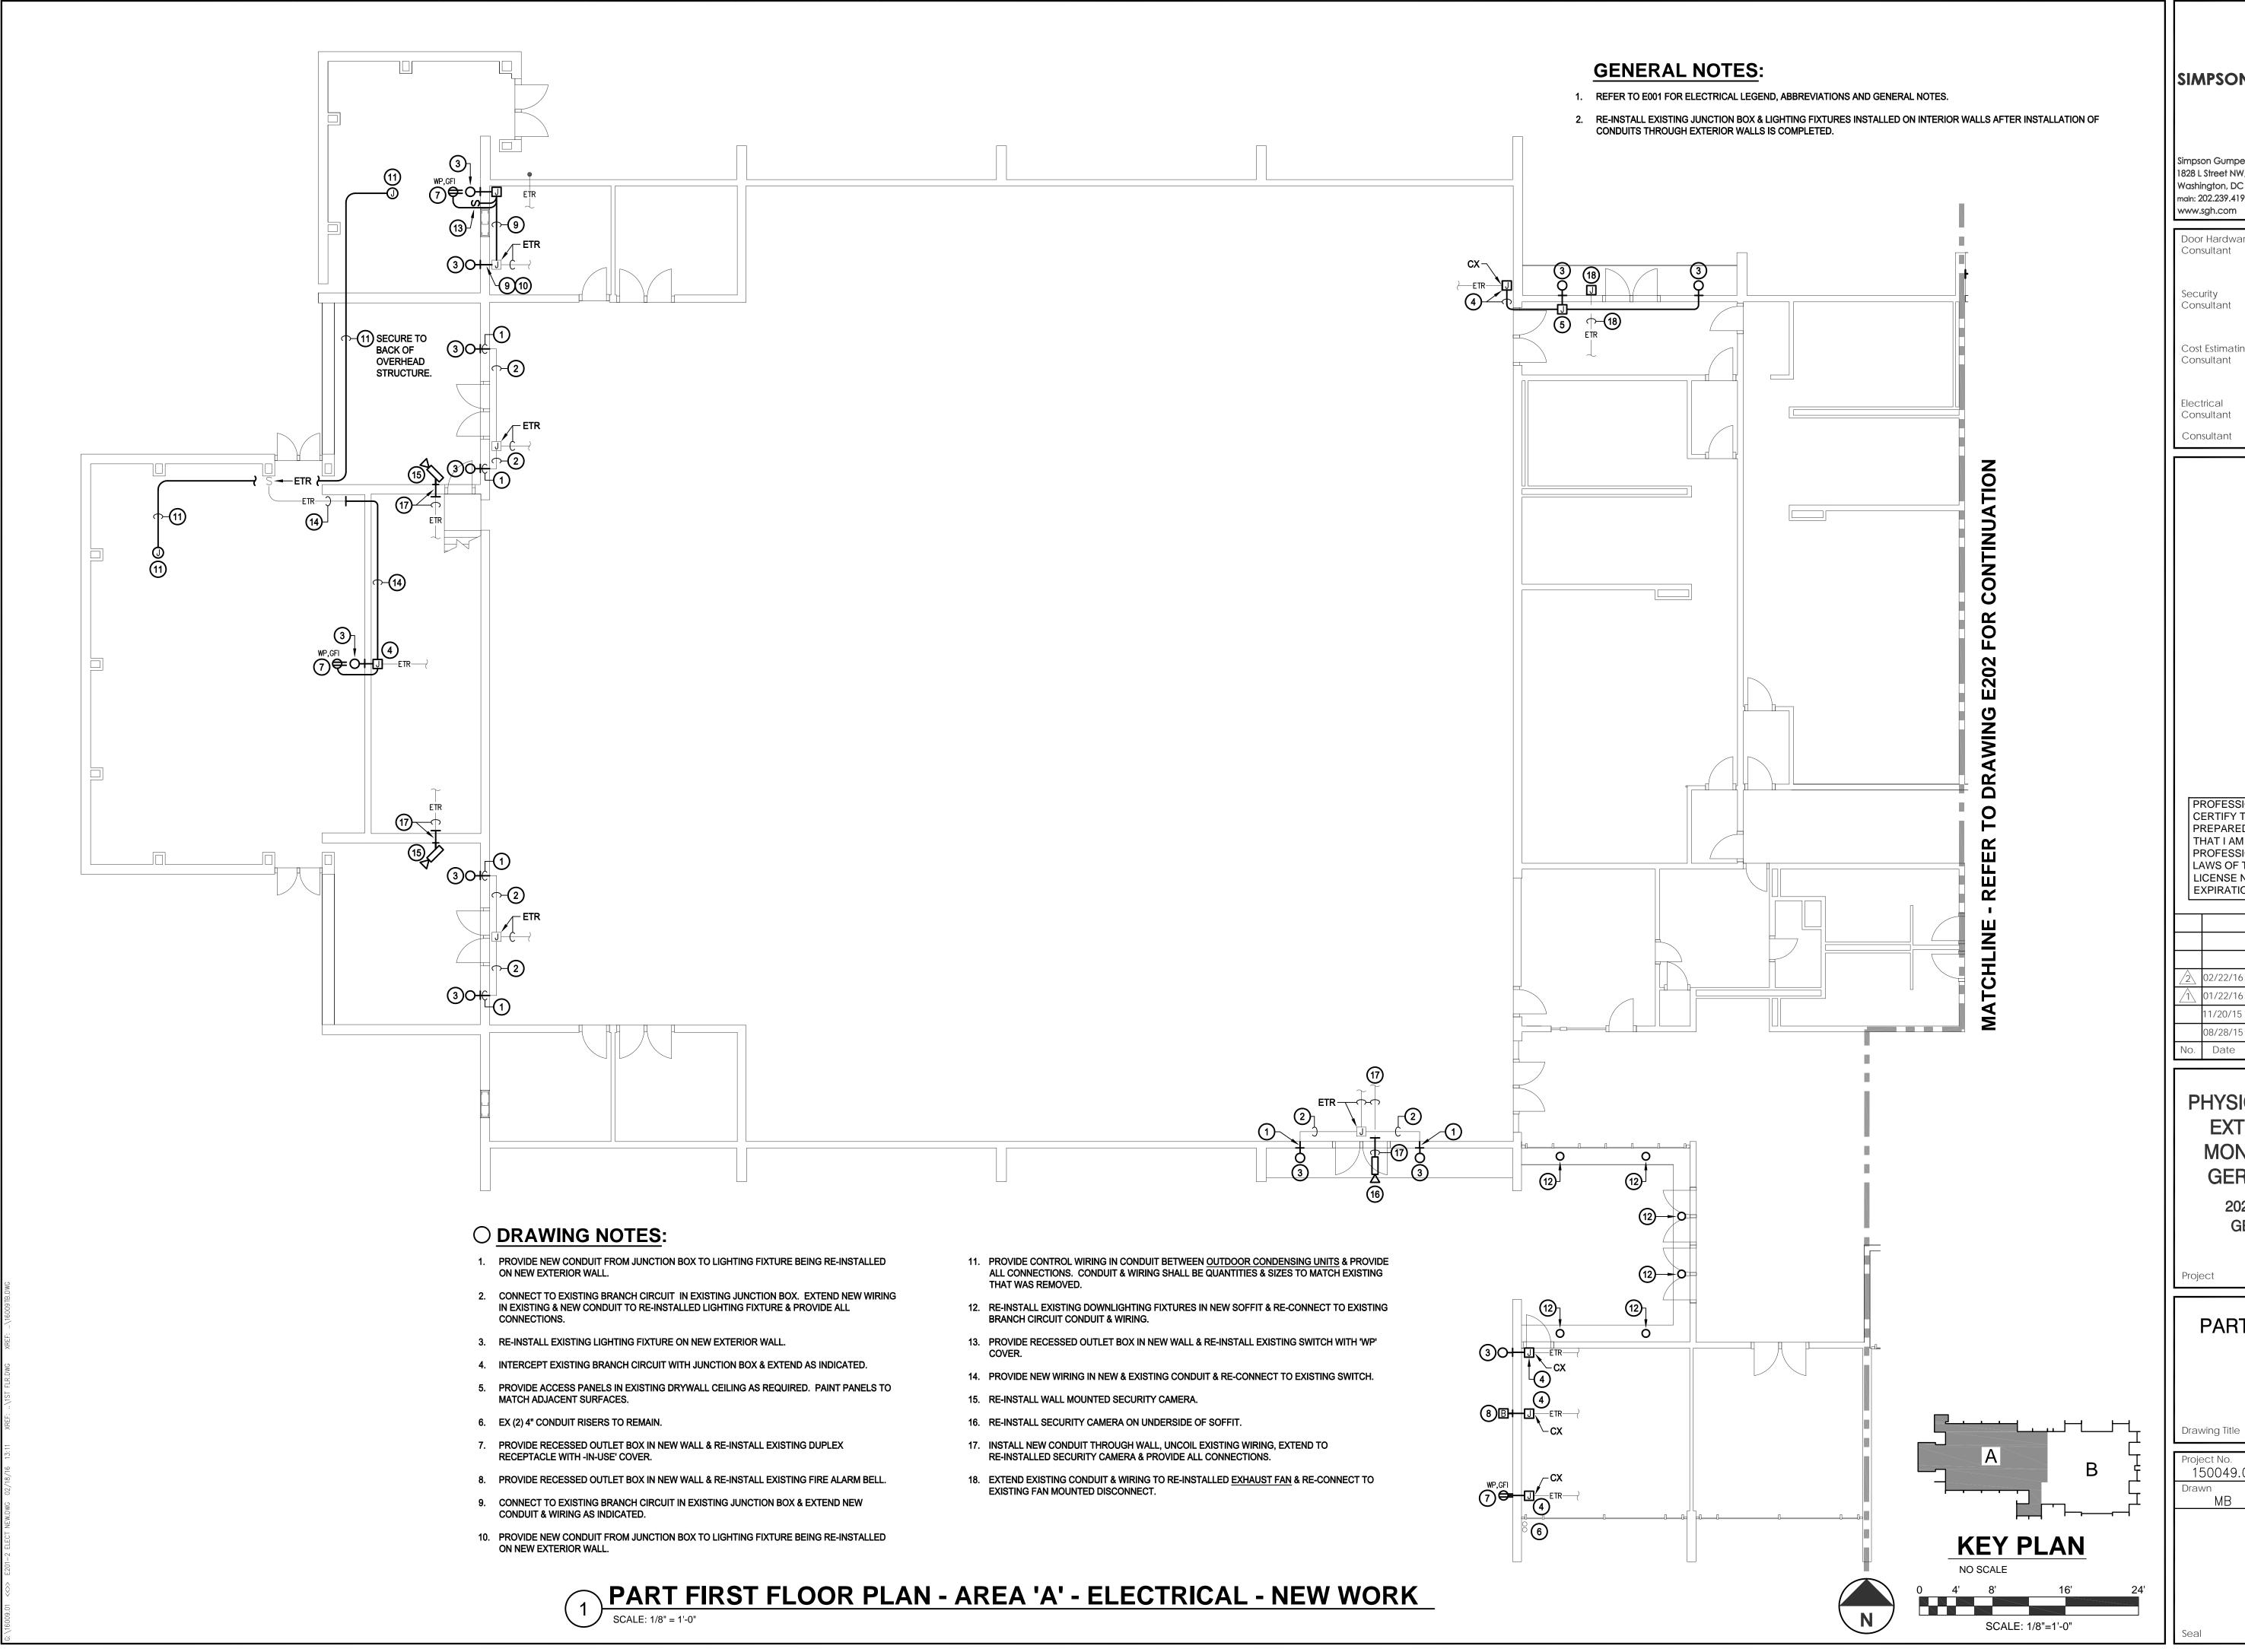
KEY PLAN

SCALE: 1/8"=1'-0"

NO SCALE


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SIMPSON GU	MPERTZ & HE	GER
	Engineering and Building	
Simpson Gumpertz & Heg 1828 L Street NW, Suite 950 Washington, DC 20036 main: 202.239.4199 fax: 202 www.sgh.com	0	Boston Chicago Los Angeles New York San Francisco Washington, DC
Door Hardware Consultant	Erbschloe Consulti 7820 Carters Run E Marshall, VA 20115	Drive
Security Consultant	540.351.0553 GHD, Inc. 14585 Avion Parkw Chantilly, VA 2015 571.325.5000	5
Cost Estimating Consultant	Forella Group, LLC 9495 Silver King Ct Fairfax, VA 22031 703.560.2200	
Electrical Consultant Consultant	bkm, Inc. 1416 Clarkview Roa Baltimore, MD 2120 410.323.0600	
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GENERAL NOTES:

1. REFER TO E001 FOR ELECTRICAL LEGEND, ABBREVIATIONS AND GENERAL NOTES.

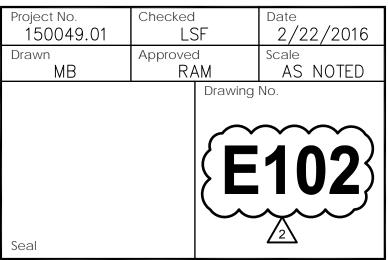2. RE-INSTALL EXISTING JUNCTION BOX & LIGHTING FIXTURES INSTALLED ON INTERIOR WALLS AFTER INSTALLATION OF CONDUITS THROUGH EXTERIOR WALLS IS COMPLETED.

3. PROVIDE EXTENSION RINGS ON EXISTING JUNCTION BOXES AS REQUIRED TO ACCOMMODATE NEW CONDUITS.

O DRAWING NOTES:

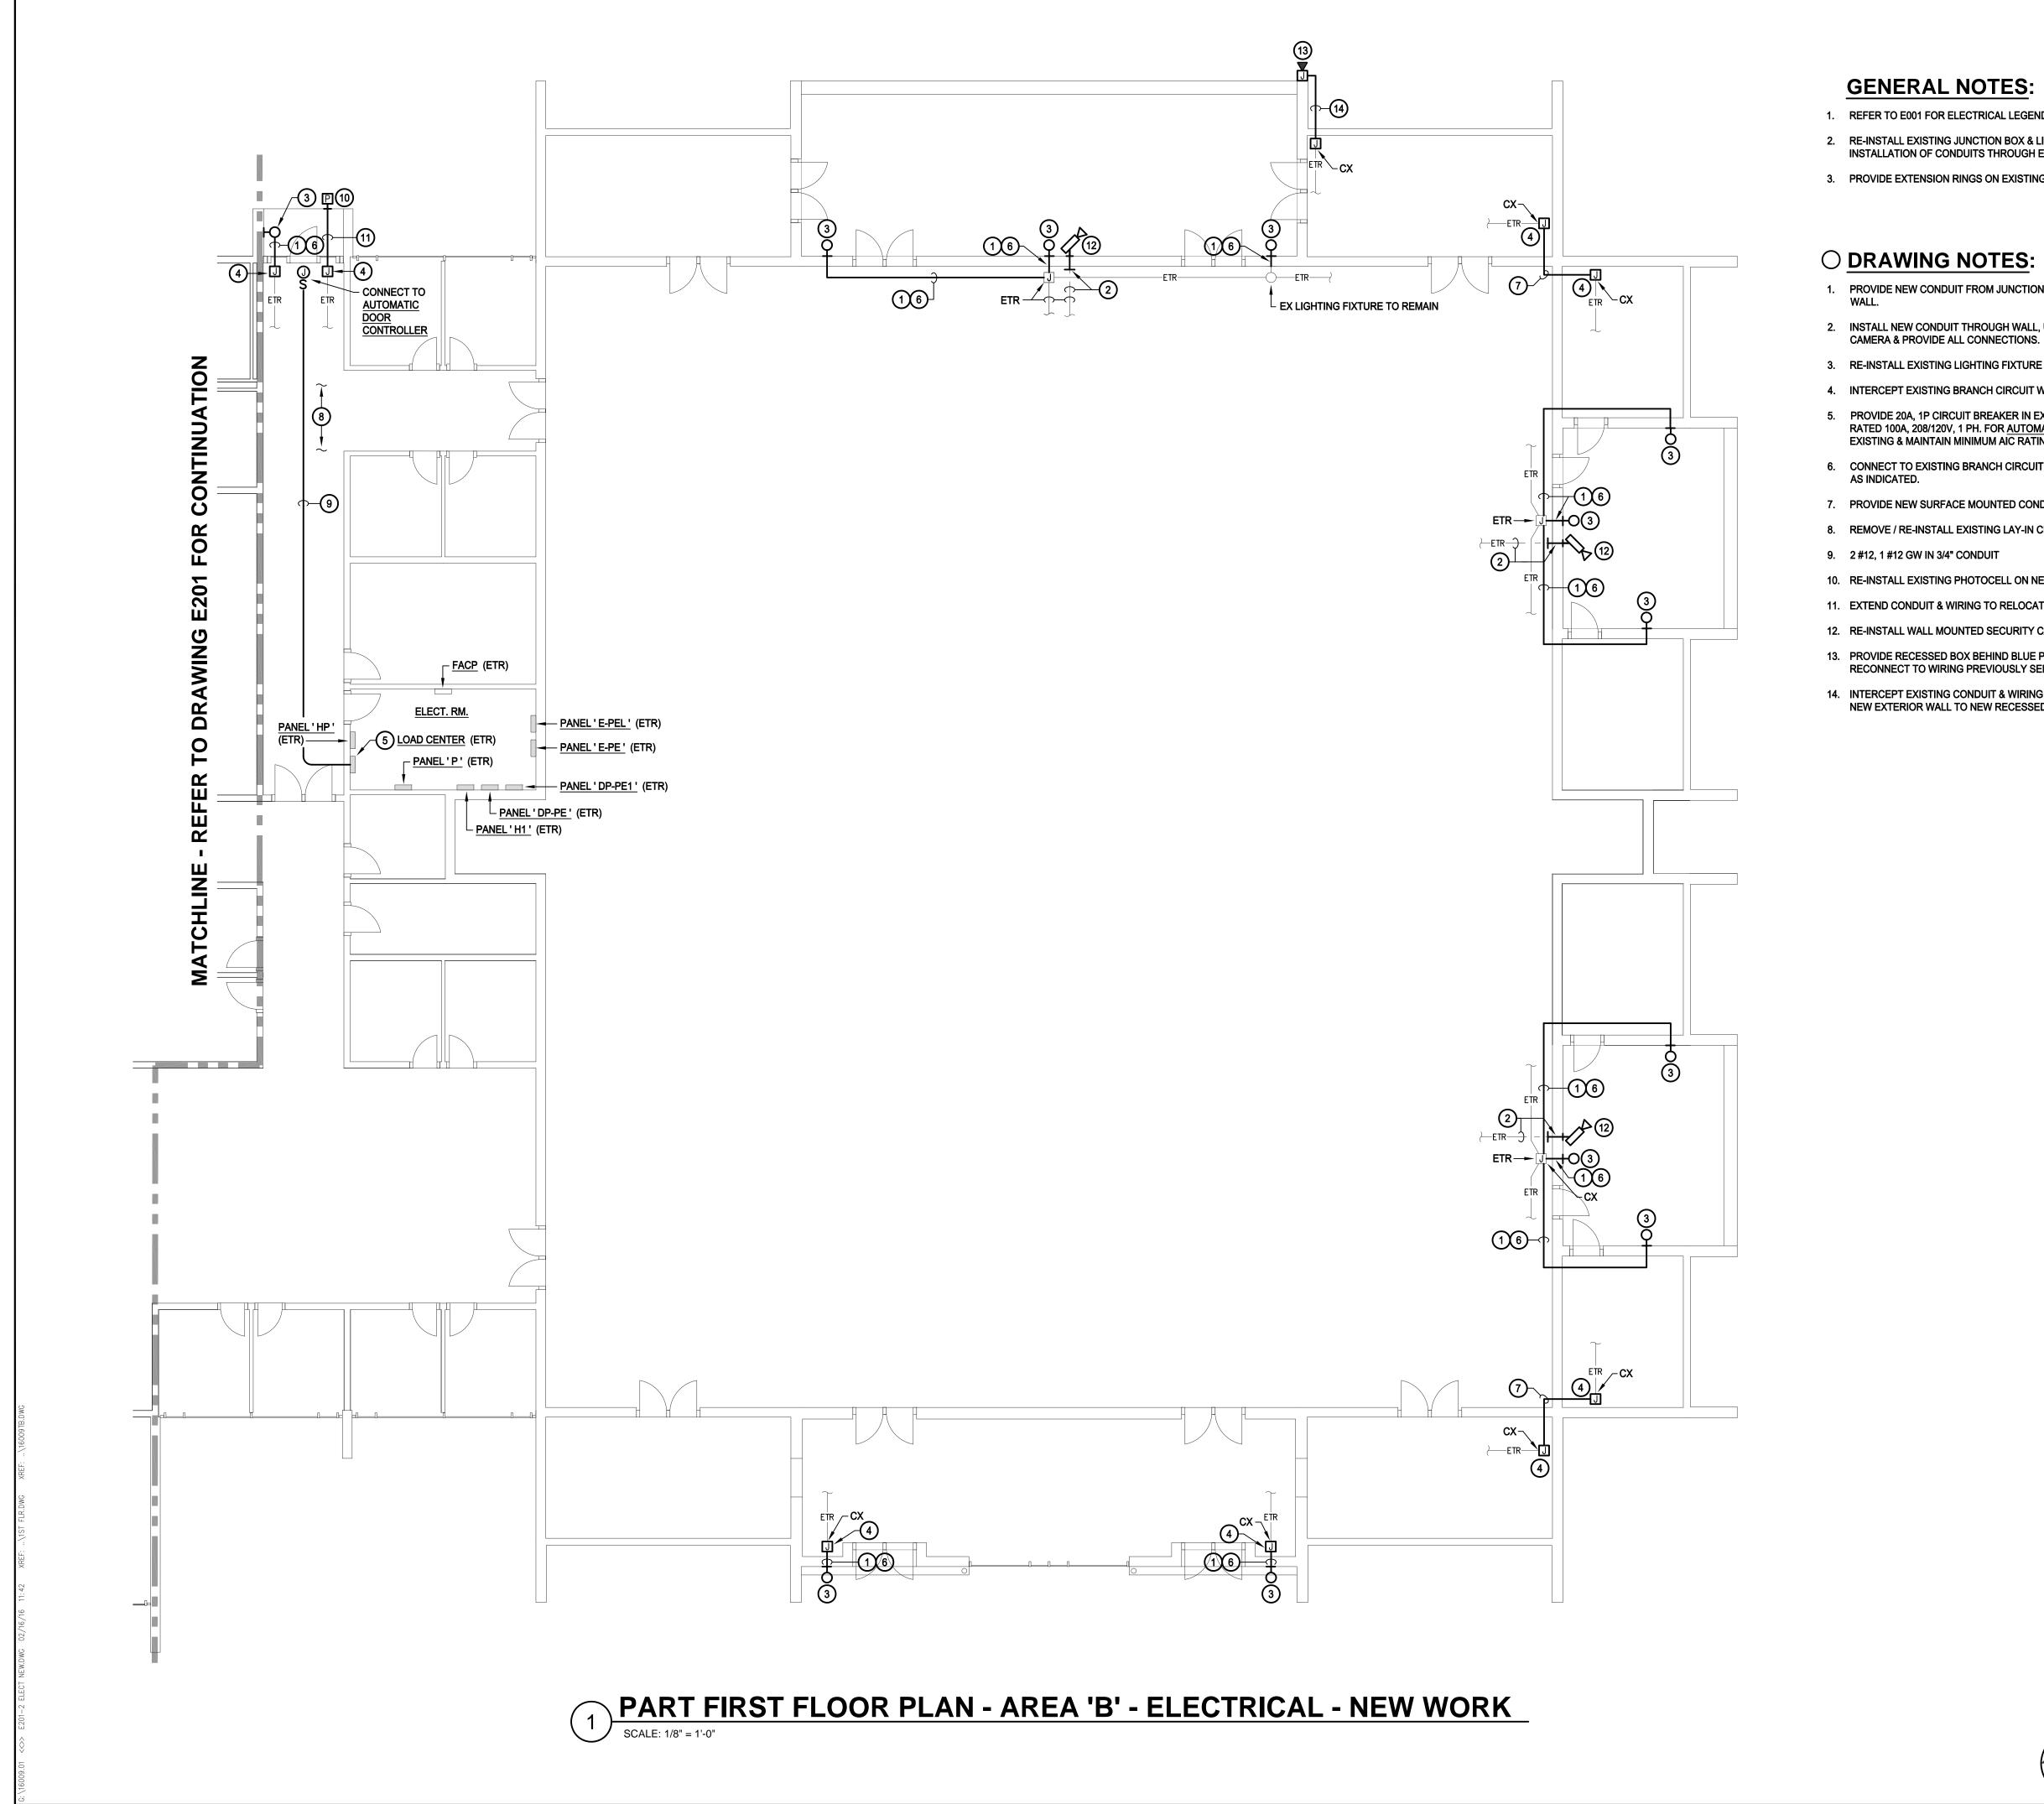1. PROVIDE NEW CONDUIT FROM JUNCTION BOX TO LIGHTING FIXTURE BEING RE-INSTALLED ON NEW EXTERIOR

2. INSTALL NEW CONDUIT THROUGH WALL, UNCOIL EXISTING WIRING, EXTEND TO RE-INSTALLED SECURITY

3. RE-INSTALL EXISTING LIGHTING FIXTURE ON NEW EXTERIOR WALL.

4. INTERCEPT EXISTING BRANCH CIRCUIT WITH JUNCTION BOX & EXTEND AS INDICATED.

PROVIDE 20A, 1P CIRCUIT BREAKER IN EXISTING SPACE #12 OF EXISTING SQUARE-D TYPE 'QO' LOAD CENTER RATED 100A, 208/120V, 1 PH. FOR <u>AUTOMATIC DOOR CONTROLLER</u>. CIRCUIT BREAKER SHALL BE TYPE TO MATCH EXISTING & MAINTAIN MINIMUM AIC RATING.

6. CONNECT TO EXISTING BRANCH CIRCUIT IN NEW OR EXISTING JUNCTION BOX & EXTEND NEW CONDUIT & WIRING

7. PROVIDE NEW SURFACE MOUNTED CONDUIT & WIRING.

8. REMOVE / RE-INSTALL EXISTING LAY-IN CEILING SYSTEM AS REQUIRED TO INSTALL NEW CONDUIT.

10. RE-INSTALL EXISTING PHOTOCELL ON NEW EXTERIOR WALL.

11. EXTEND CONDUIT & WIRING TO RELOCATED PHOTOCELL & PROVIDE ALL CONNECTIONS.

12. RE-INSTALL WALL MOUNTED SECURITY CAMERA.

13. PROVIDE RECESSED BOX BEHIND BLUE PHONE IN NEW WALL. RE-INSTALL BLUE PHONE OVER BOX & RECONNECT TO WIRING PREVIOUSLY SERVING.

14. INTERCEPT EXISTING CONDUIT & WIRING WITH NEW JUNCTION BOX & EXTEND NEW CONDUIT & WIRING BEHIND NEW EXTERIOR WALL TO NEW RECESSED BOX AS INDICATED.

В

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KEY PLAN

SCALE: 1/8"=1'-0"

NO SCALE

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SIMPSON GUMPERTZ & HEGER

Engineering of Structures and Building Enclosures

Simpson Gumpertz & H 1828 L Street NW, Suite Washington, DC 2003 main: 202.239.4199 fax: www.sgh.com	950 6	Sa	Boston Chicago .os Angeles New York n Francisco nington, DC
Door Hardware Consultant			es, Inc.
Security Consultant	GHD, Inc. 14585 Avior Chantilly, V 571.325.500		150
Cost Estimating Consultant	Forella Gro 9495 Silver Fairfax, VA 703.560.220	King Ct., Suite A 22031	
Electrical Consultant Consultant	bkm, Inc. 1416 Clarkv Baltimore, I 410.323.060	MD 21209	
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BKM# 16009.01